

Wisconsin Department of Transportation

May 7, 2024

Division of Transportation Systems Development

Bureau of Project Development 4822 Madison Yards Way, 4th Floor South Madison, WI 53705

Telephone: (608) 266-1631 Facsimile (FAX): (608) 266-8459

NOTICE TO ALL CONTRACTORS:

Proposal #02: 1071-07-79, WISC2024351

La Crosse - Sparta

(Safety Rest Area 16 Sparta Building)

IH 90

Monroe County

Letting of May 14, 2024

This is Addendum No. 01, which provides for the following:

Special Provisions:

	Revised Special Provisions
Article No.	Description
28	Site Furnishings
39	General Requirements for Building Construction
42	Rest Area Building HVAC, Item SPV.0060.13; Maintenance Building HVAC, Item SPV.0060.17
43	Rest Area Building Electrical, Item SPV.0060.14; Maintenance Building Electrical, Item SPV.0060.18

Schedule of Items:

	Added Bid Item (Quantities			
Bid Item	Item Description	Unit	Proposal Total Prior to Addendum	Quantity Added	Proposal Total After Addendum
632.0101.01	Celtis Occidentalis 'Chicagoland' Chicagoland Hackberry, 2.5" Cal, B&B	EACH	0	9	9
632.0101.02	Gleditsia Triacanthos Inermis 'Skycole' Skyline Honey Locust, 2.5" Cal, B&B	EACH	0	6	6
632.0101.03	Quercus Alba White Oak, 2.5" Cal, B&B	EACH	0	6	6
632.0101.04	Quercus Bicolor Swamp White Oak, 2.5" Cal, B&B	EACH	0	4	4
632.0201.01	Aronia Melanocarpa Var. Elataglossy Black Chokeberry, 12" Height, Cont.	EACH	0	12	12
632.0201.02	Ceanothus Americanus New Jersey Tea, 12" Height, Cont. (Revise Name)	EACH	0	18	18

632.0201.03	Dasiphora Fruticosa Bush Cinquefoil, 12" Height, Cont.	EACH	0	3	3
632.0201.04	Diervilla Lonicera Dwarf Bush Honeysuckle, 12" Height, Cont.	EACH	0	9	9
632.0201.05	Ribes Americanum American Black Currant, 12" Height, Cont.	EACH	0	14	14
632.0201.06	Symphoricarpos Albus Common Snowberry, 12" Height, Cont.	EACH	0	24	24
632.0201.07	Anaphalis Margaritacea Pearly Everlasting, DP 50, Plug	EACH	0	28	28
632.0201.08	Asclepias Tuberosa Butterfly Milkweed, DP 50, Plug	EACH	0	74	74
632.0201.09	Asclepias Verticillata Whorled Milkweed, DP 50, Plug	EACH	0	72	72
632.0201.10	Bouteloua Curtipendula Side Oats Grama, DP 50, Plug	EACH	0	48	48
632.0201.11	Bouteloua Gracilis Blue Grama Grass, DP 50, Plug	EACH	0	31	31
632.0201.12	Dalea Purpurea Purple Prairie Clover, DP 50, Plug	EACH	0	48	48
632.0201.13	Echinacea Angustifolia Narrow Leaf Coneflower, DP 50, Plug	EACH	0	50	50
632.0201.14	Fragaria Vesca Woodland Strawberry, DP 50, Plug	EACH	0	86	86
632.0201.15	Heuchera Richardsonii Prairie Alum Root, DP 50, Plug	EACH	0	92	92
632.0201.16	Monarda Fistulosa Bergamot, DP 50, Plug	EACH	0	41	41
632.0201.17	Schizachyrium Scoparium Little Bluestem, DP 50, Plug	EACH	0	31	31
632.0201.18	Sporobolus Heterolepis Prairie Dropseed, DP 50, Plug	EACH	0	39	39
632.0201.19	Symphyotrichum Sericeum Silky Aster, DP 50, Plug	EACH	0	38	38

	Deleted Bid Item	Quantities	3		
Bid Item	Item Description	Unit	Proposal Total Prior to Addendum	Proposal Quantity Change (-)	Proposal Total After Addendum
632.0101.01	Overstory Tree, 2.5" Cal, B&B	EACH	25	-25	0
632.0201.01	Shrub, 12" Height, B&B	EACH	80	-80	0
632.0201.03	Perennial, DP50, CG	EACH	678	-678	0
656.0201.01	Electrical Service Meter Breaker Pedestal (CB 100)	EACH	1	-1	0

Plan Sheets:

	Revised Plan Sheets
Plan Sheet	Plan Sheet Title (brief description of changes to sheet)
43	Revised Building Architectural Plan (G1-11) – Detail sheet added to sheet index
47	Revised Building Architectural Plan (G1-21) – Added door actuator button to code data plan and floor plan

71	Revised Building Architectural Plan (A1-31B) – Clean up tags
82-84	Revised Building Architectural Plan (A2-11 – A2-13) – Revised exterior finish schedule,
02-04	revised exterior elevation tags, revised exterior elevation names
87-91	Revised Building Architectural Plan (A3-21 – A3-31) – Revised approx. grade, revised detail
07-91	components, revised visible levels, added insulation, revised wall & base details
94	Revised Building Architectural Plan (A3-34) – Revised detail annotation
99	Revised Building Architectural Plan (A4-11) – Revised door schedule
102-103	Revised Building Architectural Plan (A4-21 – A4-22) – Revised detail annotation at window sills
107-109	Revised Building Architectural Plan (A5-11 – A5-13) – Revised spelling
105	Revised Building Architectural Plan (E2-00) – Update keynote #46. Add (2) well pump and
195	(1) sewage ejector pump locations on plan.
201	Revised Building Architectural Plan (E4-11) – Update electrical riser to have contractor refer
201	to SPV 0060.19 for electrical service requirements.
205	Revised Building Architectural Plan (E5-11) – Add (2) 40A 3-pole breakers to MDP for well
203	pumps (by others)
	Revised Building Architectural Plan (E5-14 – E5-15) – Add (1) 20A 2-pole breaker to P2 for
208-209	sewage ejector pump (by others) and add well pumps (WP-1 and WP-2) and sewage
	ejector pump (SEP-1) to schedule.
300	Miscellaneous Quantities – Remove planting table and moved to sheet 300A
305	Miscellaneous Quantities – Removed item 656.0201.01 from Lighting Control table

	Added Plan Sheets
Plan Sheet	Plan Sheet Title (brief description of why sheet was added)
97A	Building Architectural Plan (A3-38) (additional details)
300A	Miscellaneous Quantities – Revised planting table

The responsibility for notifying potential subcontractors and suppliers of these changes remains with the prime contractor.

Sincerely,

Mike Coleman

Proposal Development Specialist Proposal Management Section

ADDENDUM NO. 01

1071-07-79

May 7, 2024

Special Provisions

28. Site Furnishings.

Replace section 2.1 (c) under subsection titiled <u>Part 2 Products</u> under section titled <u>Section 32 33 00 – Site Furnishings</u> with the following:

- C. Cedar Forest Products; https://cedarforestproducts.com/
 - 1. Sales Contact: Ryan Candler, ABCreative, Phone: (515) 333-9800, Email: Ryan@ABCreative.net

Replace section 2.2 (B) (C) and (D) under subsection titiled **Part 2 Products** under section titled **Section 32 33 00 – Site Furnishings** with the following:

- B. Picnic Table.
 - 1. Manufacturer: Kay Park.
 - 2. Model: Single Post Picnic Table, Model No. 4SPTCVPN or Approved Equal.
 - a. 46" Square Top.
- C. ADA Picnic Table.
 - 1. Manufacturer: Kay Park.
 - 2. Model: Single Post Picnic Table, Model No. 4SPTCVPN-3S or Approved Equal.
 - a. 46" Square Top.
- D. Bench.
 - 1. Manufacturer: Kay Park.
 - 2. Model: 6' Stationary Bench with Back, Model No. 62SCVPN or Approved Equal.

39. General Requirements for Building Construction.

Replace section 1.1 (A) under subsection titiled <u>Part 1 General</u> under section titled <u>Section 00 31 00 – Available</u> <u>Project Information with the following:</u>

A. A copy of the geotechnical evaluation report with respect to the building site is available at the following location:

https://wisdot.box.com/s/dq18rd54chqojxffi1a635pps4cd70rg or can be accessed on the HCCI May bid letting page under Supplemental Information.

42. Rest Area Building HVAC, Item SPV.0060.13; Maintenance Building HVAC, Item SPV.0060.17.

Replace section 2.5 (A) (C) and (D) under subsection titiled Part 2 Products under section titled Section 23 21 23 – Hydronic Pumps with the following:

A. Type: Horizontal shaft, single stage, radially or horizontally split casing, for 125 psi maximum working pressure.

Delete section titled 2.6 Base-Mounted Pumps subsection titiled Part 2 Products under section titled Section 23 21 23 – Hydronic Pumps.

Add the following to section titled **2.1 Manufacturers** under subsection titled **Part 2 Products** under section titled **Section 23 81 28 – Water to Air Heat Pumps**:

U. Climatemaster: www.climatemaster.com.

Add the following to section titled **2.1 Manufacturers** under subsection titled **Part 2 Products** under section titled **Section 23 81 28 – Ground-Source Unitary Heat Pumps**:

5. Climatemaster: www.climatemaster.com.

42. Rest Area Building Electrical, Item SPV.0060.14; Maintenance Building Electrical, Item SPV.0060.18

Replace section 1.3 (E) under subsection titiled <u>Part 1 General</u> under section titled <u>Section 26 00 10 – Basic Electrical Requirements</u> with the following:

E. The Electrical Contractor is responsible for contacting the utility company and coordinating the power connection for the building service. The costs of the utility connection will be paid separately by the Department.

Add Section 28 00 00 - Video Surveillance:

Section 28 20 00 - Video Surveillance

PART 1 GENERAL

- 1.1 SECTION INCLUDES
 - A. Video surveillance system requirements.
 - B. Video recording and viewing equipment.
 - C. Cameras.
 - D. Accessories.
- 1.2 RELATED REQUIREMENTS
 - A. Section 07 84 00 Firestopping.
 - B. Section 26 05 26 Grounding and Bonding for Electrical Systems.
 - C. Section 26 05 29 Hangers and Supports for Electrical Systems.
 - D. Section 26 05 33.13 Conduit for Electrical Systems.
 - E. Section 26 05 53 Identification for Electrical Systems: Identification products and requirements.
 - F. Section 27 10 00 Structured Cabling: Data cables for IP video surveillance system network connections.
 - G. Section 28 10 00 Access Control: For interface with video surveillance system.
- 1.3 REFERENCE STANDARDS

- A. 47 CFR 15 Radio Frequency Devices; current edition.
- B. IEEE 802.3 IEEE Standard for Ethernet; 2022, with Amendments (2023).
- C. IEEE C2 National Electrical Safety Code(R) (NESC(R)); 2023.
- D. NECA 1 Standard for Good Workmanship in Electrical Construction; 2015.
- E. NECA 303 Standard for Installing and Maintaining Closed-Circuit Television (CCTV) Systems; 2019.
- F. NFPA 70 National Electrical Code; Most Recent Edition Adopted by Authority Having Jurisdiction, Including All Applicable Amendments and Supplements.

1.4 ADMINISTRATIVE REQUIREMENTS

A. Coordination:

- Coordinate the placement of cameras with structural members, ductwork, piping, equipment, luminaires, diffusers, fire suppression system components, and other potential conflicts installed under other sections or by others.
- 2. Coordinate the work with other installers to provide power for equipment at required locations.
- 3. Notify Architect of any conflicts with or deviations from Contract Documents. Obtain direction before proceeding with work.

B. Preinstallation Meetings:

- 1. Conduct meeting with facility representative to review camera and equipment locations and camera field of view objectives.
- 2. Conduct meeting with facility representative and other related equipment manufacturers to discuss video surveillance system interface requirements.

1.5 SUBMITTALS

- A. See Section 01 30 00 Administrative Requirements, for submittal procedures.
- B. Shop Drawings: Include plan views indicating locations of system components and proposed size, type, and routing of conduits and/or cables. Include elevations and details of proposed equipment arrangements. Include system interconnection schematic diagrams. Include requirements for interface with other systems.
- C. Product Data: Provide manufacturer's standard catalog pages and data sheets for each system component. Include ratings, configurations, standard wiring diagrams, dimensions, finishes, service condition requirements, and installed features.
- D. Design Data:
 - 1. Standby battery/UPS calculations.
 - 2. Video storage capacity calculations.
- E. Certify that proposed system design and components meet or exceed specified requirements.
- F. Evidence of qualifications for installer.
- G. Evidence of qualifications for maintenance contractor (if different entity from installer).
- H. Manufacturer's Installation Instructions: Indicate application conditions and limitations of use stipulated by product testing agency. Include instructions for storage, handling, protection, examination, preparation, installation, and operation of product.
- I. Manufacturer's detailed field testing procedures.
- J. Field quality control test reports.
- K. Project Record Documents: Record actual locations of system components and installed wiring arrangements and routing.
- Operation and Maintenance Data: Include detailed information on system operation, equipment programming and setup, replacement parts, and recommended maintenance procedures and intervals.

- Include contact information for entity that will be providing contract maintenance and trouble call-back service.
- M. Warranty: Submit sample of manufacturer's warranty and documentation of final executed warranty completed in Owner's name and registered with manufacturer.
- N. Maintenance contracts.
- O. Software: One copy of software not resident in read-only memory.

1.6 QUALITY ASSURANCE

- A. Comply with the following:
 - NFPA 70.
 - 2. Applicable TIA/EIA standards.
- B. Maintain at the project site a copy of each referenced document that prescribes execution requirements.
- C. Manufacturer Qualifications: Company specializing in manufacturing the products specified in this section with minimum three years documented experience.
- D. Installer Qualifications: Company specializing in performing the work of this section with minimum three years documented experience with video surveillance systems of similar size, type, and complexity and providing contract maintenance service as a regular part of their business; authorized manufacturer's representative.
 - 1. Contract maintenance office located within 100 miles of project site.
- E. Maintenance Contractor Qualifications: Same entity as installer.

1.7 DELIVERY, STORAGE, AND HANDLING

- A. Receive, inspect, handle, and store products in accordance with manufacturer's instructions and NECA 303.
- B. Store products in manufacturer's unopened packaging, keep dry and protect from damage until ready for installation.
- C. Maintain environmental conditions (temperature, humidity, and ventilation) within limits recommended by manufacturer's recommended limits.

1.8 FIELD CONDITIONS

A. Maintain field conditions within manufacturer's required service conditions during and after installation.

1.9 WARRANTY

- A. See Section 01 78 00 Closeout Submittals, for additional warranty requirements.
- B. Provide minimum five year manufacturer warranty covering repair or replacement due to defective materials or workmanship.

PART 2 PRODUCTS

2.1 MANUFACTURERS

- A. Video Recording and Viewing Equipment:
 - 1. Axis Communications: www,axis.com
 - 2. Substitutions: See Section 01 60 00 Product Requirements.

B. Cameras:

- 1. Axis Communications: www.axis.com
- 2. Substitutions: See Section 01 60 00 Product Requirements.
- C. Source Limitations: Where possible, furnish system components and accessories produced by single manufacturer and obtained from single supplier.

2.2 VIDEO SURVEILLANCE SYSTEM

A. Provide new video surveillance system consisting of all required equipment, conduit, boxes, wiring, connectors, hardware, supports, accessories, software, system programming, etc. as necessary for a complete operating system that provides the functional intent indicated.

- B. System Description: IP system with connection to network (IP) cameras.
 - 1. Video Storage Capacity: Suitable for storing video from all cameras for 30 days.
 - 2. System Battery Backup: Provide batteries/uninterruptible power supplies (UPS) as required for 20 minutes full operation.
- C. Cameras Required: Axis
 - 1. See article "CAMERAS" below for product descriptions.
 - 2. Camera 1
 - 3. Camera 2
 - a. Camera Type: Interior Fixed Dome
 - b. Camera Type: Exterior Fixed Dome
 - c. Lens Type: Furnished with camera.
 - d. Interior Mounting: Surface, CeilingTile, Or Gypsum Mounted
 - e. Mounting: Corner Mounted Bracket
 - f. Mounting: Wall Mount
 - g. Mounting: Pendant Kit
- D. Video Recording and Viewing Equipment Required:
 - See article "VIDEO RECORDING AND VIEWING EQUIPMENT" below for product descriptions.
 - 2. Equiptment located in ELECT/IT 115
 - a. NVR server.
 - b. NVR storage unit(s).
 - c. Equipment rack.
 - d. Uninterruptible power supply (UPS).
- E. Interface with Other Systems:
 - 1. Provide products compatible with other systems requiring interface with video surveillance system.
 - 2. Interface with future access control system
- F. Provide products listed, classified, and labeled as suitable for the purpose intended.
- G. Electromagnetic Interference/Radio Frequency Interference (EMI/RFI) Limits: Comply with FCC requirements of 47 CFR 15, for Class B, consumer application.

2.3 VIDEO RECORDING AND VIEWING EQUIPMENT

- A. Provide video recording and viewing equipment compatible with cameras to be connected.
- B. Network Video Recorders (NVRs):
 - 1. Supports connection of network (IP) cameras.
 - 2. Supports continuous and event-based recording.
 - 3. Network Video Recorder Type AXIS S3016:
 - a. Capacity: 16 channels.
 - b. Recording and Viewing Performance: 30 fps at 1080 resolution.
 - c. Storage Capacity: 30 TB.
 - d. Removable Media: DVD-RW, USB.
 - e. Network: Single 1 Gigabit Ethernet.
 - f. Features:
 - (1) Supports remote access via axis camera station
 - (2) Desktop
 - (3) Mobile

C. Computers:

- Workstation Computers: Unless otherwise indicated, workstation computer to be furnished by owner. Video surveillance system to be provided by Contractor as part of work of this section, meeting video surveillance system equipment manufacturer's minimum requirements.
- 2. Servers: Unless otherwise indicated, server hardware not furnished by video surveillance system manufacturer to be provided by Contractor as part of work of this section, video surveillance system equipment meeting manufacturer's minimum requirements.

D. Software:

- 1. Unless otherwise indicated, provide all software and licenses required for fully operational system.
- 2. Video Management System:
 - a. Axis Camera Station

2.4 CAMERAS

- A. Provide cameras and associated accessories suitable for operation under the service conditions at the installed location. Provide additional components (e.g. enclosures, Seal Tight, Fittings, heaters, blowers, etc.) as required.
- B. Where not factory-installed, provide additional components (e.g. lenses, mounting accessories, etc.) as necessary for complete installation.
- C. Network (IP) Cameras:
 - 1. Signal-to-Noise Ratio: Not less than 50 dB.
 - 2. Provide the following standard features:
 - a. Automatic electronic shutter.
 - b. Automatic gain control.
 - c. Automatic white balance.
 - d. Web-based interface for remote viewing and setup.
 - e. Password protected security access.
 - Network (IP) Fixed Dome Panoramic Camera P-3727-PLE 4X2 MP MULTIDIRECTIONAL CAMERA WITH IR FOR 360 COVERAGE; www.axis.com/#sle.
 - a. Maximum Video Resolution: 1920X1080.
 - b. Maximum Frame Rate: 25/30 FPS AT 50/60HZ
 - c. Image Sensor Size: 4X1/2.8
 - d. Minimum Illumination/Light Sensitivity (Color): 17 lux.
 - e. Lens: F1.8-2.6 VARIFOCAL
 - f. Features: Zipstream, forensic capture wide dynamic range, local storage, Power over Ethernet (PoE), day and night functionality, built-in IR illumination.
 - 4. Network (IP) Fixed Dome 180 Degree Basis of Design: Axis Communications M3066-V www.axis.com/#sle.
 - a. Maximum Video Resolution: 2304 x 1728.
 - b. Maximum Frame Rate: 25/30 fps at 50/60 Hz.
 - c. Image Sensor Size: 1 x 1.25 inch.
 - d. Minimum Illumination/Light Sensitivity (Color): 0.23 lux.
 - e. Lens: 2.4 MM F2.1 Horizontal Field Of View 131Degrees.
 - f. Features: Forensic capture wide dynamic range, Zipstream, Power over Ethernet (PoE), day and night functionalit

2.5 ACCESSORIES

- A. Camera Enclosures: Where not factory-installed, provide camera enclosures suitable for operation under service conditions at installed location.
- B. Camera Mounting Supports: Where not factory installed, provide mounting supports necessary for installation.
 - 1. Products:AXIS T91A64 CORNER BRACKET
 - AXIS T91D61 WALL MOUNT
 - AXIS T94N01D PENDENT KIT
 - a. Substitutions: See Section 01 60 00 Product Requirements.
- C. Provide components as indicated or as required for connection of video surveillance system to devices and other systems indicated.
- D. Provide components as indicated or as required for system power and network connections.
- E. Provide cables as indicated or as required for connections between system components.
 - 1. Data Cables for IP Network Connections: Unshielded twisted pair (UTP), minimum Category 5e, complying with Section 27 10 00.
- F. Provide accessory racks/cabinets as indicated or as required for equipment mounting.

PART 3 EXECUTION

3.1 EXAMINATION

- A. Verify that field measurements are as indicated.
- B. Verify that ratings and configurations of system components are consistent with the indicated requirements.
- C. Verify that mounting surfaces are ready to receive system components.
- D. Verify that branch circuit wiring installation is completed, tested, and ready for connection to system where applicable.
- E. Verify that conditions are satisfactory for installation prior to starting work.

3.2 INSTALLATION

- A. Install video surveillance system in accordance with NECA 1 (general workmanship) and NECA 303.
 - B. Install products in accordance with manufacturer's instructions.
 - C. Provide required support and attachment in accordance with Section 26 05 29.
 - D. Wiring Method: Unless otherwise indicated, use cables (not in conduit).
 - 1. Use suitable listed cables in wet locations, including underground raceways.
 - 2. Use suitable listed cables for vertical riser applications.
 - 3. Use listed plenum rated cables in spaces used for environmental air.
 - 4. Install wiring in conduit for the following:
 - a. Where required for rough-in.
 - b. Where required by authorities having jurisdiction.
 - c. Where exposed to damage.
 - d. Where installed outside the building.
 - e. For exposed connections from outlet boxes to cameras.
 - 5. Conduit: Comply with Section 26 05 33.13.
 - 6. Conceal all cables unless specifically indicated to be exposed.
 - 7. Cables in the following areas may be exposed, unless otherwise indicated:
 - a. Equipment closets.
 - b. Within joists in areas with no ceiling.
 - 8. Route exposed cables parallel or perpendicular to building structural members and

surfaces.

- Include service loop cable lengths to allow relocation of cameras within 30 ft of installed location.
- E. Provide grounding and bonding in accordance with Section 26 05 26.
- F. Install firestopping to preserve fire resistance rating of partitions and other elements, using materials and methods specified in Section 07 84 00.
- G. Identify system wiring and components in accordance with Section 26 05 53.

3.3 FIELD QUALITY CONTROL

- A. See Section 01 40 00 Quality Requirements, for additional requirements.
- B. Provide services of a manufacturer's authorized representative to observe installation and assist in inspection and testing. Include manufacturer's detailed testing procedures and field reports with submittals.
- C. Prepare and start system in accordance with manufacturer's instructions.
- D. Adjust cameras to provide desired field of view and produce suitable images under all service lighting conditions.
- E. Program system parameters according to requirements of Owner.
- F. Test for proper interface with other systems.
- G. Correct defective work, adjust for proper operation, and retest until entire system complies with Contract Documents.
- H. Submit detailed reports indicating inspection and testing results and corrective actions taken.

3.4 COMPONENT RIGGING

- A. At all time shall the contractor engage in safe rigging practices to mount, fasten, and attach spacific electronic components and associated hardware.
- B. All hardware should be hardend steel forged designed for and implemented utilizing manufactures recomended spacific work load limits. Fasteners shall be grad 5 or better in all cases except where detailed.

3.5 CLEANING

A. Contractor is responsible for keeping the job site clean and remove all trash at the end of each day. The contractor must cooperate with building officals to keep disruption to the jobsite to a minimum, and shall be responsible for all damages caused by installation.

3.6 LABELING

- A. All cables, patch panels, biscuits shall be permanently labeled in a neat fashion specific to location. Acceptable methods include:
 - 1. Brother P-touch {Laminate Type}
 - 2. Dymo Laminate Type
 - Lamacoid Engraved Labels

3.7 OWNER INSTRUCTION

- A. Schedule at least 14 days in advance of owner's intended first use of the system, a training session with the owner and opperating personnel. Opperating training should include the following.
 - 1. Overview of operation including power up and power down procedures.
 - 2. Demonstration on software {Recording and playback}
 - 3. Question and anwser session.
- B. Training shall be documented and completion shall be reported to the architect.
- C. The owner may request as many as two additional training sessions at no additional expense to the owner.

3.8 CLOSEOUT ACTIVITIES

A. See Section 01 78 00 - Closeout Submittals, for closeout submittals.

- B. See Section 01 79 00 Demonstration and Training, for additional requirements.
- C. Demonstration: Demonstrate proper operation of system to Owner, and correct deficiencies or make adjustments as directed.
- D. Verification that all cameras have the most recent firmwareversion installed.
- E. Training: Train Owner's personnel on operation, adjustment, and maintenance of system.
 - 1. Use operation and maintenance manual as training reference, supplemented with additional training materials as required.
 - 2. Provide minimum of four hours of training.
 - 3. Instructor: Manufacturer's authorized representative.
 - 4. Location: At project site.
- F. Owner shall have total turn-key system complete and functional, consistant with the manufacturer's specifications.

3.9 PROTECTION

A. Protect installed system components from subsequent construction operations.

3.10 MAINTENANCE

- A. See Section 01 70 00 Execution and Closeout Requirements, for additional requirements relating to maintenance service.
- B. Provide to Owner, a proposal as an alternate to the base bid, a separate maintenance contract for the service and maintenance of video surveillance system for five years from date of Substantial Completion; Include a complete description of preventive maintenance, systematic examination, adjustment, cleaning, inspection, and testing, with a detailed schedule.
- C. Provide trouble call-back service upon notification by Owner:
 - Include allowance for call-back service during normal working hours at no extra cost to Owner.
 - 2. Owner will pay for call-back service outside of normal working hours on an hourly basis, based on actual time spent at site and not including travel time; include hourly rate and definition of normal working hours in maintenance contract.

END OF SECTION

Schedule of Items

Attached, dated May 7, 2024, are the revised Schedule of Items Pages 1 – 12.

Plan Sheets

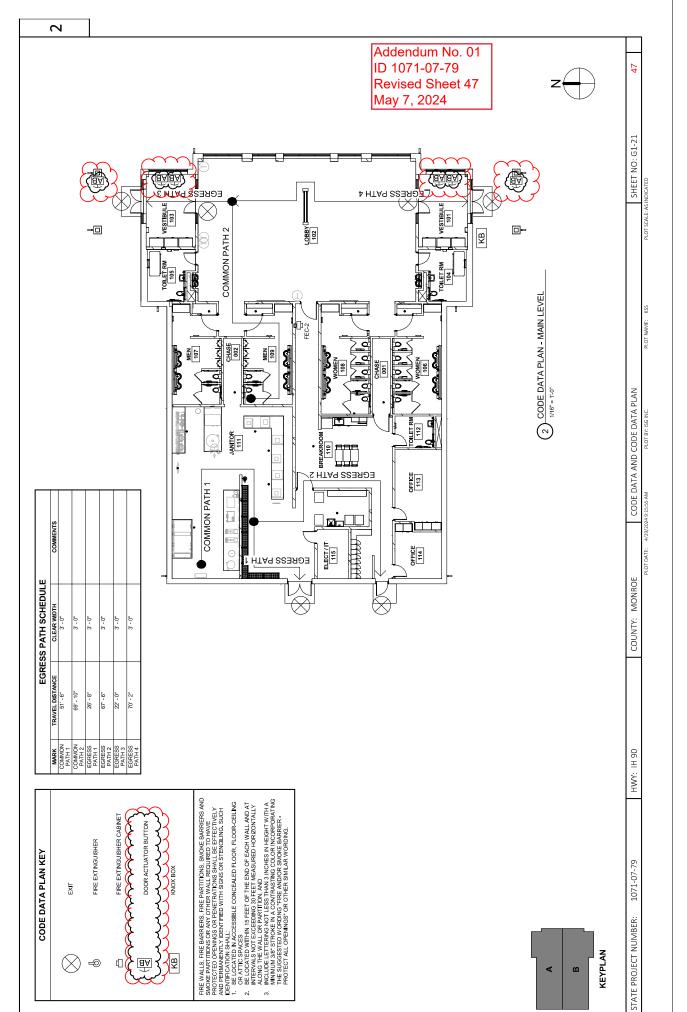
The following $8\frac{1}{2}$ x 11-inch sheets are attached and made part of the plans for this proposal:

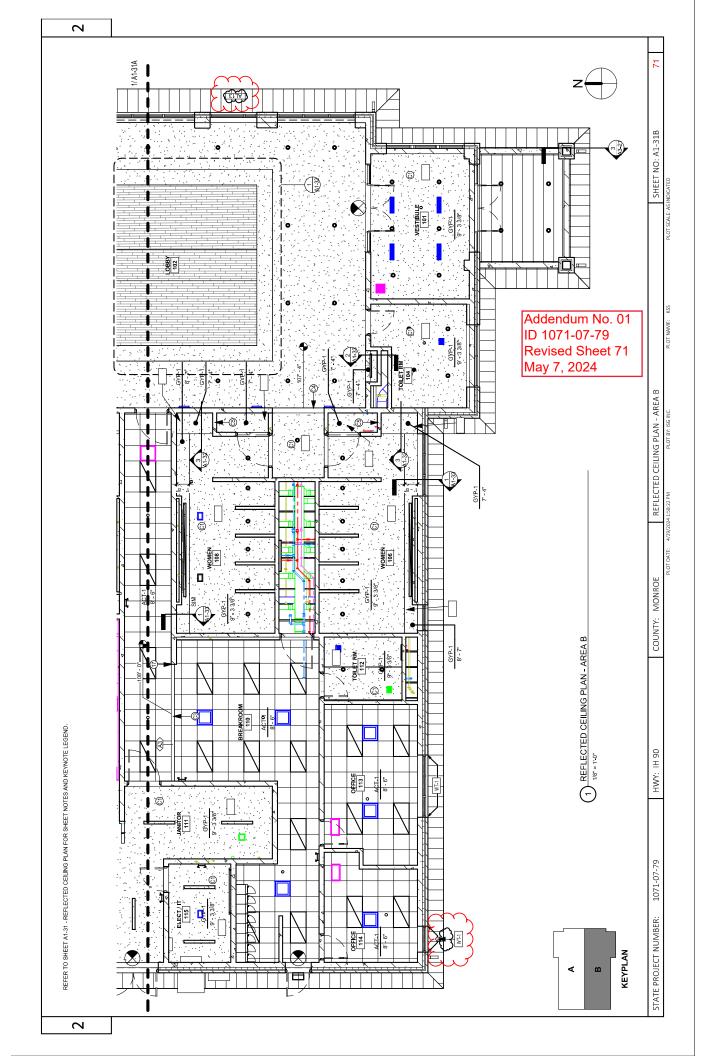
Revised: 43, 47, 71, 82-84, 87-91, 94, 99, 102-103, 107-109, 195, 201, 205, 208-209, 300 and 305.

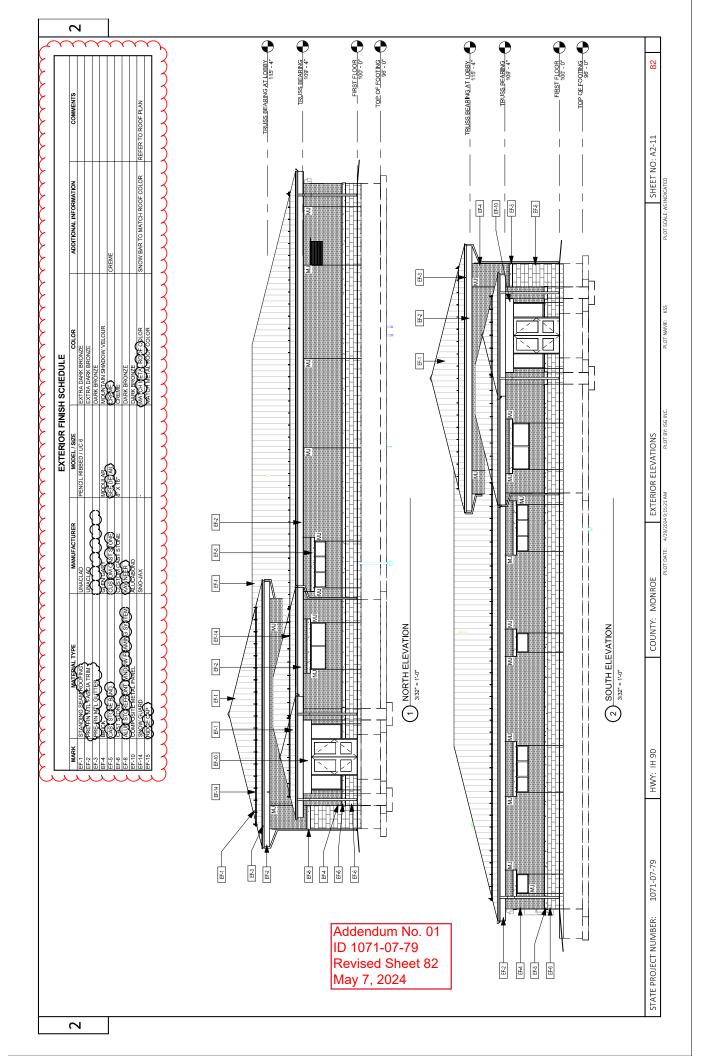
Added: 97A and 300A.

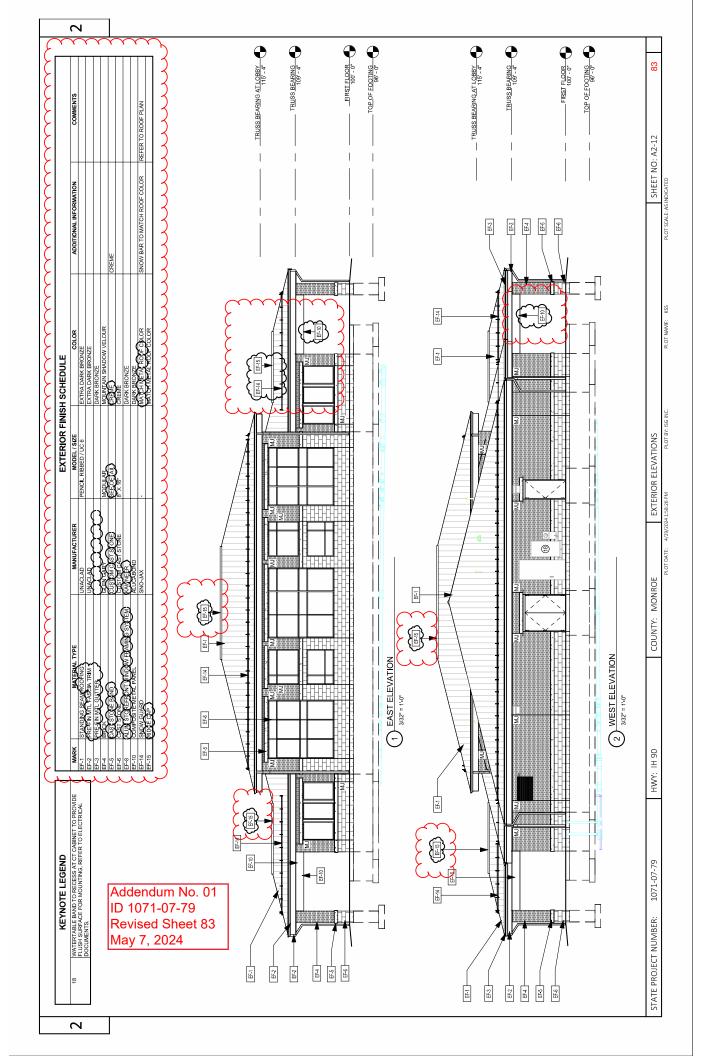
END OF ADDENDUM

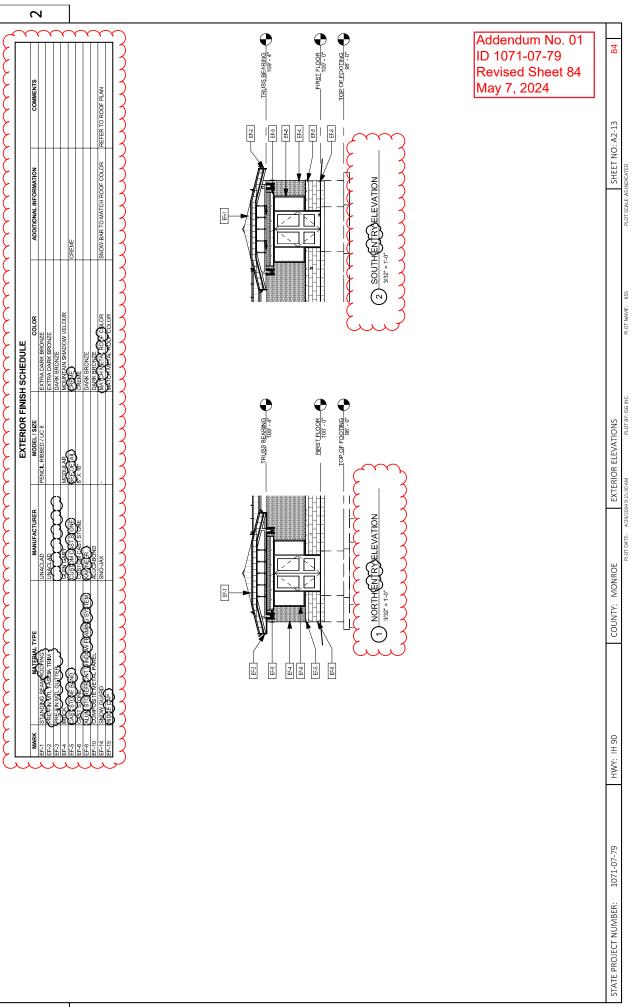
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MAINTENANCE BUILDING	SHEET	SHEET # SHEET TITLE	GENERAL C C 4 34 CODE DATA AND CODE DATA BLAN	CODE DATA AND CODE DATA	¥,	G-A1-21 FLOOR PLAN		G-A3-11 BUILDING SECTIONS		G-A3-24 DETAILS		STRICTIBAL	. 1	G-S1-01 STRUCTURAL NOTES		IBC STRUCTURAL FASTENING	2 50	П	G-S2-11 FOUNDATION & SLAB DETAILS	G-S2-13 FOUNDATION & SLAB DETAILS		Т	1 1	G-S4-11 ROOF FRAMING PLAN SHEAR WALL PLAN	G-S6-11 WALL FRAMING DETAILS G-SG-21 PROPE PRAMING DETAILS				G-P2-11 FIRST FLOOR SANITARY PLUMBING PLAN - MAINTENANCE BILLI DING	G-P2-21 FIRST FLOOR POTABLE WATER PLUMBING PLAN	MAIN EIVANCE BUILDING	MECHANICAL G-M2-41 FIRST FLOOR HVAC PLAN - MAINTENANCE BHILDING	1	ELECTRICAL G-E2-13 MAINTENANCE SHED ELECTRICAL PLAN	NO DIMICULA	G-T2-13 MAINTENANCE SHED TECHNOLOGY PLAN					The state of the s		を行うというと	Posterior / Change / /	HITCHEST AND A STATE OF THE STA				SHEET NO: G1-11 43	PLOT SCALE: AS INDICATED
	SHEET	SHEET# SHEET TITLE	4	MC-01 MECHANICAL CODE DATA MO-01 MECHANICAL CODE DATA		M2-21 FIRST FLOOR HYDRONIC PLAN - OVERALL	M2-21A FIRST FLOOR HYDRONIC PLAN - AREA A M2-21R FIRST FLOOR HYDRONIC PLAN - AREA R	M3-11 HVAC SECTIONS		M4-12 HVAC DETAILS		M4-21 HYDRONIC DETAILS M4-22 HYDRONIC DETAILS	Ш	M4-24 HYDRONIC DETAILS M4 25 HYDRONIC DETAILS	M4-26 HYDRONIC DETAILS M4-26 HYDRONIC DETAILS				M6-11 HVAC CONTROLS		M6-21 HYDRONIC CONTROLS M6-22 HYDRONIC CONTROLS		ELECTRICAL	E2-01 OVERALL MAIN BUILDING ELECTRICAL PLAN		E2-21A MAIN BUILDING LIGHTING PLAN - AREA A	E2-218 MAIN BUILDING LIGHTING PLAN - AREA B		E4-13 ELECTRICAL DETAILS	E5-14 ELECTRICAL SYMBOLS LEGEND E5-11 ELECTRICAL PANEL SCHEDULES	E5-12 ELECTRICAL PANEL SCHEDULES		9	E5-17 LIGHTING SCHEDULES	- 1	TECHNOLOGY TO GO MANN BITTE DING TECHNOLOGY BLAN		T4-12 TECHNOLOGY DETAILS TE-11 TECHNOLOGY PISER DIAGRAMS		T5-13 TECHNOLOGY RISER DIAGRAMS DATA T6-11 TECHNOLOGY SCHEDLILES									SHEET INDEX	PLOT DATE: 4/29/2024 9-15-52 AM PLOT BY: ISG INC PLOT NAME: KSS
SPARTA REST AREA NO. 16	SHEET	SHEET# SHEET TITLE	INTERIOR ELEVATIONS	A6-13 INTERIOR ELEVATIONS A6-16 INTERIOR ELEVATIONS			甘	S1-01 STRUCTURAL NOTES		S1-05 REQUIRED INSPECTIONS			ш		S2-12 FOUNDATION & SLAB DETAILS	ш							CMU DETAILS		S6-15 CMU DETAILS			PMC-DANICAL MECHANICAL GENERAL NOTES		PLUMBING LEGEND		FIRST FLOOR SANITARY PLUMBING	P2-11B FIRST FLOOR SANITARY PLUMBING PLAN - AREA B P2-21A FIRST FLOOR POTABLE WATER PLUMBING PLAN - AREA A	P2-21B FIRST FLOOR POTABLE WATER PLUMBING PLAN - AREA B	POTABLE WATER ISOMETRICS	PLUMBING ISOMETRICS			PLUMBING SCHEDULES AND SPECIFI		Ad ID	lde 10	end 07	du 1-(m)7. Sh	No -79	o. 0)1	NOON	
	SHEET	SHEET# SHEET TITLE				G1-21 CODE DATA AND CODE DATA PLAN		LANDSCAPE		C0-24 PICNIC SHELTER DETAILS		C3-20 SITE RESTORATION PLAN	ш		ARCHITECTURAL	A1-01 WALL TYPES						Τ			A1-33 CEILING DETAILS A1-41A FINISH PI AN ABEA A	A1-41B FINSH PLAN - AREA B	Ш		ш				A3-12 BUILDING SECTION A3-12 BUILDING SECTION	WAL			A3-32 MASONRY WALL DETAILS			A327 DETAILS	$\langle $			A4-22 WINDOW DETAILS A4-23 WINDOW & DOOR DETAILS		П	Ab-12	A6-12 INTERIOR ELEVATIONS A6-13 INTERIOR ELEVATIONS	STATE PROJECT NUMBER: 1071-07-79 HWY: IH 90	

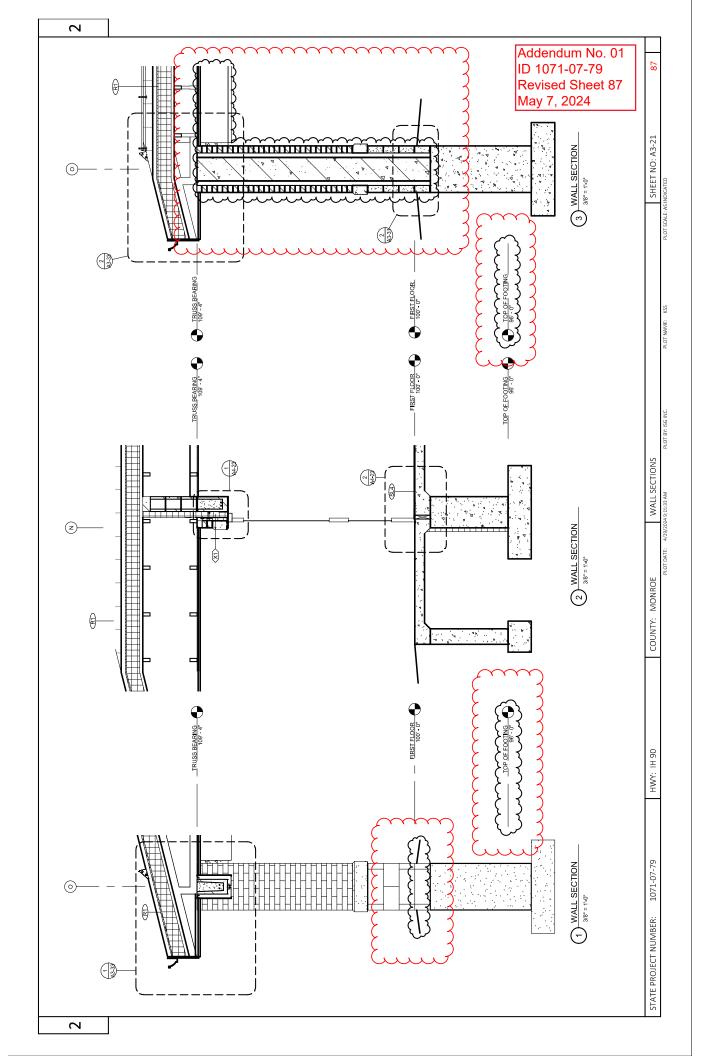


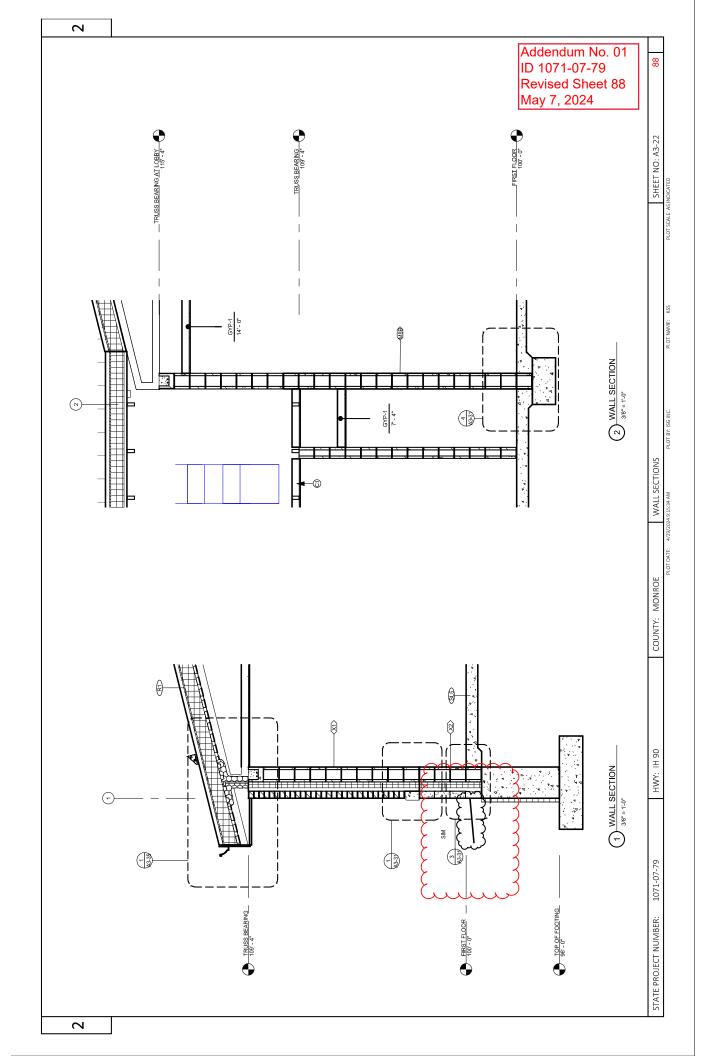


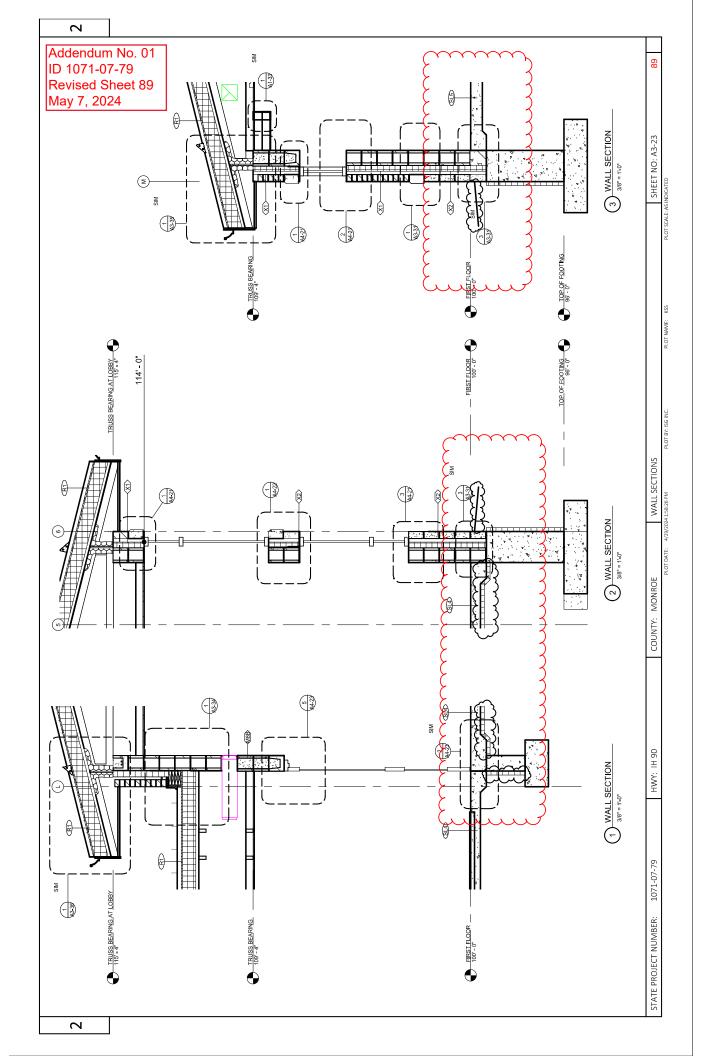


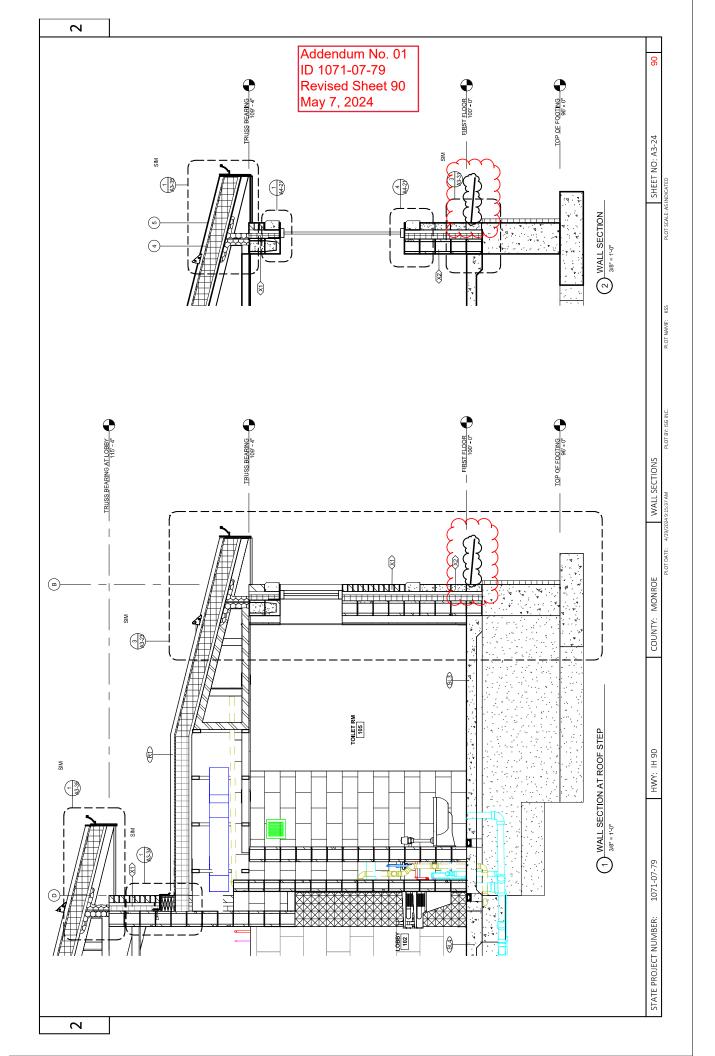


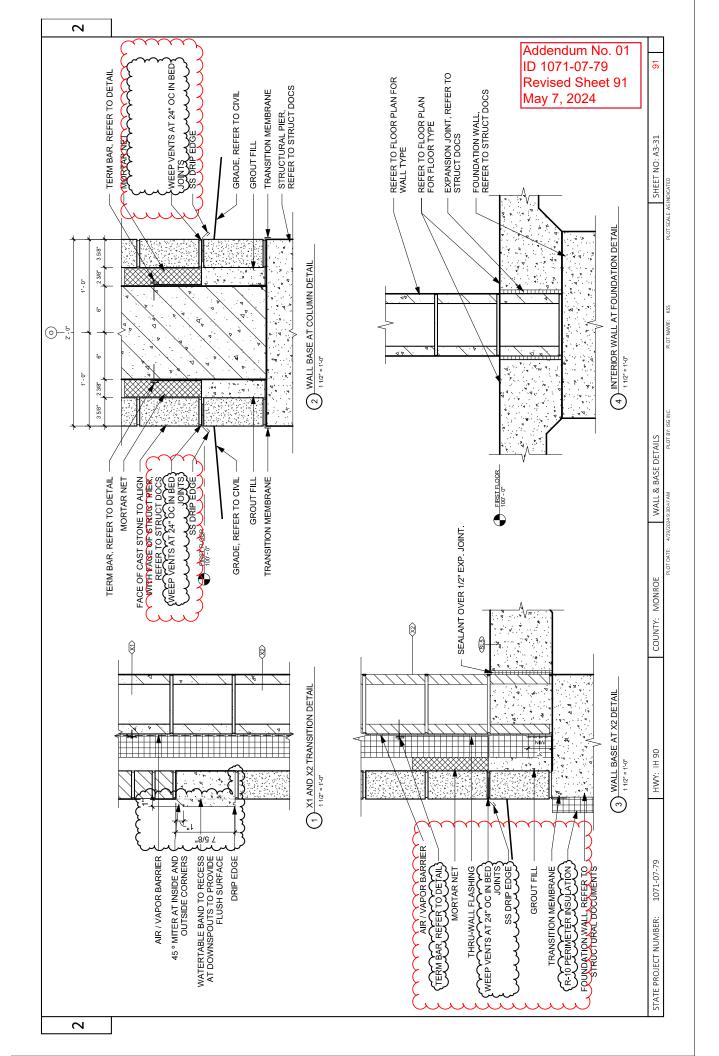


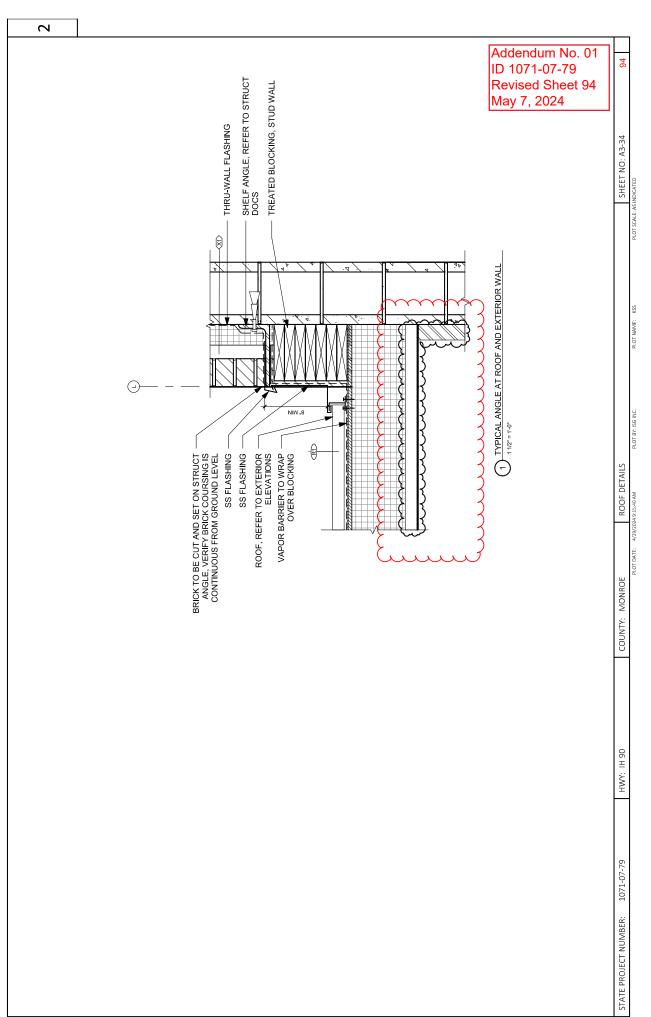


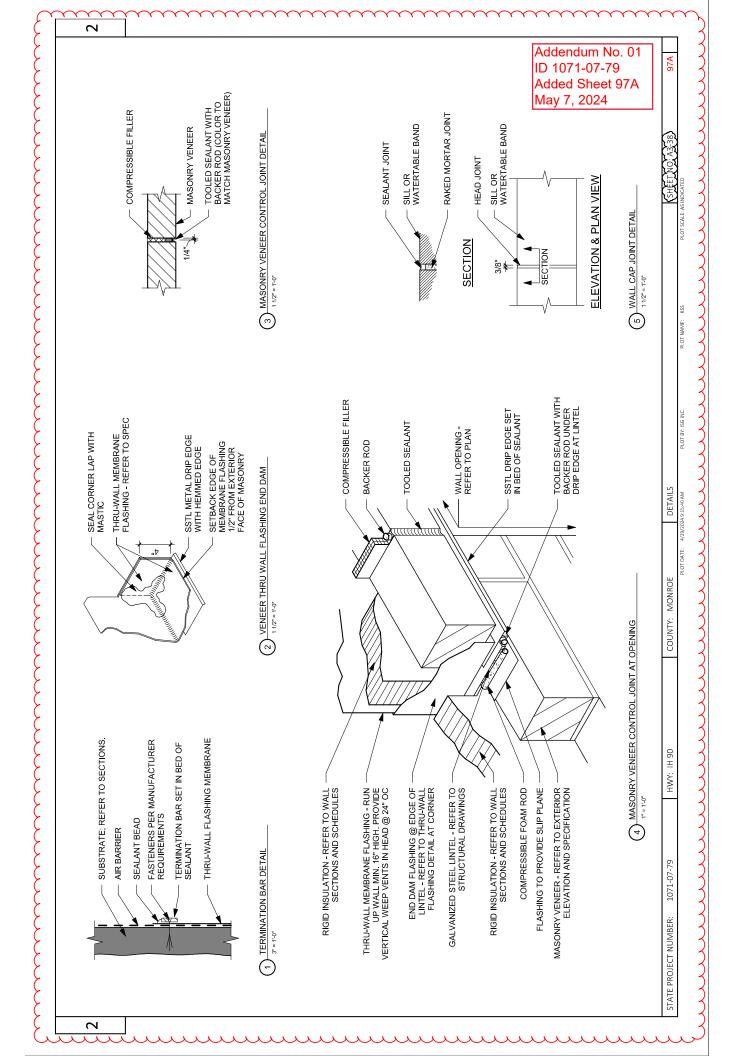


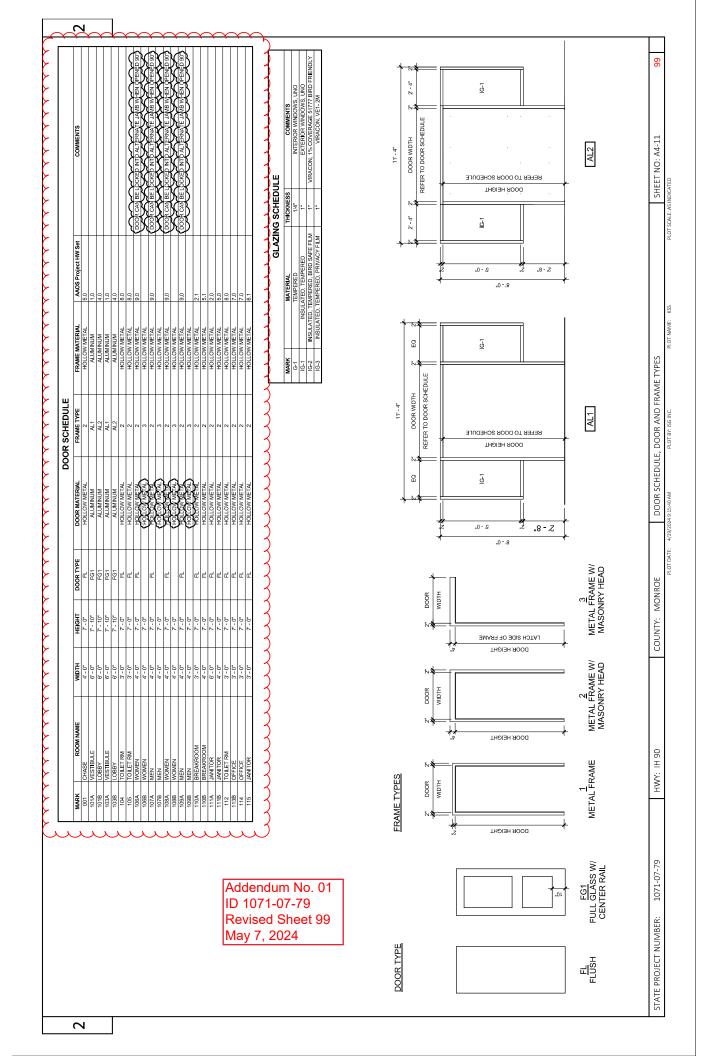


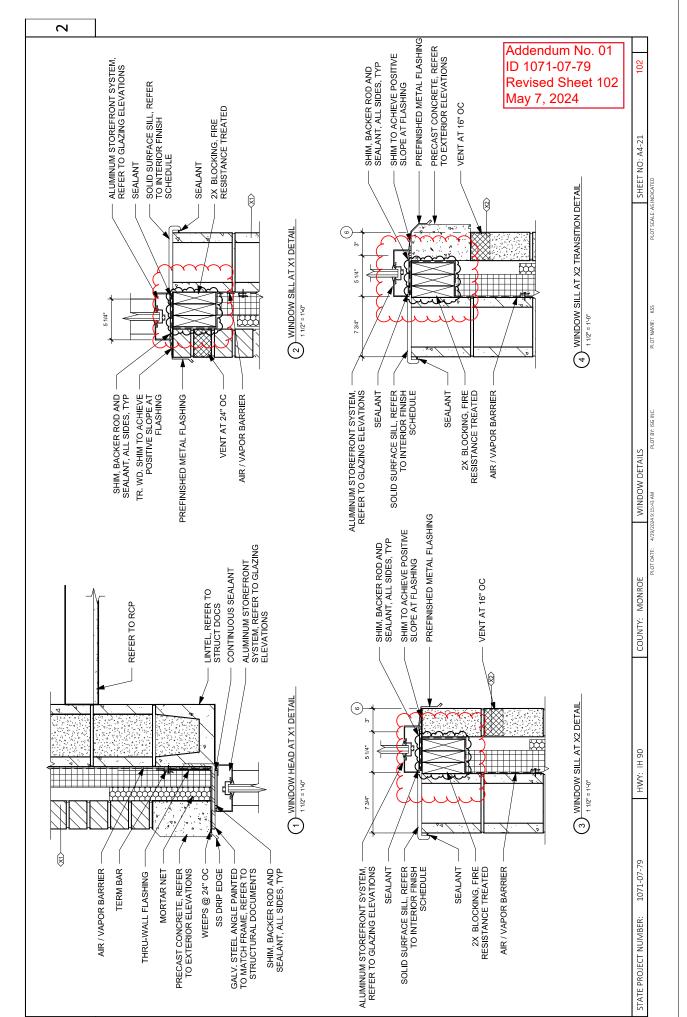




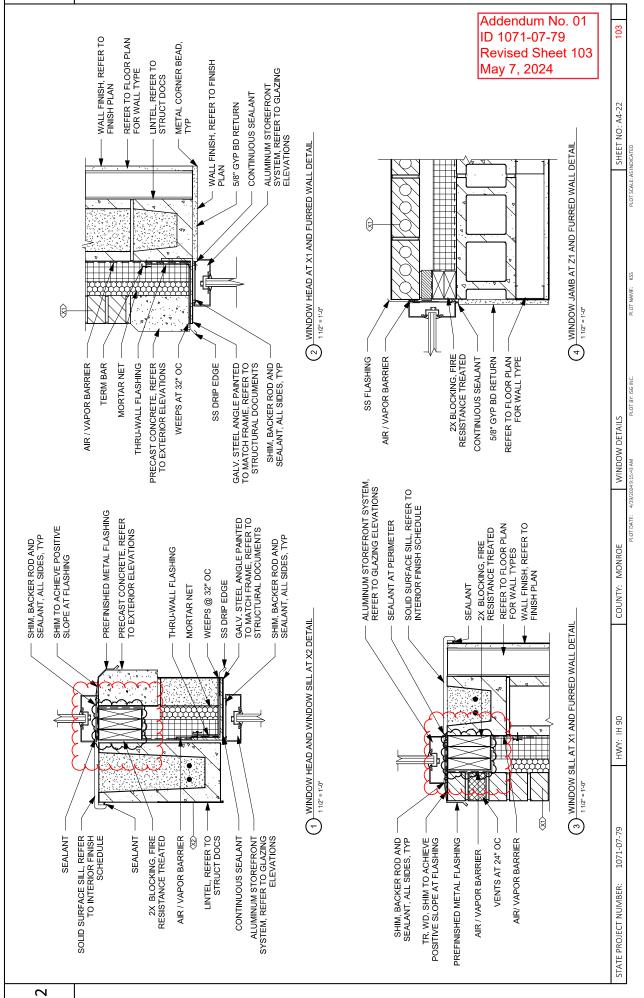




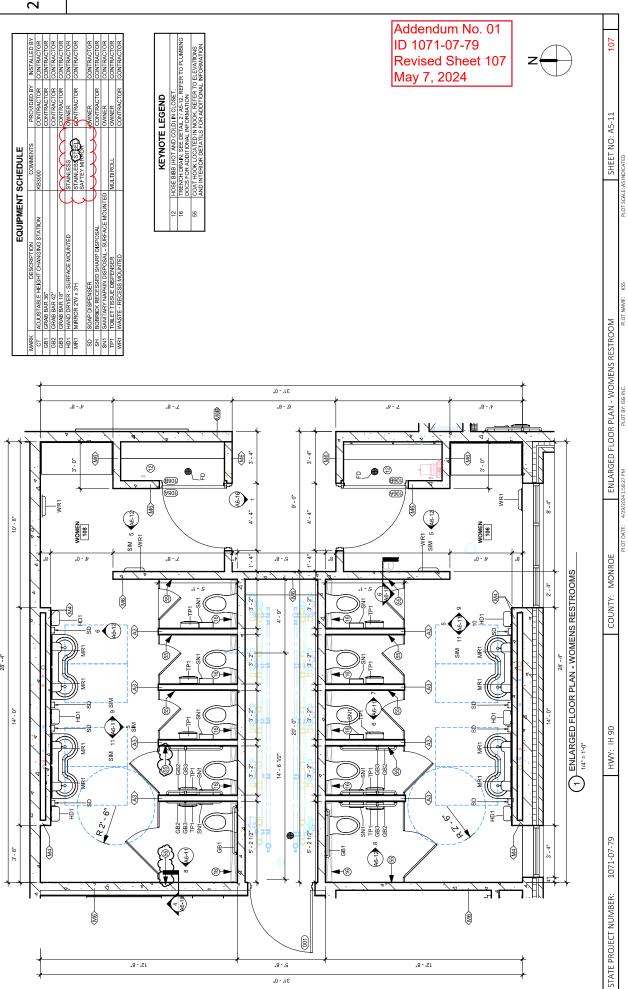




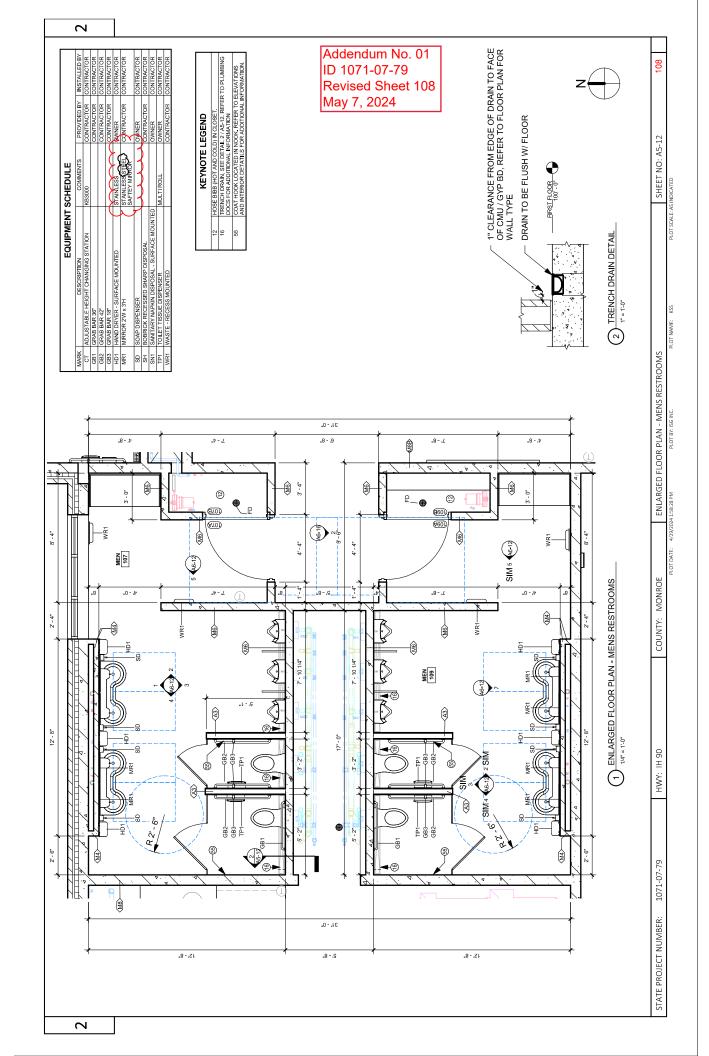




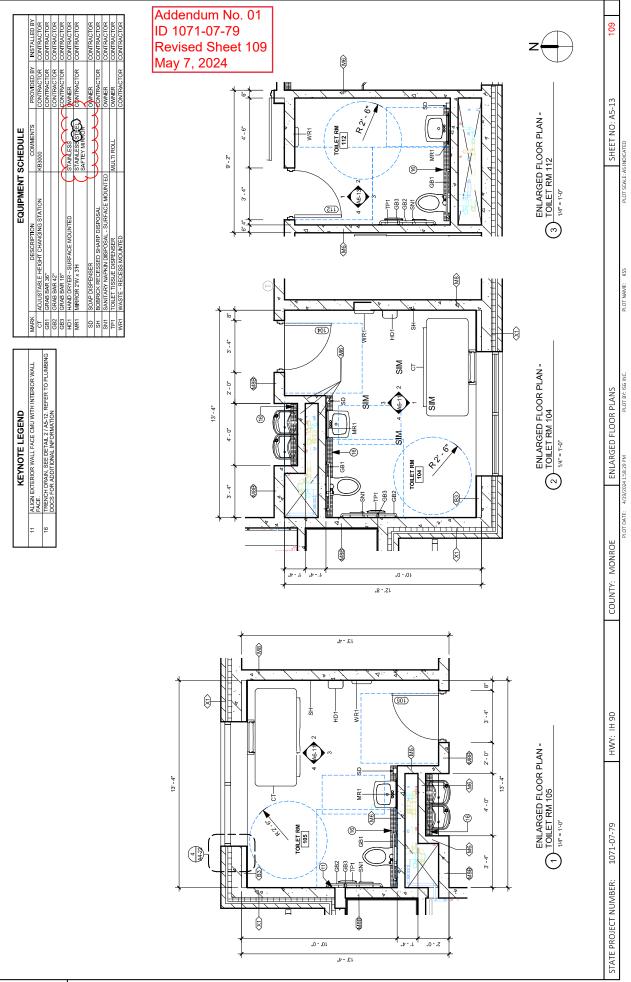
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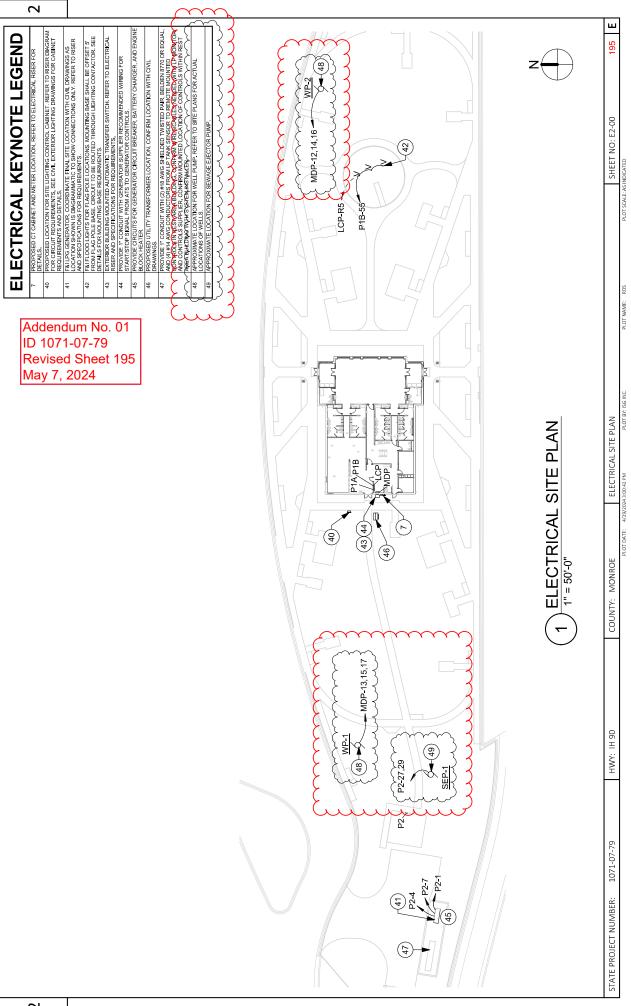



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Addendum No. 01 ID 1071-07-79 Revised Sheet 205 May 7, 2024 Е

205

SHEET NO: E5-11

4/29/2024 3:00:42 PM PLOT BY: ISG INC.

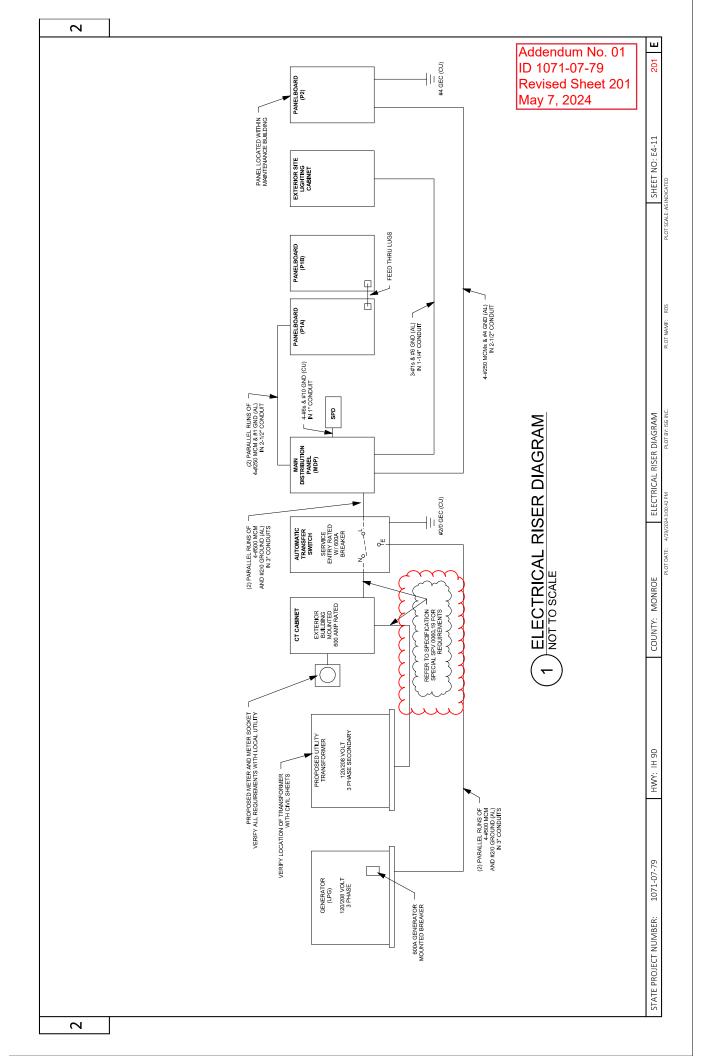COUNTY: MONROE

НМҮ: ІН 90

1071-07-79

STATE PROJECT NUMBER:

£ 6 CKT MON A EXTERIOR HIGHTIME Circuit Description Total Conn. Load: 225246 VA

Total Est. Demand: 220806 VA Total Est. Demand: 625 A Panel Totals A.I.C. Rating: 35 KAIC Mains Type: MLO Mains Rating: 600 A MCB Rating: 600 A 200 A PANEL P2 Trib Pole 2699 | (-- 1793 VA က 14571 34500 VA 4785 VA 76 VA 26772 VA 2706 VA Estimated... 101151 VA 26550 VA 14440 VA 10000 VA 598 A 3699 49826 Volts: 120/208 Wye Phases: 3 Wires: 4 14488 2000 3699 77037 VA Demand Factor 648 A 100.00% 100.00% 100.00% 100.00% 100.00% 76.48% ш 100.00% 100.00% 50152 3699 50103 13920 3699 5000 Connected Load 76420 VA 643 A 34500 VA 4785 VA 76 VA 26772 VA 2706 VA 26550 VA 18880 VA 10000 VA Control of the state of the sta Pole 4 SURGE PROTECTIVE DEVICE 60 A 3 က က Location: ELECT / IT 115 400 A Trip Supply From:
Mounting: Surface
Enclosure: Type 1 Circuit Description PANELS P1A & P1B 15 WELL PUMP #1 Load Classification HVAC Lighting - Exterior Motor Receptacle Legend: Lighting Heating Notes: Power Other Spare 얹 က

Distrib, Panel: MDP

A.I.C. Rating: 10 kAIC

Branch Panel: P2

Notes:

Addendum No. 01 ID 1071-07-79 Revised Sheet 208 May 7, 2024

 20 A
 MECH/BLDG CONTROL PANEL
 2

 20 A
 GEN ENGINE HEATER
 4

 20 A
 GARAGE DOOR
 6

 20 A
 RCPTS - NORTH WALL
 8

 20 A
 RCPTS - SOUTH WALL
 10

 20 A
 RCPTS - SOUTH WALL
 10

 20 A
 RCPTS - SW WALL/EXTERIOR
 17
 ELECTRIC UNIT HEATER (EUH-1) Circuit Description Mains Type: MCB Mains Rating: 200 A MCB Rating: 200 A SPARE SPARE SPARE BLANK BLANK 20 A 20 A 20 A 60 A ŧ Pole 1000 2000 540 0 14571 VA 122 A ပ 2000 1500 200 540 250 **Volts:** 120/208 Wye **Phases:** 3 **Wires:** 4 5000 1200 540 14488 VA 121 A œ 1500 2000 790 250 270 200 540 5000 13920 VA 73920 V/ Joseph Load: 73920 V/ V/ V/ V/ Actal Amps: 7 116 A 1200 1500 2000 180 Pole 7 7 20 A 15 A 20 A 60 A Location: Space 11
Supply From: MDP
Mounting: Surface
Enclosure: Type 1 13 ELECTRIC WATER HEATER
15 (EWH-1)
19 ELECTRIC UNIT HEATER
21 (EUH-2)
23 (EUH-2)
25 (BLANK 27 SEWAGE EJECTOR PUMP 3 LIGHTING 5 RCPTS - EAST WALL/EXT. 7 GENERATOR BATTERY... Circuit Description RCPT - GENERATOR **EXHAUST FAN** Legend:

Е 208 SHEET NO: E5-14 ELECTRICAL PANEL SCHEDULES COUNTY: MONROE НМҮ: ІН 90 1071-07-79

STATE PROJECT NUMBER:

7

TIEM# DESCRIPTION								ECTRICA	ECTRICAL EQUIPMENT SCHEDULE	T SCHEI	JULE			
DESCRIPTION HP VOLTS POLES FLA VA MINIMUM CONDUIT TYPE BY TYPE					POV	VER RE		NTS	WIRE #SIZE, GND,	STA	RTER	DISCO	NNECT	
COURDENSING UNIT 208 V 2 16.04 5/764 VA 34°C; 3-105 (1004) (1	ITEM#		NO.	웊	VOLTS	POLES		\$	MINIMUM CONDUIT	TYPE	ВУ	TYPE	BY	NOTES
ENERGY PRECOVERY UNIT 208 V 2 0.0 A 5000 VA 34°C, 3-1°S, 10GND Clone) Clone Comb Clone Comb Clone Comb Clone Comb Clone Clon	CU-1	CONDENSING	INNIT		208 V	3	16.0 A	5764 VA	3/4"C, 3- 10's, 10GND	(none)	(none)	Ą	EC	
ENREGY WEEGURER UNIT 208 V 3 6.6 A 2378 VA 34°C, 3-12's, 120ND (none) NF ENREGY PRECOVERY UNIT 208 V 3 6.6 A 2378 VA 34°C, 3-12's, 120ND (none) NF NF NF NF NF NF NF N	DR-1	ELECTRIC DR	YER		208 V	2	0.0 A	5000 VA	3/4"C, 3- 10's, 10GND	(none)	(none)	(none)	(none)	
ENERGY RECOVERY UNIT 208 V 3 6.6 A 2378 VA 344°C, 3-125, 126ND (none) NF	EF-1	EXHAUST F,	AN	1/6	208 V	2	0.0 A	500 VA	3/4"C, 2- 12's, 12GND	COMB	EC	Ľ.	EC	INTERLOCK WITH CO/NO CONTROLS AND LOUVER
ENERGY RECOVERY UNIT 208 V 3 0.7 A 222 VA 34°C, 3-128, 126ND (none) (none) NF	ERV-1R		ERY UNIT		208 V	က	6.6 A	2378 VA	3/4"C, 3- 12's, 12GND	(none)	(none)	L Z	EC	
EMERGY WERE UNIT HEATER 208 V 3 0.7 A 1500 VA 11°C, 3-12°s, 10GND (none) (none) NF	ERV-1S		ERY UNIT		208 V	ო	6.6 A	2378 VA	3/4"C, 3- 12's, 12GND	(none)	(none)	L Z	EC	
ELECTRIC LIMIT HEATER 208 V 3 0.0 A 15000 VA 1°C, 3-6'S, 10GND (none) NF	ERV-1W		EEL L		208 V	က	0.7 A	252 VA	3/4"C, 3- 12's, 12GND	(none)	(none)	LZ	EC	
ELECTRIC LINIT HEATER 208 V 3 0.0 A 1500 VA 11°C, 3-6's, 10GND (none) (none) NF	EUH-1	ELECTRIC UNIT F	HEATER		208 V	က	0.0 A	15000 VA	1"C, 3-6's, 10GND	(none)	(none)	¥	ES	
ELECTRIC WATER HEATER 208 V 3 0.0 A 4500 VA 34"C, 3-12's, 12GND (none) (none) NF	EUH-2	ELECTRIC UNIT F	HEATER		208 V	3	0.0 A	15000 VA	1"C, 3-6's, 10GND	(none)	(none)	¥	ES	
WATER HEAT PUMP	EWH-1	ELECTRIC WATER	HEATER		208 V	3	0.0 A	4500 VA	3/4"C, 3- 12's, 12GND	(none)	(none)	N.	EC	
GEO PUMP 7-1/2 208 V 3 0.0 A 8646 VA 3/4"C, 3-8"s, 10GND VFD ES NF	HPWH-		PUMP		208 V	3	53.0 A	19094 VA	1-1/4"C, 3- 4's, 8GND	(none)	(none)	¥	EC	
HOT WATER PUMP 7-1/2 208 V 2 0.0 A 1125 VA 3/4"C, 2-12's, 12GND (none) (none) NF HOT WATER PUMP 1/2 208 V 2 0.0 A 1125 VA 3/4"C, 2-12's, 12GND (none) (none) NF HOT WATER PUMP 1/2 208 V 2 0.0 A 1125 VA 3/4"C, 2-12's, 12GND (none) (none) NF HOT WATER PUMP 1/2 208 V 2 0.0 A 1125 VA 3/4"C, 2-12's, 12GND (none) (none) NF HOT WATER PUMP 1/2 208 V 2 0.0 A 1125 VA 3/4"C, 2-12's, 12GND (none) (none) NF HOT WATER PUMP 1/2 208 V 2 5.5 A 1580 VA 1"C, 2-10's, 12GND (none) (none) NF SEWAGE ELECTOR PUMP 3/4 208 V 3 30.0 A 11096 VA 1"C, 3-6's, 8GND VFD ES NF WATER SOURCE HEAT PUMP 208 V 3 30.0 A 11096 VA 3/4"C, 3-8's, 10GND (none) (none) NF WATER SOURCE HEAT PUMP 208 V 3 30.0 A 10807 VA 3/4"C, 3-18's, 10GND (none) (none) NF WATER SOURCE HEAT PUMP 208 V 3 11.0 A 3962 VA 3/4"C, 3-18's, 10GND (none) (none) NF WATER SOURCE HEAT PUMP 208 V 3 11.0 A 3962 VA 3/4"C, 3-18's, 10GND (none) (none) NF WATER SOURCE HEAT PUMP 208 V 3 11.0 A 3962 VA 3/4"C, 3-18's, 10GND (none) (none) NF WATER SOURCE HEAT PUMP 208 V 3 11.0 A 3962 VA 3/4"C, 3-18's, 10GND (none) (none) NF WATER SOURCE HEAT PUMP 208 V 3 11.0 A 3962 VA 3/4"C, 3-18's, 10GND (none) (none) NF WATER SOURCE HEAT PUMP 208 V 3 21.0 A 7565 VA 3/4"C, 3-18's, 10GND (none) (none) NF WATER SOURCE HEAT PUMP 208 V 3 21.0 A 7565 VA 3/4"C, 3-18's, 10GND (none) (none) NF WATER SOURCE HEAT PUMP 208 V 3 21.0 A 7565 VA 3/4"C, 3-18's, 10GND (none) (none) NF WATER SOURCE HEAT PUMP 208 V 3 21.0 A 7565 VA 3/4"C, 3-18's, 10GND (none) (none) NF WATER TOWN HER HEAT PUMP 208 V 3 21.0 A 7565 VA 3/4"C, 3-18's, 10GND (none) (none)	PGW-1			7-1/2	208 V	ဇ	0.0 A	8646 VA	3/4"C, 3-8's, 10GND	VFD	ES	Ľ	ES	INSTALL SUPPLIER PROVIDED VFD AND DISCONNECT. PROVIDE ALL TERMINATIONS/CONNECTIONS.
HOT WATER PUMP 1/2 208 V 2 0.0 A 1125 VA 3/4"C, 2-12's, 12GND (none) (none) NF HOT WATER PUMP 1/2 208 V 2 0.0 A 1125 VA 3/4"C, 2-12's, 12GND (none) (none) NF HOT WATER PUMP 1/2 208 V 2 0.0 A 1125 VA 3/4"C, 2-12's, 12GND (none) (none) NF HOT WATER PUMP 1/2 208 V 2 0.0 A 1125 VA 3/4"C, 2-12's, 12GND (none) (none) NF SEWAGE EJECTOR PUMP 3/4 208 V 2 5.5 A 1380 VA 1"C, 2-10's, 10GND (none) (none) NF WATER SOURCE HEAT PUMP 10 208 V 3 30.0 A 11096 VA 3/4"C, 3-13's, 12GND (none) (none) (none) NF WATER SOURCE HEAT PUMP 208 V 3 30.0 A 1080 VA 3/4"C, 3-13's, 12GND (none) (none) (none) NF WATER SOURCE HEAT PUMP 208 V 3 11.0 A 3962 VA 3/4"C, 3-12's, 12GND (none) (none) (none) NF WATER SOURCE HEAT PUMP 208 V 3 21.0 A 7565 VA 3/4"C, 3-12's, 12GND (none) (none) (none) NF WATER SOURCE HEAT PUMP 208 V 3 21.0 A 7565 VA 3/4"C, 3-12's, 12GND (none) (none) NF WATER SOURCE HEAT PUMP 208 V 3 21.0 A 7565 VA 3/4"C, 3-12's, 12GND (none) (none) NF WATER SOURCE HEAT PUMP 208 V 3 21.0 A 7565 VA 3/4"C, 3-12's, 12GND (none) (none) NF WATER SOURCE HEAT PUMP 208 V 3 21.0 A 7565 VA 3/4"C, 3-12's, 12GND (none) (none) NF WATER TOWN WATER HEAT PUMP 208 V 3 21.0 A 7565 VA 3/4"C, 3-12's, 12GND (none) (none) NF WATER TOWN WATER HEAT PUMP 208 V 3 21.0 A 7565 VA 3/4"C, 3-12's, 12GND (none) (none) NF WATER TOWN WATER HEAT PUMP 208 V 3 21.0 A 7565 VA 3/4"C, 3-12's, 12GND (none) (none) NF WATER TOWN WATER HEAT PUMP 208 V 3 21.0 A 7565 VA 3/4"C, 3-12's, 12GND (none) (no	PGW-2		<u> </u>	7-1/2		က	0.0 A	8646 VA	3/4"C, 3-8's, 10GND	VFD	ES	Ä.	ES	INSTALL SUPPLIER PROVIDED VFD AND DISCONNECT. PROVIDE ALL TERMINATIONS/CONNECTIONS.
HOT WATER PUMP 1/2 208 V 2 0.0 A 1125 VA 3/4"C, 2-12's, 12GND (none) (none) NF HOT WATER PUMP 1/6 120 V 1 0.0 A 1125 VA 3/4"C, 2-12's, 12GND (none) (none) NF HOT WATER PUMP 1/2 208 V 2 0.0 A 1125 VA 3/4"C, 2-12's, 12GND (none) (none) NF SEWAGE EJECTOR PUMP 3/4 208 V 2 5.5 A 1580 VA 1"C, 2-10's, 1GND VFD ES NF WELL PUMP 10 208 V 3 30.0 A 11096 VA 1"C, 2-10's, 1GND VFD ES NF WATER SOURCE HEAT PUMP 208 V 3 30.0 A 11096 VA 3/4"C, 3-13's, 1GND (none) (none) NF WATER SOURCE HEAT PUMP 208 V 3 30.0 A 10807 VA 3/4"C, 3-13's, 1GND (none) (none) NF WATER SOURCE HEAT PUMP 208 V 3 11.0 A 3962 VA 3/4"C, 3-12's, 1GND (none) (none) NF WATER SOURCE HEAT PUMP 208 V 3 21.0 A 7565 VA 3/4"C, 3-12's, 1GND (none) (none) NF WATER SOURCE HEAT PUMP 208 V 3 21.0 A 7565 VA 3/4"C, 3-12's, 1GND (none) (none) NF WATER SOURCE HEAT PUMP 208 V 3 21.0 A 7565 VA 3/4"C, 3-12's, 1GND (none) (none) NF WATER SOURCE HEAT PUMP 208 V 3 21.0 A 7565 VA 3/4"C, 3-12's, 1GND (none) (none) NF WATER TOW WATER HEAT PUMP 208 V 3 21.0 A 7565 VA 3/4"C, 3-12's, 1GND (none) (none) NF WATER TOW WATER HEAT PUMP 208 V 3 21.0 A 7565 VA 3/4"C, 3-12's, 1GND (none) (none) NF WATER TOW WATER HEAT PUMP 208 V 3 21.0 A 7565 VA 3/4"C, 3-12's, 1GND (none) (none) NF WATER TOW WATER HEAT PUMP 208 V 3 21.0 A 7565 VA 3/4"C, 3-12's, 1GND (none) (none) NF WATER TOW WATER HEAT PUMP 208 V 3 21.0 A 7565 VA 3/4"C, 3-12's, 1GND (none) (none) NF WATER TOW WATER HEAT PUMP 208 V 3 21.0 A 7565 VA 3/4"C, 3-12's, 1GND (none) (none) NF WATER TOW WATER HEAT PUMP 208 V 3 21.0 A 7565 VA 3/4"C, 3-12's, 1GND (none) (none) NF WATER TOW WATER HEAT PUMP 208 V 3 21.0 A 7565 VA 3/4"C, 3-12's, 1GND (none) (no	PHW-1		UMP	1/2	208 V	2	0.0 A	1125 VA	3/4"C, 2- 12's, 12GND	(none)	(none)	분	<u></u>	
HOT WATER PUMP 1/6 120 V 1 0.0 A 528 VA 3/4"C, 2-12's, 12GND (none) NF	PHW-2		UMP	1/2	208 V	2	0.0 A	1125 VA	3/4"C, 2- 12's, 12GND	(none)	(none)	불	2	
HOT WATER PUMP 1/2 208 V 2 0.0 A 1125 VA 34"C, 2-12's, 12GND (none) NF	PHW-3		JUMP	1/6	120 V	-	0.0 A	528 VA	3/4"C, 2- 12's, 12GND	(none)	(none)	¥	EC	
SEWAGE EJECTOR PUMP 3/4 208 V 2 5.5 A 1580 VA 1"C, 2-10's, 10GND (none) NF NF NF NF NF NF NF N	PHW-4		JUMP		208 V	2	0.0 A	1125 VA	3/4"C, 2- 12's, 12GND	(none)	(none)	Ä	EC	
SEWAGE EJECTOR PUMP 3/4 208 V 2 5.5 A 1580 VA 1"C, 2-10's, 10GND (none) NF NF	- Hert	N.	REPUMPY		1 1 2 2 1 1 1 1 1 1 1 1 1 1 1 1 1 1 1 1	* -	A PROVI	A Secretary	A STATES A PES, 42 GND X	- (mente)	Chamber >		- XEST - 1	
WELL PUMP 10 208 V 3 30.0 A 11096 VA 1"C, 3-6's, 8GND VFD ES NF WATER SOURCE HEAT PUMP 208 V 3 30.0 A 1006 VA 340,27,3-83,10SND (flore) ES NF WATER SOURCE HEAT PUMP 208 V 3 30.0 A 10807 VA 347.C,3-83,10SND (flore) (flore) NF WATER SOURCE HEAT PUMP 208 V 3 30.0 A 10807 VA 347.C,3-83,10SND (none) NF WATER SOURCE HEAT PUMP 208 V 3 11.0 A 3962 VA 347.C,3-83,10SND (none) NF WATER SOURCE HEAT PUMP 208 V 3 11.0 A 3962 VA 347.C,3-83,10SND (none) NF WATER SOURCE HEAT PUMP 208 V 3 11.0 A 3962 VA 347.C,3-12's,12GND (none) NF WATER SOURCE HEAT PUMP 208 V 3 11.0 A 3962 VA 347.C,3-12's,12GND (none) NF WATER SOURCE HEAT PUMP 208 V 3 11.0 A 3962 VA	SEP-1	SEWAGE EJECTO	JR PUMP	3/4	208 V	2	5.5 A	1580 VA	1"C, 2- 10's, 10GND	(none)	(auou)	NF	EC	\ {
WELL PUMP 10 208 V 3 30.0 A 11096 VA 1"C, 3-6's, 8GND VFD ES NF WATER SOURCE HEAT PUMP 208 V 3 30.0 A 10807 VA 34°C, 3-18°, 10GND (none) (none) NF WATER SOURCE HEAT PUMP 208 V 3 11.0 A 3662 VA 34°C, 3-12°s, 12GND (none) NF WATER SOURCE HEAT PUMP 208 V 3 11.0 A 3662 VA 34"C, 3-12°s, 12GND (none) NF WATER SOURCE HEAT PUMP 208 V 3 11.0 A 362 VA 34"C, 3-12°s, 12GND (none) NF WATER SOURCE HEAT PUMP 208 V 3 11.0 A 362 VA 34"C, 3-12°s, 12GND (none) NF WATER SOURCE HEAT PUMP 208 V 3 11.0 A 3962 VA 34"C, 3-12°s, 12GND (none) NF	WP-1	WELL PUM	ll −	10	208 V	3	30.0 A	11096 VA	1"C, 3-6's, 8GND	VFD	ES	NF	EC	>
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Addendum No. 01
ID 1071-07-79
Revised Sheet 209
May 7, 2024

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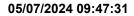
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HWY: IH 90 COUNTY: MONROE MISCELLANEOUS QUANTITIES
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	632.0201.08	ASCLEPIAS A TUBEROSA BUTTERFLY MILKWEED, DP 50, PLUG (EACH)	i	74		632.0201.18	SPOROBOLUS HETEROLEPIS S PRAIRIE DROPSEED, DP 50, PLUG (EACH)		39	39							
	632.0201.07	ANAPHALIS MARGARITACEA PEARLY EVERLASTING, DP 50, PLUG (EACH)	:	28		632.0201.17 6	SCHIZACHYRIUM S SCOPARIUM H LITTLE BLUESTEM, DP 50, PLUG C (EACH)		31	31							
	632.0201.06	SYMPHORICARPOS ALBUS COMIMON SNOWBERRY, 12" HT, CONT (EACH)	;	24		632.0201.16 632	MONARDA FISTULOSA BERGAMOT, DP 50, PLUG (EACH)		41	41							
	632.0201.05	RIBES AMERICANUM AMERICAN BLACK CURRANT, 12" HT, CONT (EACH)	:	14		632.0201.15	HEUCHERA RICHARDSONII PRAIRIE ALUM ROOT, DP 50, PLUG (EACH)		92	92			1			•	311
	632.0201.04	DIERVILLA LONICERA DWARF BUSH HONEYSUCKLE, 12" HT, CONT (EACH)		n 6		632.0201.14	FRAGARIA VESCA WOODLAND STRAWBERRY, DP 50, PLUG (EACH)		98	98		SPV.0060.07SPV.0165.01	ING UNIT NER PAVING H) (SF)		773	773	MISCELL ANEOLIS OLIVANTITIES
	632.0201.03 63	DASIPHORA LONI FRUTICOSA BUSH CINQUEFOIL, HO 12" HT, CONT 12 (EACH)		n 60	D.)	632.0201.13	DALEA ECHINACEA PURPUREA ANGUSTIFOLIA PURPLE PRAIRIE NARROW LEAF CLOVER, CONFICOWER, DP 50, PUG DE 50, PUG (EACH) (EACH)		20	20		SPV.006	PLANTING CONTAINER TION (EACH)		2+70 RB 4	4	MAISCELLAN
SHRUBS					SHRUBS (CONT'D.)	632.0201.12	DALEA PURPUREA PURPLE PRAIRI CLOVER, DP 50, PLUG		48	48	PLANTING ITEMS		STATION - STATION		83+10 RB - 119		
	632.0201.02	Y CEANOTHUS AMERICANUS NEW JERSEY TEA, 12" HT, CONT (EACH)		18	HS	632.0201.11	BOUTELOUA GRACILIS BLUE GRAMA GRASS, DP 50, PLUG (EACH)		31	31	PLANTI		LOCATION		REST AREA PLAZA 1183+10 RB - 1192+70 RB	14	
	632.0201.01	MELANOCARPA VAR. ELATAGLOSSY BLACK CHOKEBERRY, 12" HT, CONT (EACH)	:	12		632.0201.10	BOUTELOUA CURTIPENDULA SIDE OATS GRAMA, G DP 50, PLUG (EACH)		48	48			CATEGORY LO		0010 RESTA	PROJECT 1071-07-79 TOTAL	V. MONDO
		v STATION - STATION		KESI AREA PLAZA 1183+10 KB-1192+/0 KB 7 TOTAL		632.0201.09	ASCLEPIAS VERTICILLATA C WHORLED MILKWEED, DP 50, PLUG (EACH)		7.2	72			PROJECT C	1071-07-79		PROJECT 10	XEM 100
				LAZA 1183+10			STATION - STATION		REST AREA PLAZA 1183+10 RB-1192+70 RB								
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	659.2130 CABNETS 120/240 30-NCH EACH	3					1186+91'RB' 1187+85'RB'	1188+37'RB'	1189+02'RB' 1189+48'RB'	1190+12'RB'	1190+34'RB'	1188+79'RB'	1189+55'RB'	1188+79'RB'	1189+59'RB'	1189+02'RB'	1187+86'RB'	1187+30'RB'	1186+78'KB 1185+89'RB'	1184+85'RB'	PROJECT TOTAL	
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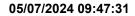
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Federal ID(s): WISC 2024351

SECTION: 0001 Contract Items

Proposal Line Number	Item ID Description	Approximate Quantity and Units	Unit Price	Bid Amount
0002	201.0205 Grubbing	10.000 STA		
0004	203.0100 Removing Small Pipe Culverts	1.000 EACH	<u>,</u>	
0006	204.0100 Removing Concrete Pavement	726.000 SY	<u>-</u>	·
0008	204.0170 Removing Fence	76.000 LF		·
0010	204.0265 Abandoning Wells	1.000 EACH	<u>-</u>	·
0012	205.0100 Excavation Common	2,961.000 CY		·
0014	208.0100 Borrow	10,324.000 CY		<u> </u>
0016	213.0100 Finishing Roadway (project) 01. 1071- 07-79	1.000 EACH	·	
0018	305.0110 Base Aggregate Dense 3/4-Inch	1,080.000 TON	<u></u>	
0020	305.0120 Base Aggregate Dense 1 1/4-Inch	290.000 TON		
0022	312.0110 Select Crushed Material	182.000 TON	·	
0024	522.1015 Apron Endwalls for Culvert Pipe Reinforced Concrete 15-Inch	1.000 EACH		·
0026	531.2036 Drilling Shaft 36-Inch	10.000 LF		<u> </u>
0028	531.4050 Foundation Camera Pole 50-FT	1.000 EACH		
0030	601.0115 Concrete Curb Type G	160.000 LF		<u> </u>








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Federal ID(s): WISC 2024351

SECTION: 0001 Contract Items

Proposal Line Number	Item ID Description	Approximate Quantity and Units	Unit Price	Bid Amount
0032	602.0415 Concrete Sidewalk 6-Inch	31,000.000 SF	·	
0034	602.0505 Curb Ramp Detectable Warning Field Yellow	52.000 SF		·
0036	602.0815 Concrete Driveway 7-Inch	770.000 SY		
0038	606.0200 Riprap Medium	7.000 CY	·	·
0040	608.0315 Storm Sewer Pipe Reinforced Concrete Class III 15-Inch	162.000 LF	·	·
0042	611.0645 Inlet Covers Type MS-A	2.000 EACH		
0044	611.3901 Inlets Median 1 Grate	2.000 EACH		
0046	615.1000 Wisconsin Historical Marker	1.000 EACH		<u> </u>
0048	616.0206 Fence Chain Link 6-FT	220.000 LF		
0050	616.0329 Gates Chain Link (width) 01. 6-FT	2.000 EACH		
0052	616.0329 Gates Chain Link (width) 02. 4-FT	2.000 EACH		
0054	616.0700.S Fence Safety	1,000.000 LF		<u></u>
0056	618.0100 Maintenance and Repair of Haul Roads (project) 01. 1071-07-79	1.000 EACH		·
0058	619.1000 Mobilization	1.000 EACH		
0060	623.0200 Dust Control Surface Treatment	5,300.000 SY	<u></u>	





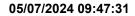


Page 3 of 12

Federal ID(s): WISC 2024351

SECTION: 0001 Contract Items

Proposal Line Number	Item ID Description	Approximate Quantity and Units	Unit Price	Bid Amount
0062	624.0100 Water	24.000 MGAL	<u> </u>	<u></u>
0064	625.0100 Topsoil	500.000 SY		
0066	625.0500 Salvaged Topsoil	10,200.000 SY	<u> </u>	<u> </u>
0068	627.0200 Mulching	8,100.000 SY		
0070	628.1104 Erosion Bales	60.000 EACH	<u> </u>	<u> </u>
0072	628.1530.S Silt Fence Heavy Duty	3,000.000 LF	·	·
0074	628.1535.S Silt Fence Heavy Duty Maintenance	9,000.000 LF	·	·
0076	628.1905 Mobilizations Erosion Control	22.000 EACH	·	·
0078	628.1910 Mobilizations Emergency Erosion Control	16.000 EACH	·	
0080	628.7005 Inlet Protection Type A	3.000 EACH	·	
0082	628.7020 Inlet Protection Type D	3.000 EACH		
0084	628.7560 Tracking Pads	2.000 EACH		
0086	629.0210 Fertilizer Type B	7.000 CWT		
0088	630.0140 Seeding Mixture No. 40	150.000 LB		
0090	630.0200 Seeding Temporary	220.000 LB		
0092	630.0500 Seed Water	190.000 MGAL	<u></u>	



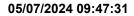




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Federal ID(s): WISC 2024351

SECTION: 0001 Contract Items

Proposal Line Number	Item ID Description	Approximate Quantity and Units	Unit Price	Bid Amount
0094	631.0300 Sod Water	80.000 MGAL	·	
0096	631.1000 Sod Lawn	3,450.000 SY	<u> </u>	·
0104	632.9101 Landscape Planting Surveillance and Care Cycles	24.000 EACH		
0106	633.5200 Markers Culvert End	1.000 EACH	<u> </u>	
0108	634.0612 Posts Wood 4x6-Inch X 12-FT	4.000 EACH	·	·
0110	634.0614 Posts Wood 4x6-Inch X 14-FT	14.000 EACH		·
0112	637.2210 Signs Type II Reflective H	73.250 SF		·
0114	639.0108 Drill Hole in Earth 8-Inch	100.000 LF		<u>-</u>
0116	639.0112 Drill Hole in Earth 12-Inch	170.000 LF		·
0118	639.1008 Well Casing Pipe 8-Inch	182.000 LF		<u> </u>
0120	639.1700 Well Screen	20.000 LF		<u>-</u>
0122	639.2100 Grout for Sealing Well Casing	54.000 CF		<u> </u>
0124	639.4000 Test Pumping	2.000 EACH		<u>-</u>
0126	642.5401 Field Office Type D	1.000 EACH		<u></u>
0128	643.0300 Traffic Control Drums	18,500.000 DAY		
0130	643.0420 Traffic Control Barricades Type III	1,450.000 DAY		





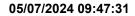


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Proposal Line Number	Item ID Description	Approximate Quantity and Units	Unit Price	Bid Amount
0132	643.0705 Traffic Control Warning Lights Type A	2,850.000 DAY	<u> </u>	
0134	643.0900 Traffic Control Signs	3,540.000 DAY		<u> </u>
0136	643.0910 Traffic Control Covering Signs Type I	2.000 EACH	<u> </u>	·
0138	643.0920 Traffic Control Covering Signs Type II	2.000 EACH	<u>-</u>	·
0140	643.1050 Traffic Control Signs PCMS	7.000 DAY	<u></u>	·
0142	643.3170 Temporary Marking Line Epoxy 6-Inch	610.000 LF		
0144	643.5000 Traffic Control	1.000 EACH	·	
0146	645.0120 Geotextile Type HR	13.000 SY	<u> </u>	
0148	650.4000 Construction Staking Storm Sewer	3.000 EACH	·	
0150	650.4500 Construction Staking Subgrade	1,110.000 LF	<u> </u>	
0152	650.5000 Construction Staking Base	300.000 LF	<u> </u>	
0154	650.5500 Construction Staking Curb Gutter and Curb & Gutter	160.000 LF		·
0156	650.7000 Construction Staking Concrete Pavement	820.000 LF	·	·
0158	650.8501 Construction Staking Electrical Installations (project) 01. 1071-07-79	1.000 EACH	·	
0160	650.9000 Construction Staking Curb Ramps	4.000 EACH		








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Proposal Line Number	Item ID Description	Approximate Quantity and Units	Unit Price	Bid Amount
0162	650.9500 Construction Staking Sidewalk (project) 01. 1071-07-79	1.000 EACH		·
0164	650.9911 Construction Staking Supplemental Control (project) 01. 1071-07-79	1.000 EACH		<u></u>
0166	650.9920 Construction Staking Slope Stakes	1,110.000 LF	·	
0168	652.0125 Conduit Rigid Metallic 2-Inch	30.000 LF		
0170	652.0225 Conduit Rigid Nonmetallic Schedule 40 2-Inch	3,160.000 LF		·
0172	652.0235 Conduit Rigid Nonmetallic Schedule 40 3-Inch	215.000 LF		
0174	653.0140 Pull Boxes Steel 24x42-Inch	6.000 EACH		
0176	653.0164 Pull Boxes Non-Conductive 24x42-Inch	16.000 EACH		
0178	654.0105 Concrete Bases Type 5	4.000 EACH		
0180	654.0111 Concrete Bases Type 11	20.000 EACH		
0182	654.0230 Concrete Control Cabinet Bases Type L30	1.000 EACH	<u>-</u>	·
0184	655.0610 Electrical Wire Lighting 12 AWG	1,440.000 LF		
0186	655.0615 Electrical Wire Lighting 10 AWG	5,799.000 LF		
0188	655.0625 Electrical Wire Lighting 6 AWG	450.000 LF		

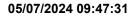






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Proposal Line Number	Item ID Description	Approximate Quantity and Units	Unit Price	Bid Amount
0192	656.0501 Electrical Service Breaker Disconnect Box (location) 01. CCTV410190	1.000 EACH		·
0194	659.0700 Lighting Units Walkway	20.000 EACH		
0196	659.2130 Lighting Control Cabinets 120/240 30- Inch	1.000 EACH		·
0198	670.0101 Field System Integrator	1.000 EACH	·	·
0200	670.0201 ITS Documentation	1.000 EACH		
0202	671.0112 Conduit HDPE 1-Duct 2-Inch	585.000 LF		
0204	671.0122 Conduit HDPE 2-Duct 2-Inch	480.000 LF		
0206	673.1225.S Install Pole Mounted Cabinet	1.000 EACH		
0208	677.0150 Install Camera Pole 50-FT	1.000 EACH		
0210	677.0200 Install Camera Assembly	1.000 EACH		
0212	678.0600 Install Ethernet Switches	1.000 EACH		
0214	690.0250 Sawing Concrete	140.000 LF		
0216	715.0720 Incentive Compressive Strength Concrete Pavement	500.000 DOL	1.00000	500.00
0218	ASP.1T0A On-the-Job Training Apprentice at \$5.00/HR	2,500.000 HRS	5.00000	12,500.00
0220	ASP.1T0G On-the-Job Training Graduate at \$5.00/HR	3,520.000 HRS	5.00000	17,600.00

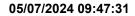






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Proposal Line Number	Item ID Description	Approximate Quantity and Units	Unit Price	Bid Amount
0222	SPV.0060 Special 01. Bench	13.000 EACH	·	·
0224	SPV.0060 Special 02. Litter Receptacle	33.000 EACH	·	
0226	SPV.0060 Special 03. Recycling Receptacle	33.000 EACH	·	
0228	SPV.0060 Special 04. Picnic Table	12.000 EACH	·	
0230	SPV.0060 Special 05. ADA Picnic Table	4.000 EACH		
0232	SPV.0060 Special 06. Flag Pole	3.000 EACH		<u> </u>
0234	SPV.0060 Special 07. Planting Container	4.000 EACH		<u> </u>
0236	SPV.0060 Special 08. Picnic Shelter	4.000 EACH		<u> </u>
0238	SPV.0060 Special 09. Install Cellular Modem	1.000 EACH		<u> </u>
0240	SPV.0060 Special 10. Ground Rod	1.000 EACH		
0242	SPV.0060 Special 11. Rest Area Building General	1.000 EACH		
0244	SPV.0060 Special 12. Rest Area Building Plumbing	1.000 EACH		<u> </u>
0246	SPV.0060 Special 13. Rest Area Building HVAC	1.000 EACH		<u> </u>
0248	SPV.0060 Special 14. Rest Area Building Electrical	1.000 EACH		<u> </u>
0250	SPV.0060 Special 15. Maintenance Building General	1.000 EACH	<u>.</u>	

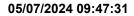






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Proposal Line Number	Item ID Description	Approximate Quantity and Units	Unit Price	Bid Amount
0252	SPV.0060 Special 16. Maintenance Building Plumbing	1.000 EACH	·	·
0254	SPV.0060 Special 17. Maintenance Building HVAC	1.000 EACH	·	
0256	SPV.0060 Special 18. Maintenance Building Electrical	1.000 EACH	·	·
0258	SPV.0060 Special 19. Electrical Service, Sparta Rest Area	1.000 EACH	·	·
0260	SPV.0060 Special 20. Sewage Ejector Pump and Controls	1.000 EACH	·	·
0262	SPV.0060 Special 21. Pitless Adapter	2.000 EACH	·	
0264	SPV.0060 Special 22. Well Pump	2.000 EACH		·
0266	SPV.0060 Special 23. Sanitary Sewer Manhole 4-ft	3.000 EACH		·
0268	SPV.0060 Special 24. Coring Manhole	1.000 EACH		
0270	SPV.0060 Special 25. Well System Controls	1.000 EACH		
0272	SPV.0060 Special 26. Adjusting Manhole Covers with Rubber Rings	1.000 EACH	·	·
0274	SPV.0060 Special 27. Bollard	7.000 EACH		
0276	SPV.0090 Special 01. Split Rail Fence	260.000 LF		
0278	SPV.0090 Special 02. Pipe Underdrain (8-Inch) with Geotextile Fabric and Aggregate	440.000 LF		

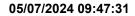






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Proposal Line Number	Item ID Description	Approximate Quantity and Units	Unit Price	Bid Amount
0280	SPV.0090 Special 03. Forcemain PVC, 2-Inch	334.000 LF	<u></u>	·
0282	SPV.0090 Special 04. Sanitary Sewer PVC 4-Inch	42.000 LF	·	·
0284	SPV.0090 Special 05. Sanitary Sewer PVC 8-Inch	539.000 LF		<u></u>
0286	SPV.0090 Special 06. Underground Copper Water Line 1-Inch	390.000 LF	·	<u>-</u>
0288	SPV.0090 Special 07. Underground Copper Water Line 3-Inch	595.000 LF		·
0290	SPV.0090 Special 08. Construction Staking Sanitary Sewer System	915.000 LF	·	<u></u>
0292	SPV.0165 Special 01. Unit Paving	773.000 SF	·	
0294	632.0101 Trees (species, root, size) 01. Celtis Occidentalis 'Chicagoland' Chicagoland Hackberry, 2.5" Cal, B&B	9.000 EACH	<u></u>	·
0296	632.0101 Trees (species, root, size) 02. Gleditsia Triacanthos Inermis 'Skycole' Skyline Honey Locust, 2.5" Cal, B&B	6.000 EACH	·	·
0298	632.0101 Trees (species, root, size) 03. Quercus Alba White Oak, 2.5" Cal, B&B	6.000 EACH		
0300	632.0101 Trees (species, root, size) 04. Quercus Bicolor Swamp White Oak, 2.5" Cal, B&B	4.000 EACH	·	·
0302	632.0201 Shrubs (species, root, size) 01. Aronia Melanocarpa Var. Elataglossy Black Chokeberry, 12" Height, Cont.	12.000 EACH		

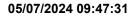






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Proposal Line Number	Item ID Description	Approximate Quantity and Units	Unit Price	Bid Amount
0304	632.0201 Shrubs (species, root, size) 02. Ceanothus Americanus New Jersey Tea, 12" Height, Cont.	18.000 EACH	<u>.</u>	·
0306	632.0201 Shrubs (species, root, size) 03. Dasiphora Fruticosa Bush Cinquefoil, 12" Height, Cont.	3.000 EACH	<u></u>	<u></u>
0308	632.0201 Shrubs (species, root, size) 04. Diervilla Lonicera Dwarf Bush Honeysuckle, 12" Height, Cont.	9.000 EACH	<u> </u>	<u> </u>
0310	632.0201 Shrubs (species, root, size) 05. Ribes Americanum American Black Currant, 12" Height, Cont.	14.000 EACH	<u></u>	·
0312	632.0201 Shrubs (species, root, size) 06. Symphoricarpos Albus Common Snowberry, 12" Height, Cont.	24.000 EACH	·	·
0314	632.0201 Shrubs (species, root, size) 07. Anaphalis Margaritacea Pearly Everlasting, DP 50, Plug	28.000 EACH	<u></u>	<u></u>
0316	632.0201 Shrubs (species, root, size) 08. Asclepias Tuberosa Butterfly Milkweed, DP 50, Plug	74.000 EACH	<u> </u>	<u> </u>
0318	632.0201 Shrubs (species, root, size) 09. Asclepias Verticillata Whorled Milkweed, DP 50, Plug	72.000 EACH	<u></u>	
0320	632.0201 Shrubs (species, root, size) 10. Bouteloua Curtipendula Side Oats Grama, DP 50, Plug	48.000 EACH	<u></u>	
0322	632.0201 Shrubs (species, root, size) 11. Bouteloua Gracilis Blue Grama Grass, DP 50, Plug	31.000 EACH	·	·

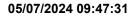




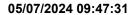
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Proposal Line Number	Item ID Description	Approximate Quantity and Units	Unit Price	Bid Amount
0324	632.0201 Shrubs (species, root, size) 12. Dalea Purpurea Purple Prairie Clover, DP 50, Plug	48.000 EACH		<u> </u>
0326	632.0201 Shrubs (species, root, size) 13. Echinacea Angustifolia Narrow Leaf Coneflower, DP 50, Plug	50.000 EACH	·	<u> </u>
0328	632.0201 Shrubs (species, root, size) 14. Fragaria Vesca Woodland Strawberry, DP 50, Plug	86.000 EACH		<u></u>
0330	632.0201 Shrubs (species, root, size) 15. Heuchera Richardsonii Prairie Alum Root, DP 50, Plug	92.000 EACH		
0332	632.0201 Shrubs (species, root, size) 16. Monarda Fistulosa Bergamot, DP 50, Plug	41.000 EACH		
0334	632.0201 Shrubs (species, root, size) 17. Schizachyrium Scoparium Little Bluestem, DP 50, Plug	31.000 EACH		
0336	632.0201 Shrubs (species, root, size) 18. Sporobolus Heterolepis Prairie Dropseed, DP 50, Plug	39.000 EACH		
0338	632.0201 Shrubs (species, root, size) 19. Symphyotrichum Sericeum Silky Aster, DP 50, Plug	38.000 EACH	·	·
	Section: 000)1	Total:	·
			Total Bid:	<u> </u>