Nov 8, 2022

ORDER OF SHEETS


PROJECT ID: WITH: N/A

3834-00-7

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Section	No.	1	Title
Section	No.	2	Typical Sections and Details (Includes Erosion Control Plans)
Section	No.	3	Estimate of Quantities
Section	No.	3	Miscellaneous Quantities
Section	No.	4	Right of Way Plat
Section	No.	5	Plan and Profile
Section	No.	6	Standard Detail Drawings
Section	No.	7	Sign Plates
Section	No.	8	Structure Plans
Section	No.	9	Computer Earthwork Data
Section	No.	9	Cross Sections

TOTAL SHEETS = 132

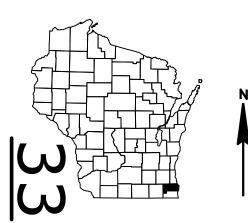

A.A.D.T.	2023	=	4,400
A.A.D.T.	2043	=	4,900
D.H.V.		=	610
D.D.		=	59/41
т.		=	5.2
DESIGN SPEE	D	=	30 MPH
ESALS		=	460,000

CONVENTIONAL SYMBOLS

PLAN CORPORATE LIMITS	<u>///////</u>
PROPERTY LINE	
LOT LINE LIMITED HIGHWAY EASEMENT EXISTING RIGHT OF WAY PROPOSED OR NEW R/W LINE	L
SLOPE INTERCEPT	
REFERENCE LINE	300°EB'
EXISTING CULVERT PROPOSED CULVERT (Box or Pipe) COMBUSTIBLE FLUIDS	
MARSH AREA	
WOODED OR SHRUB AREA	<

PROFILE

GRADE LINE

UTILITIES

ELECTRIC

GAS

FIBER OPTIC

STORM SEWER


TELEPHONE

POWER POLE

WATER

STATE OF WISCONSIN

3834-00-72

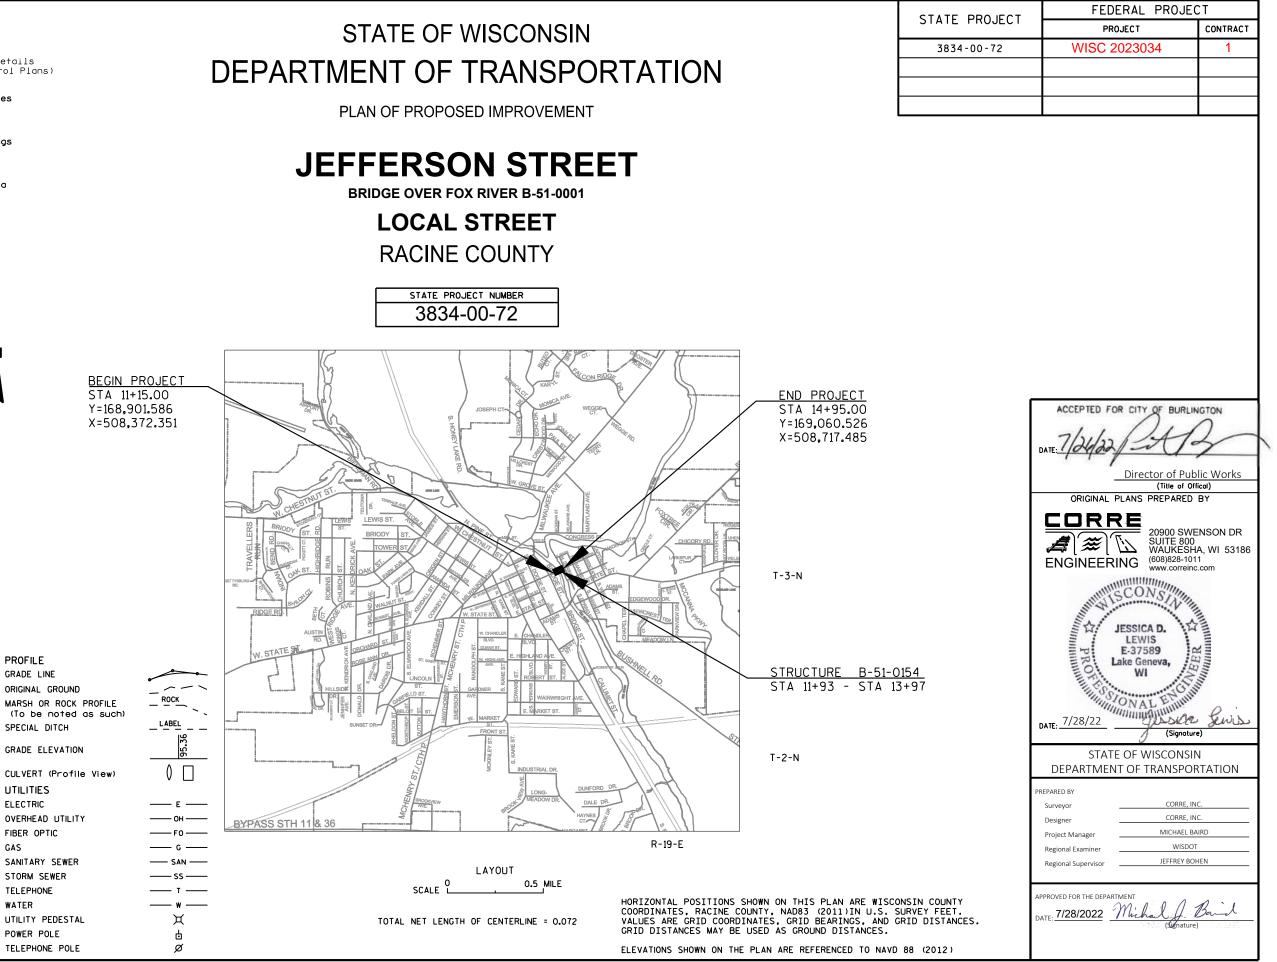

FILE NAME : C:\OD\CORRE, INC\PROJECTS - WI-SE REGION\3834-00-02 JEFFERSON ST_BRIDGE OVER FOX RIVER B-51-0001\500_CADD\501_C3D_2018\388#0002DASHEET3P2@N2020101:3D.DAWG LAYOUT NAME - 010101-TI

PLOT BY : JESSICA LEWIS, PE PLOT NAME :

COUNTY: RACINE

WKE

GENERAL NOTES

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- THE LOCATIONS OF EXISTING AND PROPOSED UTILITY INSTALLATIONS AS SHOWN ON THE PLANS ARE 1 APPROXIMATE. THERE MAY BE OTHER UTILITY INSTALLATIONS WITHIN THE PROJECT AREA THAT ARE NOT SHOWN, COORDINATE CONSTRUCTION ACTIVITIES WITH A CALL TO DIGGERS HOTLINE AND/OR A DIRECT CALL TO THE UTILITIES THAT HAVE FACILITIES IN THE AREA. NOT ALL UTILITIES ARE MEMBERS OF DIGGERS HOTLINE.
- CURB AND GUTTER GRADES ARE GIVEN TO THE FLANGE OF CURB AND GUTTER OR THEORETICAL FLANGE POINT OF INTEGRAL CURB AND GUTTER. CURB AND GUTTER RADII ARE MEASURED TO THE FLANGE OF CURB AND GUTTER OR THEORETICAL FLANGE POINT OF INTEGRAL CURB AND GUTTER.
- FOR INLET AND CATCH BASIN STRUCTURES LOCATED IN THE CURB OR IN FRONT OF BARRIER, STATION, OFFSET, 3 AND ELEVATIONS ARE GIVEN TO THE FLOW LINE. MH STATION, OFFSET, AND ELEVATIONS ARE GIVEN TO THE CENTER OF STRUCTURE. SEE CONSTRUCTION DETAILS.
- 4. CONTACT THE PROJECT ENGINEER, THE COUNTY SURVEYOR, AND SEWRPC AT LEAST TWO WEEKS BEFORE WORKING NEAR ANY SECTION CORNER MONUMENT.
- VERIFY EXISTING PAVEMENT ELEVATIONS AT ALL TIE-INS TO EXISTING PAVEMENT PRIOR TO CONSTRUCTION. NOTIFY ENGINEER IF A DISCREPANCY IS FOUND BETWEEN PROPOSED PLAN ELEVATIONS AND EXISTING PAVEMENT ELEVATIONS
- 6. CONSTRUCT PAVEMENT CONSISTENT WITH THE PLAN TYPICAL SECTIONS. LOCATE LONGITUDINAL JOINTS IN ASPHALT PAVEMENT OUTSIDE OF DRIVING, TURNING, BIKE, OR PARKING LANE UNLESS DIRECTED OTHERWISE BY THE ENG PREVENT HMA LONGITUDINAL JOINTS FROM BEING LOCATED WITHIN A DRIVING, TURNING, BIKE, OR PARKING LANE. THE CONTRACTOR'S PAVING OPERATIONS SHALL BE CONSISTENT WITH THE PLAN TYPICAL SECTIONS AND CONSTRUCTED TO PREVENT HMA LONGITUDINAL JOINTS FROM BEING LOCATED WITHIN A DRIVING, TURNING, BIKE OR PARKING LANE.
- 7. SAWCUT EXISTING ASPHALT AND CONCRETE PAVEMENT AT THE MATCHLINE AS INDICATED ON THE PLAN OR AS DIRECTED BY THE ENGINEER.
- TINE CONCRETE PAVEMENT LONGITUDINALLY UNLESS OTHERWISE IDENTIFIED IN THE PLAN OR DIRECTED BY THE 8. ENGINEER
- 9. CONSTRUCT INSIDE EDGE OF SIDEWALK 1/2 INCH HIGHER THAN TOP OF CURB WHEN THEY ARE ADJACENT TO EACH OTHER.
- 10. RESHAPE, RESTORE AND FINISH ALL PREVIOUSLY GRASSED AREAS DISTURBED BY OPERATIONS OUTSIDE OF THE NORMAL CONSTRUCTION LIMITS AT NO EXPENSE TO THE DEPARTMENT
- 11. PLACE TOPSOIL 1 INCH BELOW THE TOP OF ADJACENT CONCRETE CURBS OR SIDEWALKS IN SOD AREAS.
- 12. DISTURBED AREAS WITHIN THE RIGHT OF WAY ARE TO BE TOPSOILED (SALVAGED), FERTILIZED, AND SODDED AS DIRECTED BY THE ENGINEER
- 13. WHEN DEFINING THE PAVEMENT STRUCTURE, THE BOTTOM OF THE BASE AGGREGATE DENSE IS CONSIDERED THE SUBGRADE LINE.
- 14. BACKFILL ALL OPENINGS AND HOLES LOCATED WITHIN THE ROADWAY RESULTING FROM REMOVALS OR ABANDONMENTS WITH GRANULAR BACKFILL UNLESS THE PLANS PROVIDE FOR ALTERNATE BACKFILL.
- 15. DO NOT REMOVE ANY TREES OR SHRUBS WITHOUT APPROVAL OF THE ENGINEER
- 16. ALL SIGN LOCATIONS SHALL BE REVIEWED BY THE ENGINEER PRIOR TO INSTALLATION
- 17. EXISTING DRIVEWAYS AND FIELD ENTRANCES SHALL BE RESTORED IN KIND AS DIRECTED BY THE ENGINEER IN THE FIELD AND AT THE LOCATION DETERMINED BY THE ENGINEER.
- 18. THE EXACT LOCATION OF PRIVATE ENTRANCES IS TO BE DETERMINED IN THE FIELD BY THE ENGINEER
- 19 TOPSOIL SHALL BE REPLACED WITH 6-INCH TYPICAL DEPTH

ORDER OFSECTION 2 DETAIL SHEETS:

PROJECT OVERVIEW TYPICAL SECTIONS CONSTRUCTION DETAILS CURB RAMP DETAILS EROSION CONTROL PERMANENT SIGNING & PAVEMENT MARKING LIGHTING DETOUR PLAN ALGINMENT

STANDARD ABBREVIATIONS

AP AC AGG ASPH BL BM CB CC CONC CO CABC CY CULV CP C&G CULV CP C&G DIA DWY EB ELEV EW ENT EXC FP FERT F FF FF FF FO FT HYD INL	ACCESS POINT ACRE AGGREGATE ASPHALTIC BASELINE BENCH MARK CATCH BASIN CENTER LINE CONCRETE COUNTY CRUSHED AGGREGATE BASE COURSE CUBIC YARD CULVERT CULVERT PIPE CURB AND GUTTER DIAMETE	INTERS INV JT LT LF MH MB NOM NB PAVT PERM PU PCC PE PROJ PL RL RT R/W RDWY SHLDR SB SS TEL TEMP TER TV UG VOL W	INTERSECTION INVERT JOINT LEFT LINEAR FOOT MANHOLE MARKER POST MESSAGE BOARD NOMINAL NORTHBOUND PAVEMENT PERMENANT PIPE UNDERDRAIN PORTLAND CEMENT CONCRETE PRIVATE ENTRANCE PROJECT PROPERTY LINE REFERENCE LINE RIGHT RIGHT OF WAY ROADWAY SHOULDER SOUTHBOUND STORM SEWER TELEPHONE TEMPORARY TERPORARY TERPORARY TERPORARY TERPORARY TERPORARY TERPORARY TERPORARY VOLUME WATER
INL	INLET	WB	WATER

DNR LIASION

WISCONSIN DEPARTMENT OF NATURAL RESOURCES **BENTON STELZEL** 141 NW BARSTOW, ROOM 180 WAUKESHA, WI 53188 PHONE: (262) 623-0194 EMAIL: BENTON.STELZEL@WISCONSIN.GOV

DESIGN CONTACT

CORRE, INC. JESSICA LEWIS, PE 20900 SWENSON DRIVE SUITE 800 WAUKESHA, WI 53186 PHONE: (262) 393-1508 EMAIL: JLEWIS@CORREINC.COM

COMMUNICATION LINE

AT&T WISCONSIN NATHAN GIBERT 411 7TH STREET RACINE, WI 53403 PHONE: (262) 720-8235 EMAIL: NG952W@ATT.COM

WATER

CITY OF BURLINGTON PETER RIGGS 2200 S PINE STREET BURLINGTON, WI 53105 PHONE: (262) 342-1182 EMAIL: PRIGGS@BURLINGTON-WI.GOV

GAS

WE ENERGIES - GAS SCOTT HOLSTEIN 700 S KANE STREET BURLINGTON, WI 53105 PHONE: (262) 763-1084 EMAIL: We-Utility Relocations@we-energies.com

PROJECT NO:3834-00-72	HWY: JEFFERSON STREET	COUNTY:RACINE	GENERAL NOTES

FILE NAME : C:\OD\CORRE, INC\PROJECTS - WI-SE REGION\3834-00-02 JEFFERSON ST_BRIDGE OVER FOX RIVER B-51-0001\500_CADD\501_C3D_2018\388800022X5HEET9P27XN20221010CNPDWG PLOT BY : JESSICA LEWIS. PE PLOT NAME : LAYOUT NAME - 020101-GN

SOUTHEASTERN WISCONSIN REGIONAL PLANNING COMMISSION

ROB MERRY

W239 N1812 ROCKWOOD DRIVE, P.O. BOX 1607 WAUKESHA, WI 53187-1607 PHONE:(262) 953-4289 CELL: (920) 912-1036 E-MAIL: RMERRY@SEWRPC.ORG

ARCHAEOLOGIST

BRIAN NICHOLLS UW-MILWAUKEE E-MAIL: NICHOLLS@UWM.EDU

UTILITY CONTACTS

COMMUNICATION LINE

CHARTER COMMUNICATIONS STEVE STORM 1320 N DR MARTIN LUTHER KING DR MILWAUKEE, WI 53212 PHONE: (414) 908-1339 EMAIL: WIS.ENGINEERING@CHARTER.COM

ELECTRIC


WE ENERGIES - ELECTRIC SHAYLYNN CONNELLY 500 S. 116TH STREET WEST ALLIS, WI 53214 PHONE: (414) 944-5926 EMAIL: SHAYLYN.CONNELLY@WECENERGYGROUP.COM


COMMUNICATION LINE

WINDSTREAM AARON GRODI PHONE: (608) 819-5014EMAIL: AARON.GRODI@WINDSTREAM.COM



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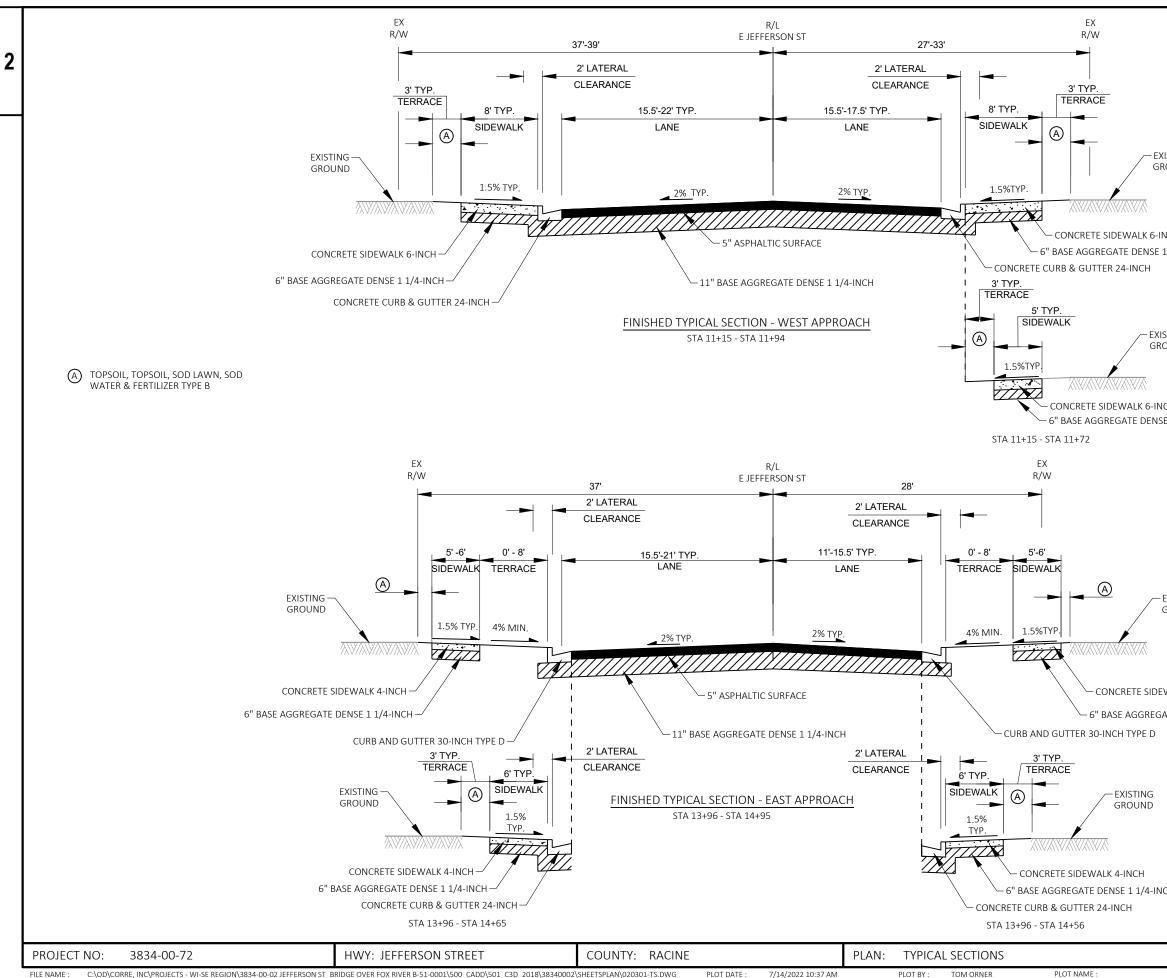

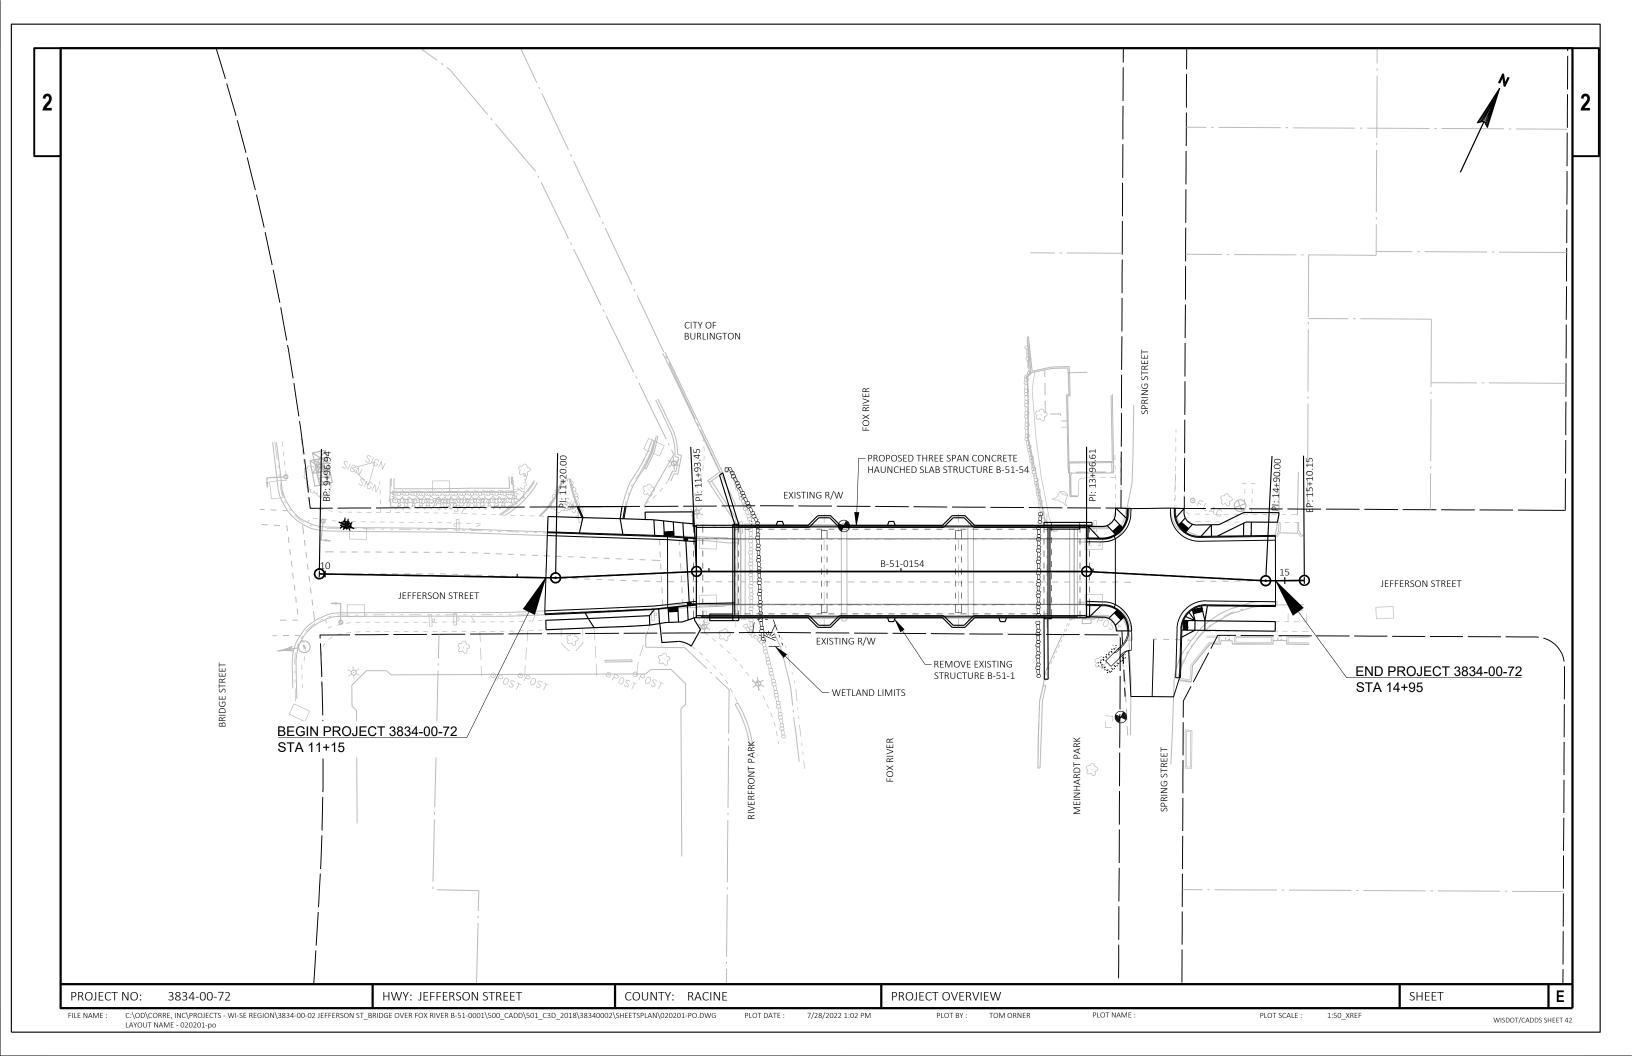
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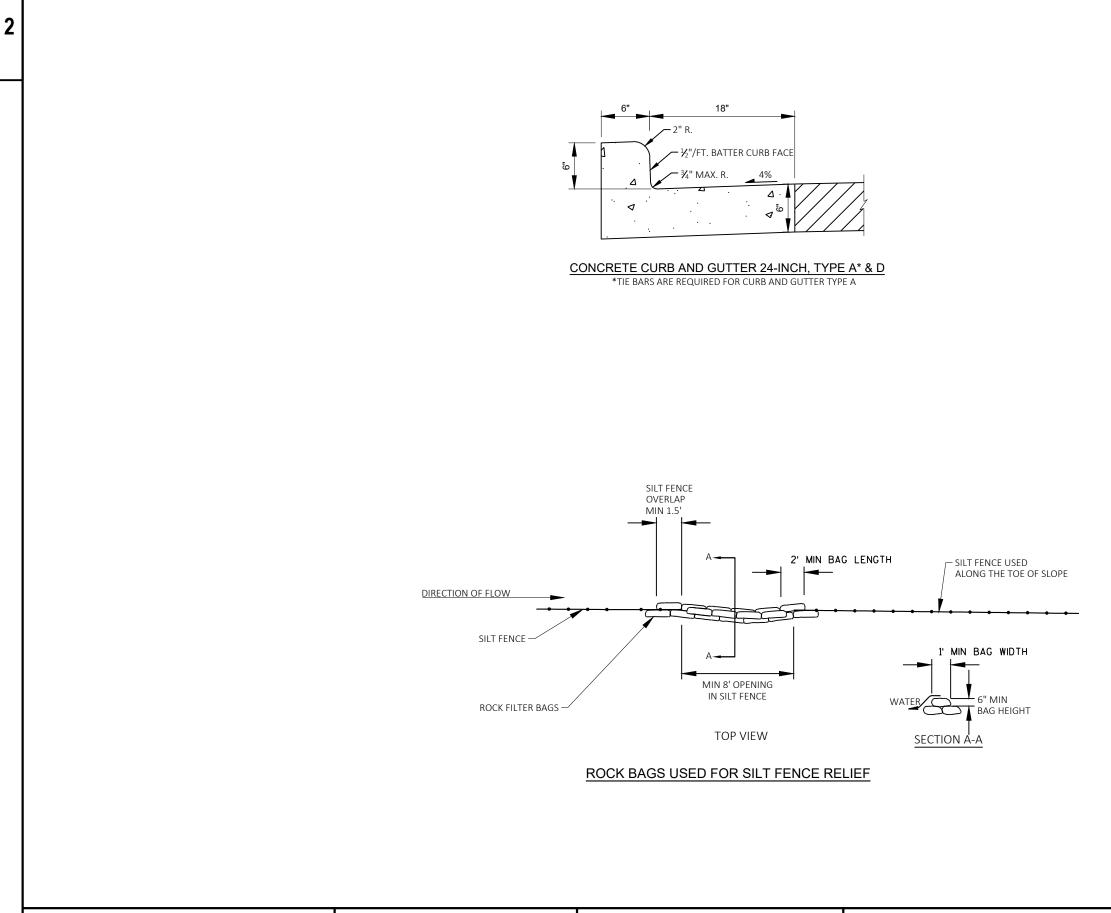
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NCH 1 1/4-INCH		
STING OUND		
CH E 1 1/4-INCH		
EXISTING GROUND		
WALK 4-INCH ATE DENSE 1 1/4-INCH		
СН		
	SHEET	

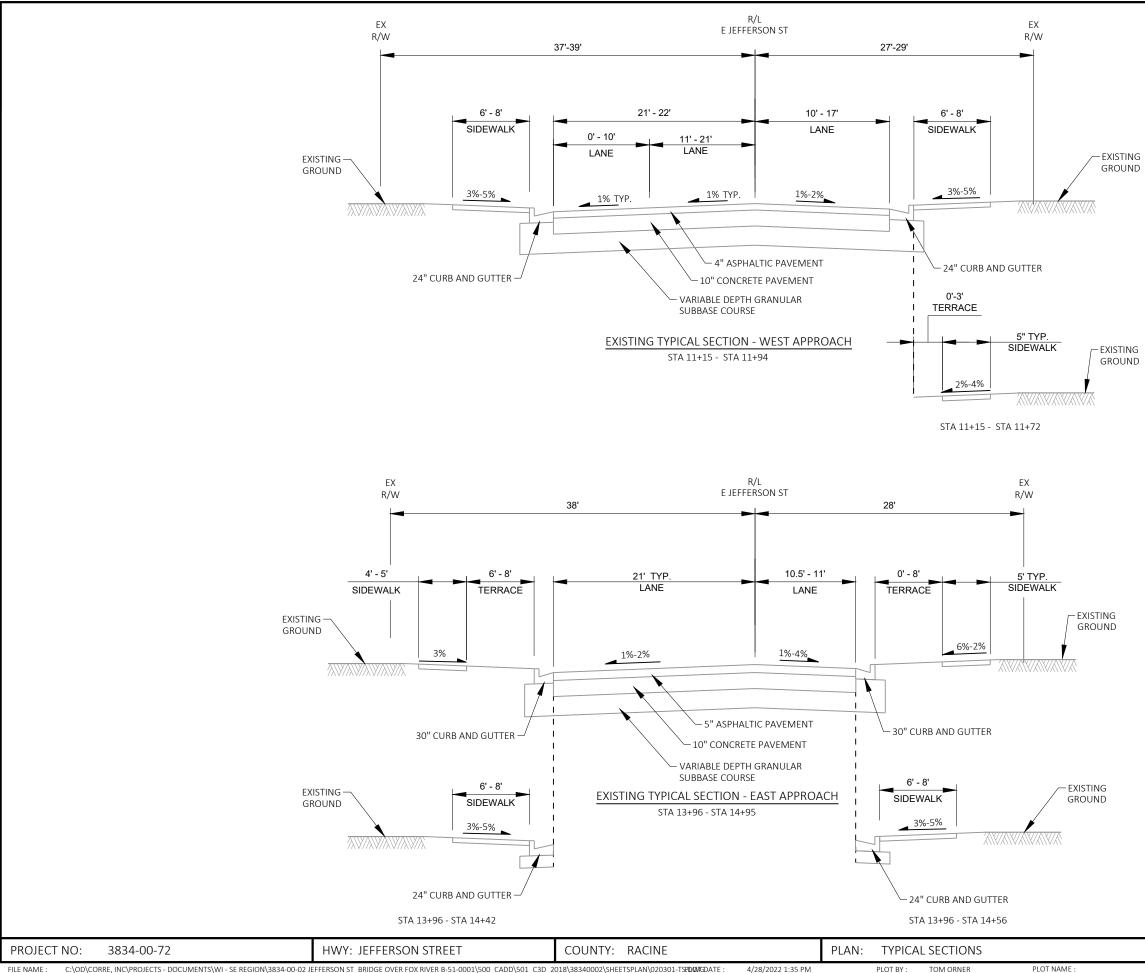WISDOT/CADDS SHEET 42




PROJECT NO:	3834-00-72	HWY: JEFFERSON STREET	COUNTY: RACINE			CONSTRUCTION	DETAILS		
FILE NAME : C:\OD\CORRE, INC\PROJECTS - WI-SE REGION\3834-00-02 JEFFERSON ST BRIDGE OVER FOX RIVER B-51-0001\500 CADD\501 C3D 2018\38340002\SHEETSPLAN\021001-CD.DWG				PLOT DATE :	9/2/2022 1:43 PM	PLOT BY :	JESSICA LEWIS, PE	PLOT NAME :	

FILE NAME : C:\OD\CORRE, INC\PROJECTS - WI-SE REGION\3834-00-02 JEFFERSON ST_BRIDGE OVER FOX RIVER B-51-0001\500_CADD\501_C3D_2018\38340002\SHEETSPLAN\021001-CD.DWG PLOT DATE : 9/2/2022 1:43 PM PLOT BY : JESSICA LEWIS, PE PLOT LAYOUT NAME - 01


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WISDOT/CADDS SHEET 42


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ATIONS, GRADES, SLOPES, LENGTHS AND MATCH POINTS PRIOR RUCTION. P ELEVATIONS TO FIT FIELD CONDITIONS WITHIN THE										
NT	R PROPOSEI LOCATIONS.		ARE FOR INFO	RMATIONAL PU	JRPOSES	ANDALANA				
N R	EFERENCE JE	EFFERSON S	Τ.							
		STATIO	N & OFFSET TA	BLE						
١T	STATION	OFFSET	Y COORDS	X COORDS	ELEVATION					
	11+72.90	16.81 RT	168913.002	508431.709	760.66					
	11+77.90	16.48 RT	168915.612	508435.984	760.80					
	11+82.90	16.14 RT	168918.222	508440.259	760.87					
	11+87.90	15.81 RT	168920.832	508444.534	760.78					
	11+72.92	18.58 RT	168911.439	508432.542	761.10					
	11+77.91	17.98 RT	168914.285	508436.691	760.81					
	11+82.91	17.64 RT	168916.896	508440.965	760.74					
	11+87.91	17.74 RT	168919.121	508445.445	761.22					
	11+72.98	26.19 RT	168904.719	508436.122	761.21	``				
	11+77.98	25.78 RT	168907.401	508440.358	760.86					
	11+82.98	25.81 RT	168909.688	508444.805	760.93					
	11+87.97	25.02 RT	168912.696	508448.868	761.33					
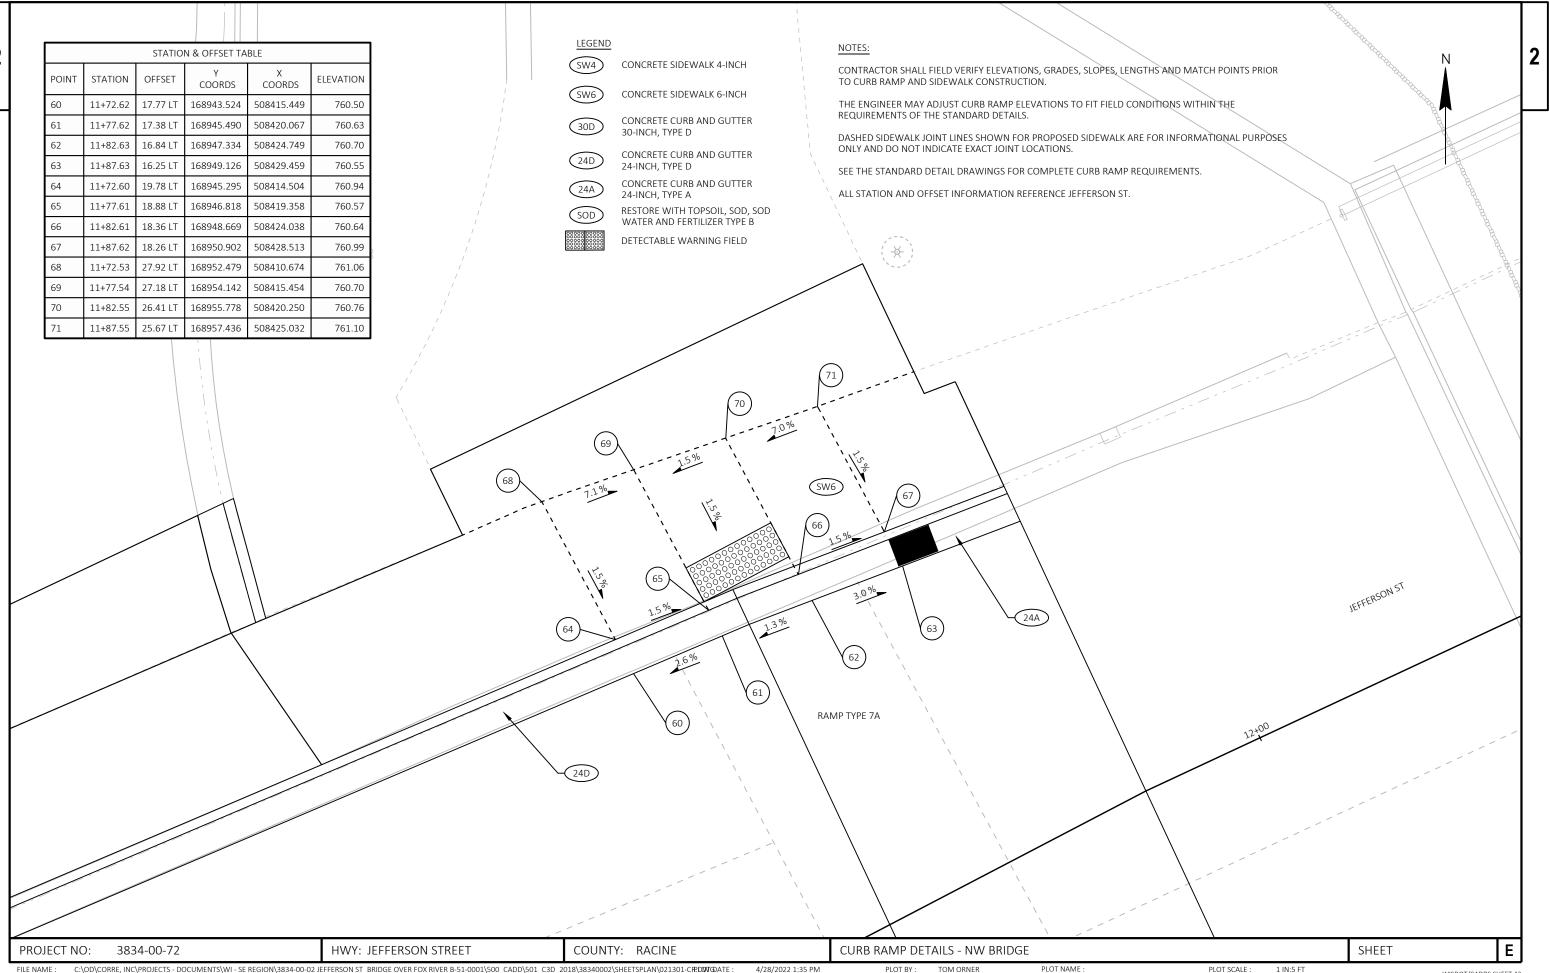
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			STATIO	N & OFFSET TA	BLE	
	POINT	STATION	OFFSET	Y COORDS	X COORDS	ELEVATION
	1	14+18.06	33.90 LT	169062.695	508633.442	759.83
AN AN	2	14+17.91	28.45 LT	169057.589	508635.350	760.20
Ś	3	14+15.94	28.76 LT	169057.138	508633.401	760.64
	4	14+15.56	22.45 LT	169051.145	508635.420	760.63
	5	14+14.45	23.50 LT	169051.700	508634.001	760.57
	6	14+12.12	18.82 LT	169046.489	508633.597	760.71
	7	14+10.99	19.89 LT	169047.055	508632.152	760.65
	8	14+02.42	15.76 LT	169040.010	508625.752	760.93
	9	14+02.33	17.76 LT	169041.830	508624.923	761.37
	10	13+96.61	23.52 LT	169044.877	508617.139	761.56
	11	14+06.13	24.49 LT	169049.497	508625.913	760.74
	12	14+09.57	28.12 LT	169054.153	508627.735	760.66
	13	14+10.06	33.80 LT	169059.601	508626.065	760.37



NOTES:
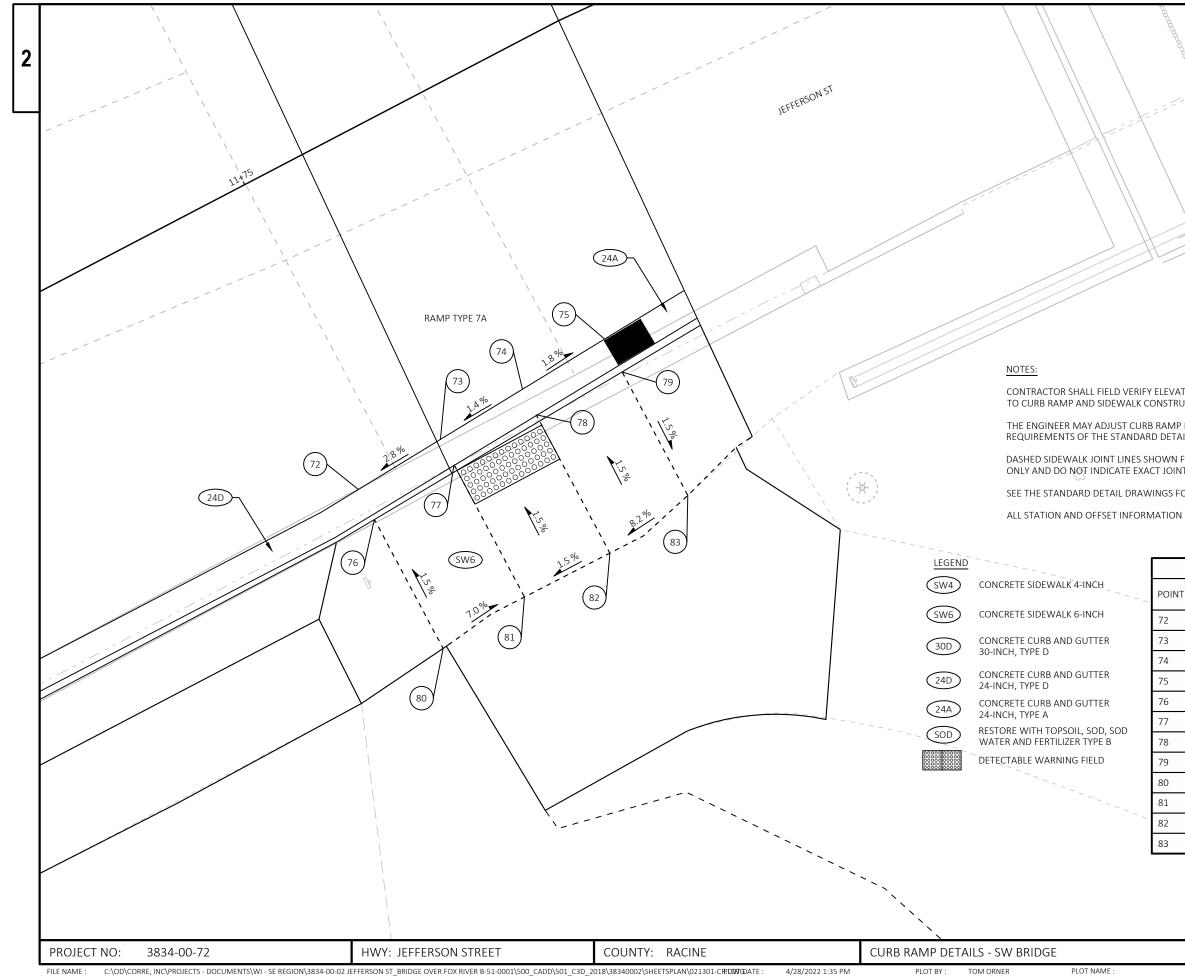
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CONTRACTOR SHALL FIELD VERIFY ELEVATIONS, GRADES, SLOPES, LENGTHS AND MATCH POINTS PRIOR TO CURB RAMP AND SIDEWALK CONSTRUCTION.

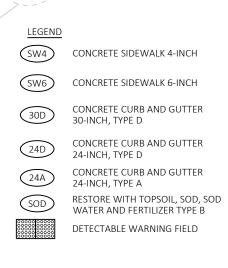THE ENGINEER MAY ADJUST CURB RAMP ELEVATIONS TO FIT FIELD CONDITIONS WITHIN THE REQUIREMENTS OF THE STANDARD DETAILS.

DASHED SIDEWALK JOINT LINES SHOWN FOR PROPOSED SIDEWALK ARE FOR INFORMATIONAL PURPOSES ONLY AND DO NOT INDICATE EXACT JOINT LOCATIONS.

SEE THE STANDARD DETAIL DRAWINGS FOR COMPLETE CURB RAMP REQUIREMENTS.

ALL STATION AND OFFSET INFORMATION REFERENCE JEFFERSON ST.

COUNTY: RACINE PROJECT NO: 3834-00-72 HWY: JEFFERSON STREET CURB RAMP DETAILS - NW CORNER PLOT BY : TOM ORNER

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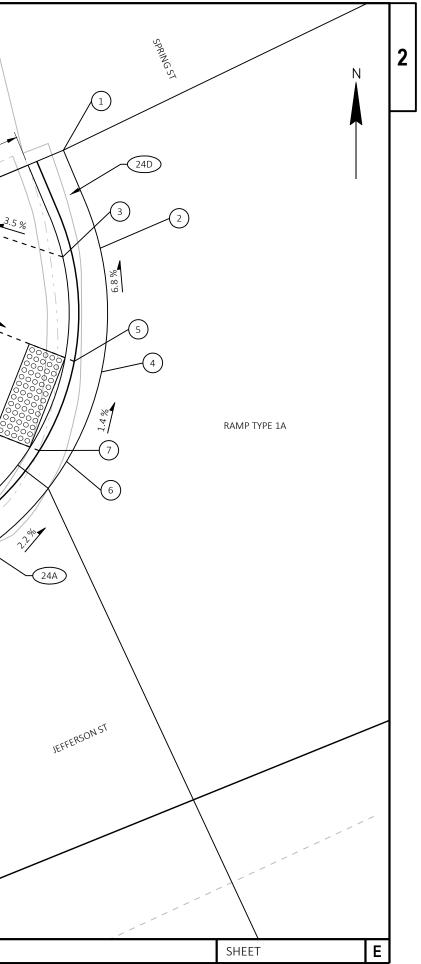
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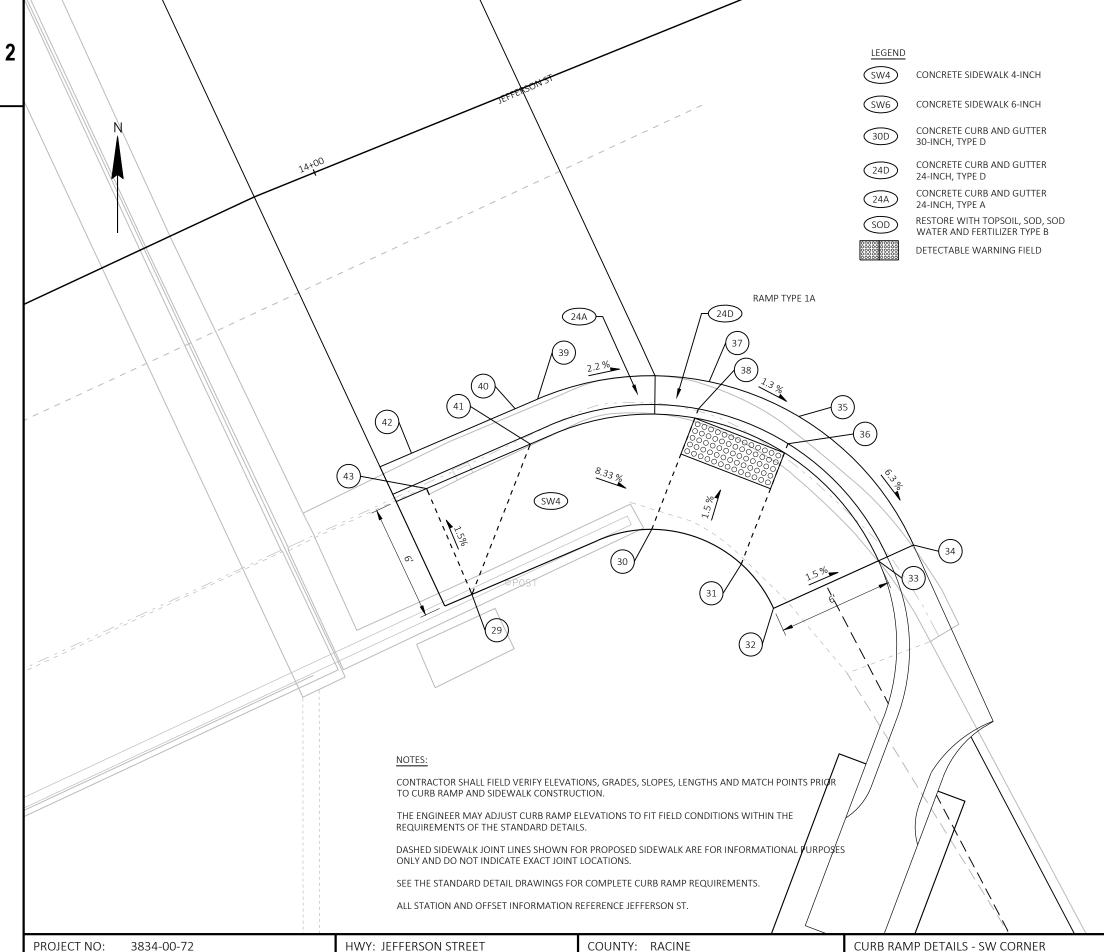
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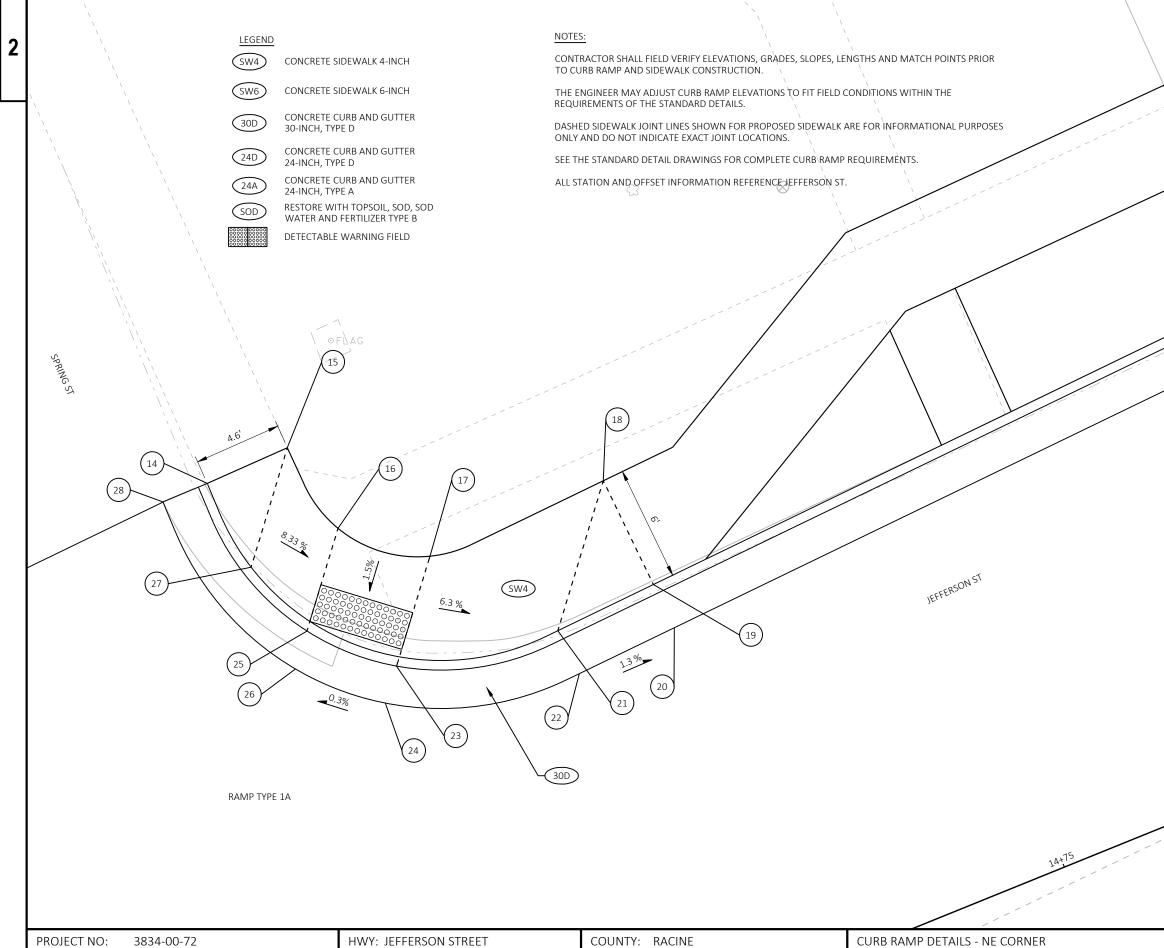
		\backslash								
	STATION & OFFSET TABLE									
POINT	STATION	OFFSET	Y COORDS	X COORDS	ELEVATION					
29	13+99.35	23.44 RT	169002.524	508637.631	761.74					
30	14+09.29	23.82 RT	169005.905	508646.988	760.93					
31	14+12.93	27.25 RT	169004.096	508651.649	760.85					
32	14+13.62	30.01 RT	169001.794	508653.329	760.79					
33	14+19.62	29.77 RT	169004.270	508658.794	760.70					
34	14+21.62	29.69 RT	169005.095	508660.616	760.26					
35	14+18.59	21.24 RT	169011.789	508654.634	760.82					
36	14+17.54	22.35 RT	169010.369	508654.083	760.76					
37	14+14.95	17.81 RT 169013.598 508649.973	7.81 RT 169013.598 508649.973	508649.973	760.89					
38	14+13.90	18.92 RT	169012.177	508649.421	760.83					
39	14+06.33	15.30 RT	169012.691	508641.041	761.09					
40	14+05.07	15.33 RT	169012.193	508639.881	761.11					
41	14+05.11	17.33 RT	169010.355	508640.670	761.53					
42	13+99.19	15.44 RT	169009.876	508634.478	760.97					
43	13+99.23	17.44 RT	169008.038	508635.266	761.65					

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WISDOT/CADDS SHEET 42

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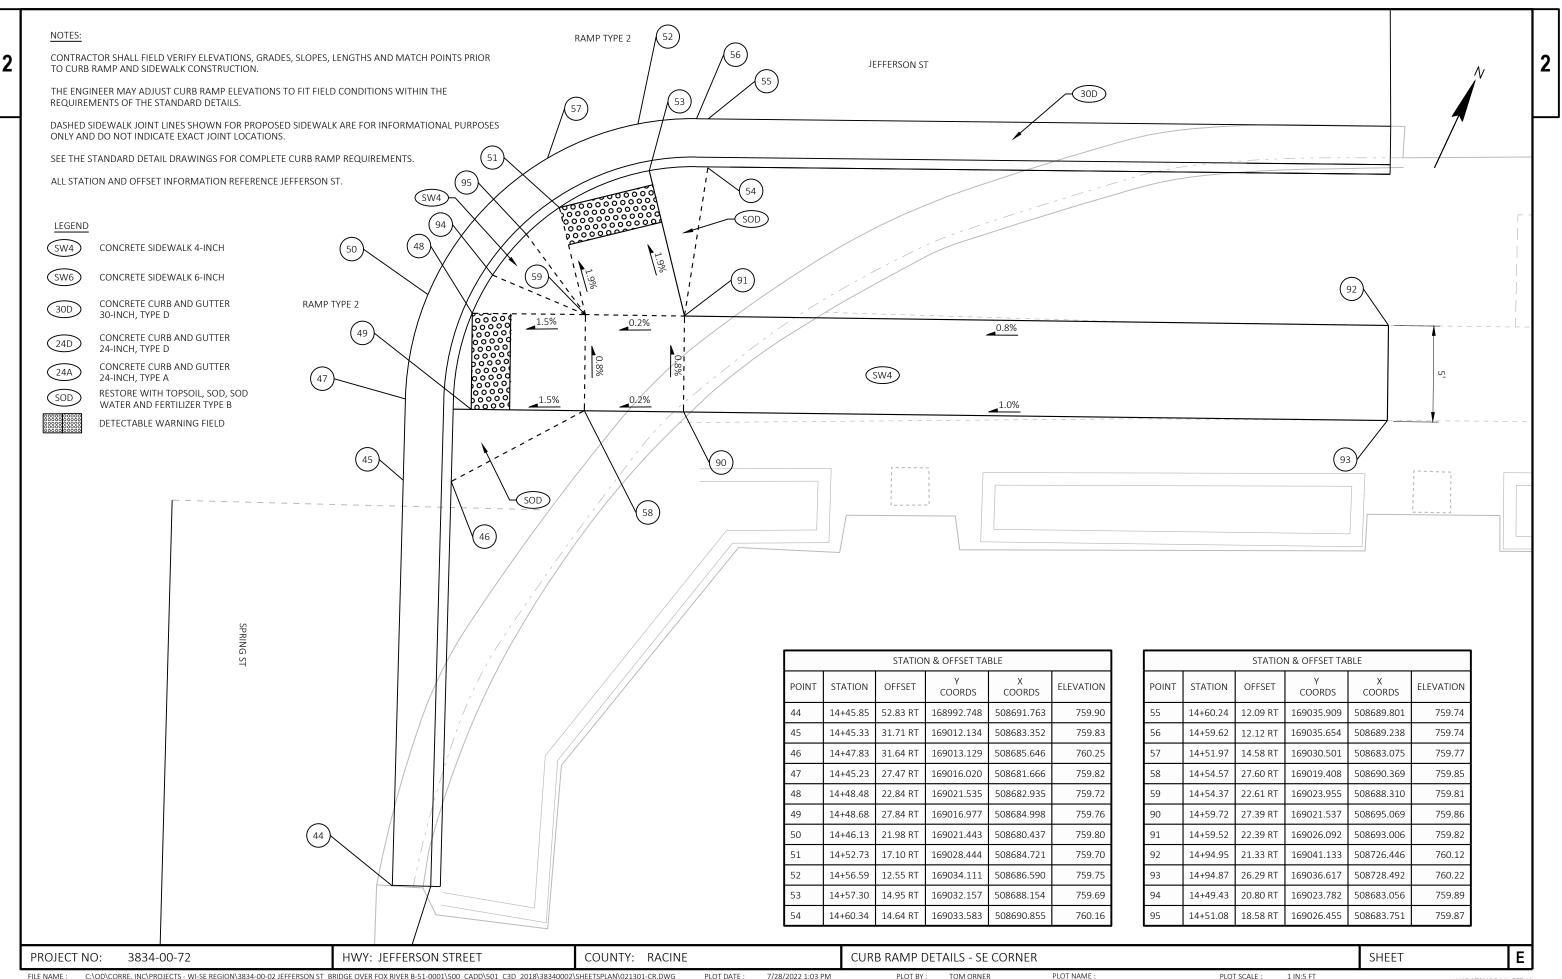
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POINT 14	STATION 14+41.12		Y	х	ELEVATION 760.33	
		OFFSET	Y COORDS	X COORDS		
14	14+41.12	OFFSET 35.29 LT	Y COORDS 169072.642	X COORDS 508654.294	760.33	
14 15	14+41.12 14+45.69	OFFSET 35.29 LT 35.44 LT	Y COORDS 169072.642 169074.498	X COORDS 508654.294 508658.468	760.33 760.33	
14 15 16	14+41.12 14+45.69 14+46.56	OFFSET 35.29 LT 35.44 LT 30.56 LT	Y COORDS 169072.642 169074.498 169070.302	X COORDS 508654.294 508658.468 508661.109	760.33 760.33 760.08	
14 15 16 17	14+41.12 14+45.69 14+46.56 14+50.45	OFFSET 35.29 LT 35.44 LT 30.56 LT 27.42 LT	Y COORDS 169072.642 169074.498 169070.302 169068.851	X COORDS 508654.294 508658.468 508661.109 508665.894	760.33 760.33 760.08 760.11	
14 15 16 17 18	14+41.12 14+45.69 14+46.56 14+50.45 14+60.29	OFFSET 35.29 LT 35.44 LT 30.56 LT 27.42 LT 27.67 LT	Y COORDS 169072.642 169074.498 169070.302 169068.851 169072.778	X COORDS 508654.294 508658.468 508661.109 508665.894 508674.923	760.33 760.33 760.08 760.11 760.62	
14 15 16 17 18 19	14+41.12 14+45.69 14+46.56 14+50.45 14+60.29 14+60.69	OFFSET 35.29 LT 35.44 LT 30.56 LT 27.42 LT 27.67 LT 21.68 LT	Y COORDS 169072.642 169074.498 169070.302 169068.851 169067.376	X COORDS 508654.294 508658.468 508661.109 508665.894 508674.923 508677.534	760.33 760.33 760.08 760.11 760.62 760.49	
14 15 16 17 18 19 20	14+41.12 14+45.69 14+46.56 14+50.45 14+60.29 14+60.85	OFFSET 35.29 LT 35.44 LT 30.56 LT 27.42 LT 27.67 LT 21.68 LT 19.18 LT	Y COORDS 169072.642 169074.498 169070.302 169068.851 169072.778 169067.376 169065.125	X COORDS 508654.294 508658.468 508661.109 508665.894 508674.923 508677.534 508678.622	760.33 760.33 760.08 760.11 760.62 760.49 760.07	
14 15 16 17 18 19 20 21	14+41.12 14+45.69 14+46.56 14+50.45 14+60.29 14+60.69 14+60.85 14+55.17	OFFSET 35.29 LT 35.44 LT 30.56 LT 27.42 LT 27.67 LT 21.68 LT 19.18 LT 21.32 LT	Y COORDS 169072.642 169074.498 169070.302 169068.851 169067.376 169065.125 169064.968	X COORDS 508654.294 508658.468 508661.109 508665.894 508674.923 508677.534 508678.622	760.33 760.33 760.08 760.11 760.62 760.49 760.07 760.55	
14 15 16 17 18 19 20 21 22	14+41.12 14+45.69 14+46.56 14+50.45 14+60.29 14+60.85 14+60.85 14+55.17 14+55.36	OFFSET 35.29 LT 35.44 LT 30.56 LT 27.42 LT 27.67 LT 21.68 LT 19.18 LT 21.32 LT 18.82 LT	Y COORDS 169072.642 169074.498 169070.302 169068.851 169067.376 169065.125 169064.968 169062.731	X COORDS 508654.294 508658.468 508661.109 508665.894 508674.923 508677.534 508678.622 508672.554 508673.670	760.33 760.33 760.08 760.11 760.62 760.49 760.07 760.55 760.13	
14 15 16 17 18 19 20 21 22 23 24	14+41.12 14+45.69 14+46.56 14+50.45 14+60.29 14+60.85 14+60.85 14+55.36 14+55.36 14+45.43	OFFSET 35.29 LT 35.44 LT 27.42 LT 27.42 LT 27.67 LT 21.68 LT 19.18 LT 21.32 LT 18.82 LT 22.76 LT 21.20 LT	Y COORDS 169072.642 169074.498 169070.302 169068.851 169067.376 169067.376 169065.125 169064.968 169062.731 169063.123 169061.198	X COORDS 508654.294 508658.468 508661.109 508665.894 508677.534 508677.534 508672.554 508672.554 508673.670 508664.156 508663.572	760.33 760.33 760.08 760.11 760.62 760.49 760.07 760.55 760.13 760.02 760.10	
14 15 16 17 18 19 20 21 22 23 23 24 25	14+41.12 14+45.69 14+46.56 14+50.45 14+60.29 14+60.69 14+60.85 14+55.17 14+55.36 14+45.43 14+45.43 14+43.05	OFFSET 35.29 LT 35.44 LT 30.56 LT 27.42 LT 27.67 LT 21.68 LT 19.18 LT 21.32 LT 18.82 LT 22.76 LT 21.20 LT 26.21 LT	Y COORDS 169072.642 169074.498 169070.302 169068.851 169067.376 169067.376 169065.125 169064.968 169062.731 169063.123 169061.198 169064.953	X COORDS 508654.294 508658.468 508661.109 508665.894 508677.534 508677.534 508672.554 508672.554 508663.670 508664.156 508663.572	760.33 760.33 760.08 760.11 760.62 760.49 760.7 760.55 760.13 760.02 760.02 760.10 760.00	
14 15 16 17 18 19 20 21 20 21 22 23 24 25 26	14+41.12 14+45.69 14+46.56 14+50.45 14+60.29 14+60.69 14+60.85 14+55.17 14+55.36 14+45.43 14+45.43 14+43.05 14+41.75	OFFSET 35.29 LT 35.44 LT 27.42 LT 27.42 LT 27.67 LT 21.68 LT 19.18 LT 21.32 LT 18.82 LT 18.82 LT 22.76 LT 21.20 LT 24.60 LT	Y COORDS 169072.642 169074.498 169070.302 169068.851 169067.376 169067.376 169065.125 169064.968 169064.968 169063.123 169061.198 169064.953 169062.976	X COORDS 508654.294 508658.468 508661.109 508665.894 508677.534 508677.534 508672.554 508672.554 508663.572 508663.572 508659.487	760.33 760.33 760.08 760.11 760.62 760.49 760.07 760.55 760.13 760.02 760.10 760.00 760.00	
14 15 16 17 18 19 20 21 22 23 23 24 25	14+41.12 14+45.69 14+46.56 14+50.45 14+60.29 14+60.69 14+60.85 14+55.17 14+55.36 14+45.43 14+45.43 14+43.05	OFFSET 35.29 LT 35.44 LT 30.56 LT 27.42 LT 27.67 LT 21.68 LT 19.18 LT 21.32 LT 18.82 LT 22.76 LT 21.20 LT 26.21 LT	Y COORDS 169072.642 169074.498 169070.302 169068.851 169067.376 169067.376 169065.125 169064.968 169062.731 169063.123 169061.198 169064.953	X COORDS 508654.294 508658.468 508661.109 508665.894 508677.534 508677.534 508672.554 508672.554 508663.670 508664.156 508663.572	760.33 760.33 760.08 760.11 760.62 760.49 760.7 760.55 760.13 760.02 760.02 760.10 760.00	


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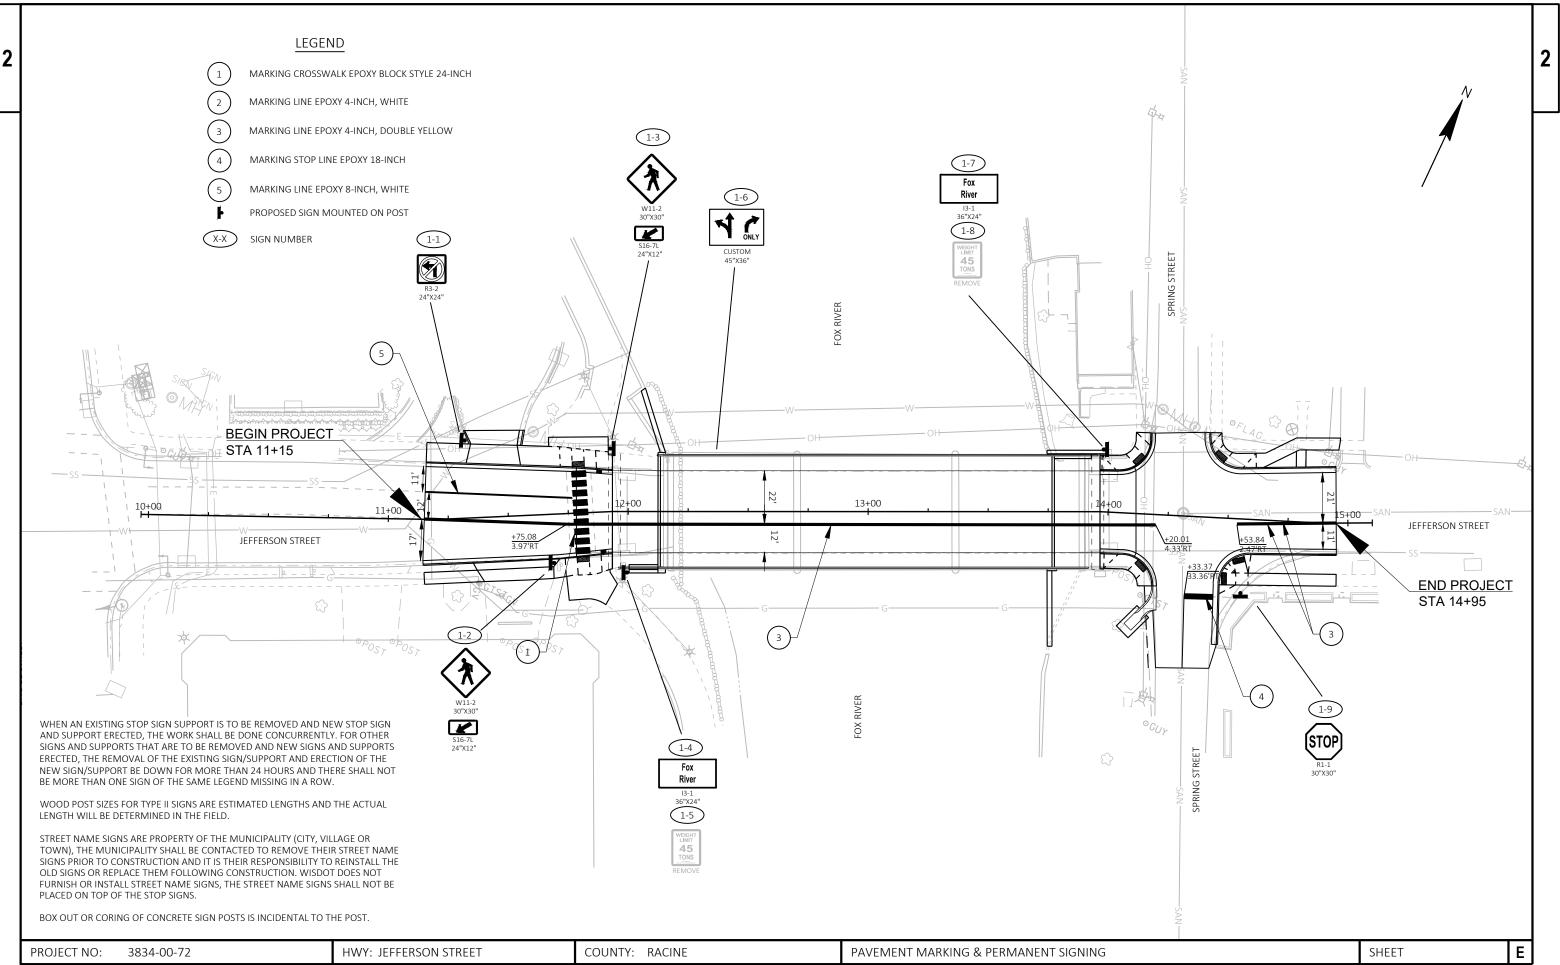
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PLOT BY :


PLOT NAME






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FILE NAME :	C:\OD\CORRE, INC\PROJECTS - WI-SE REGION\3834-00-02 JEFFERSON ST B	RIDGE OVER FOX RIVER B-51-0001\500 CADD\501 C3D 2018\38340002\	\SHEETSPLAN\024501-PM.DWG	PLOT DATE :	9/7/2022 10:57 AM	PLOT BY :	JESSICA LEWIS, PE	
		· _ · · .					,	
	LAYOUT NAME - 01							

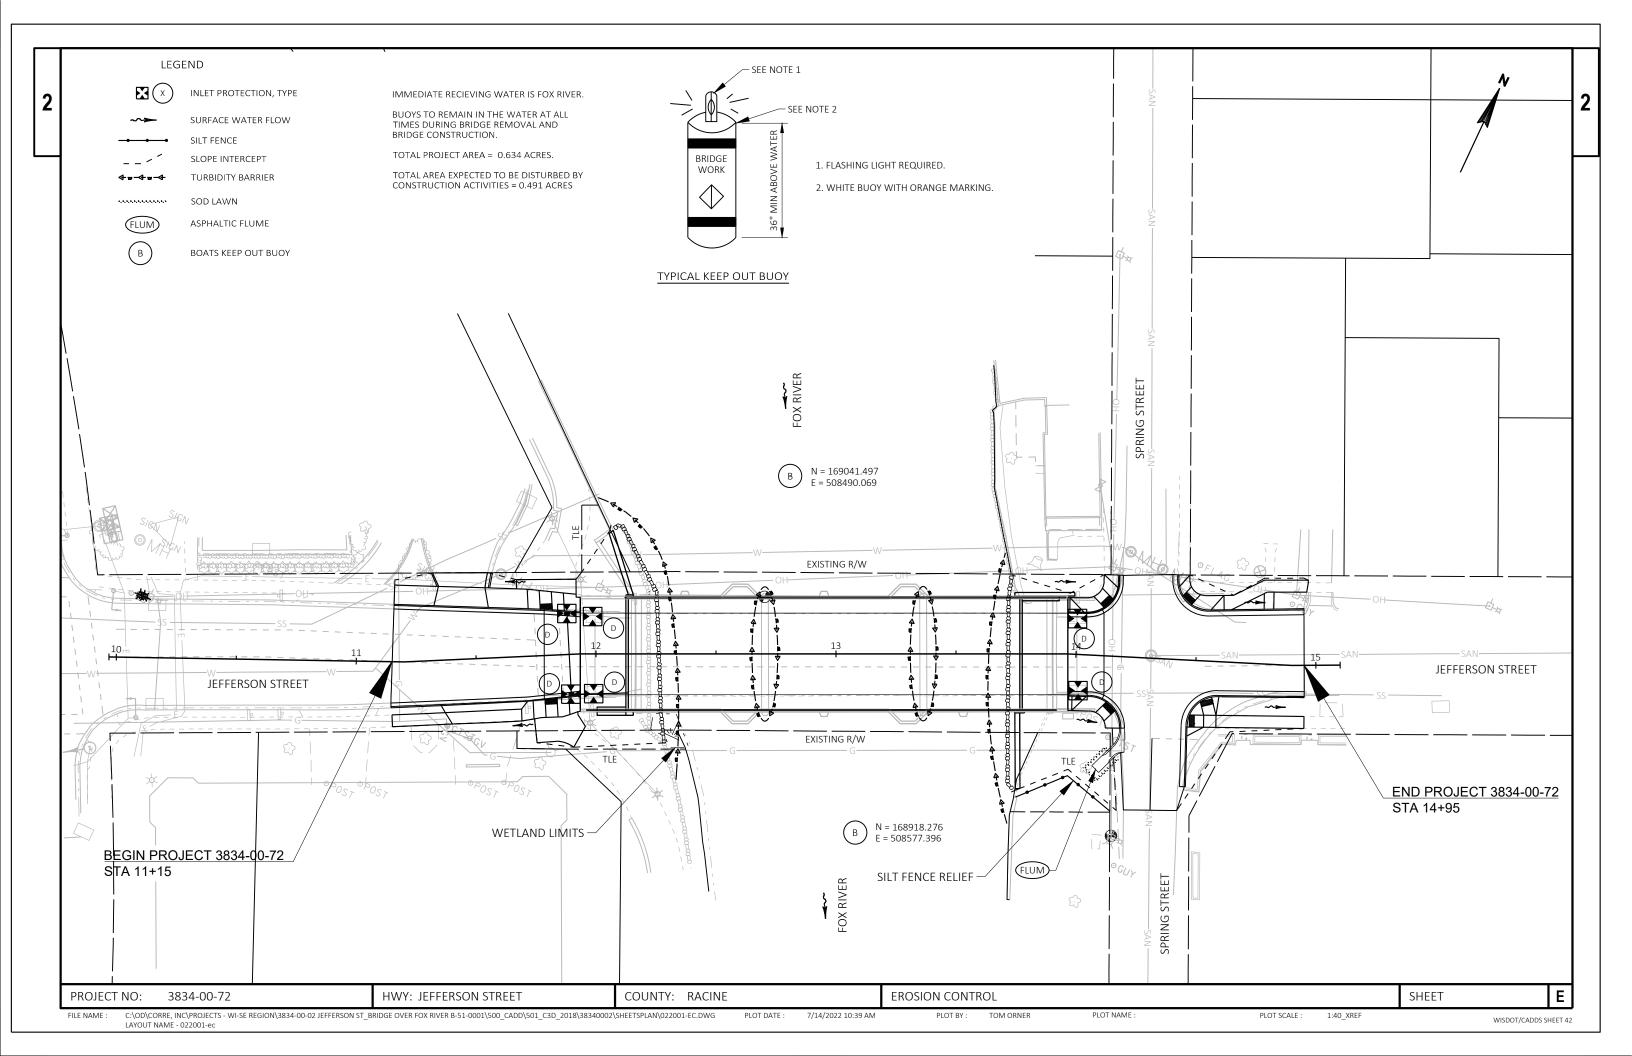PLOT NAME :

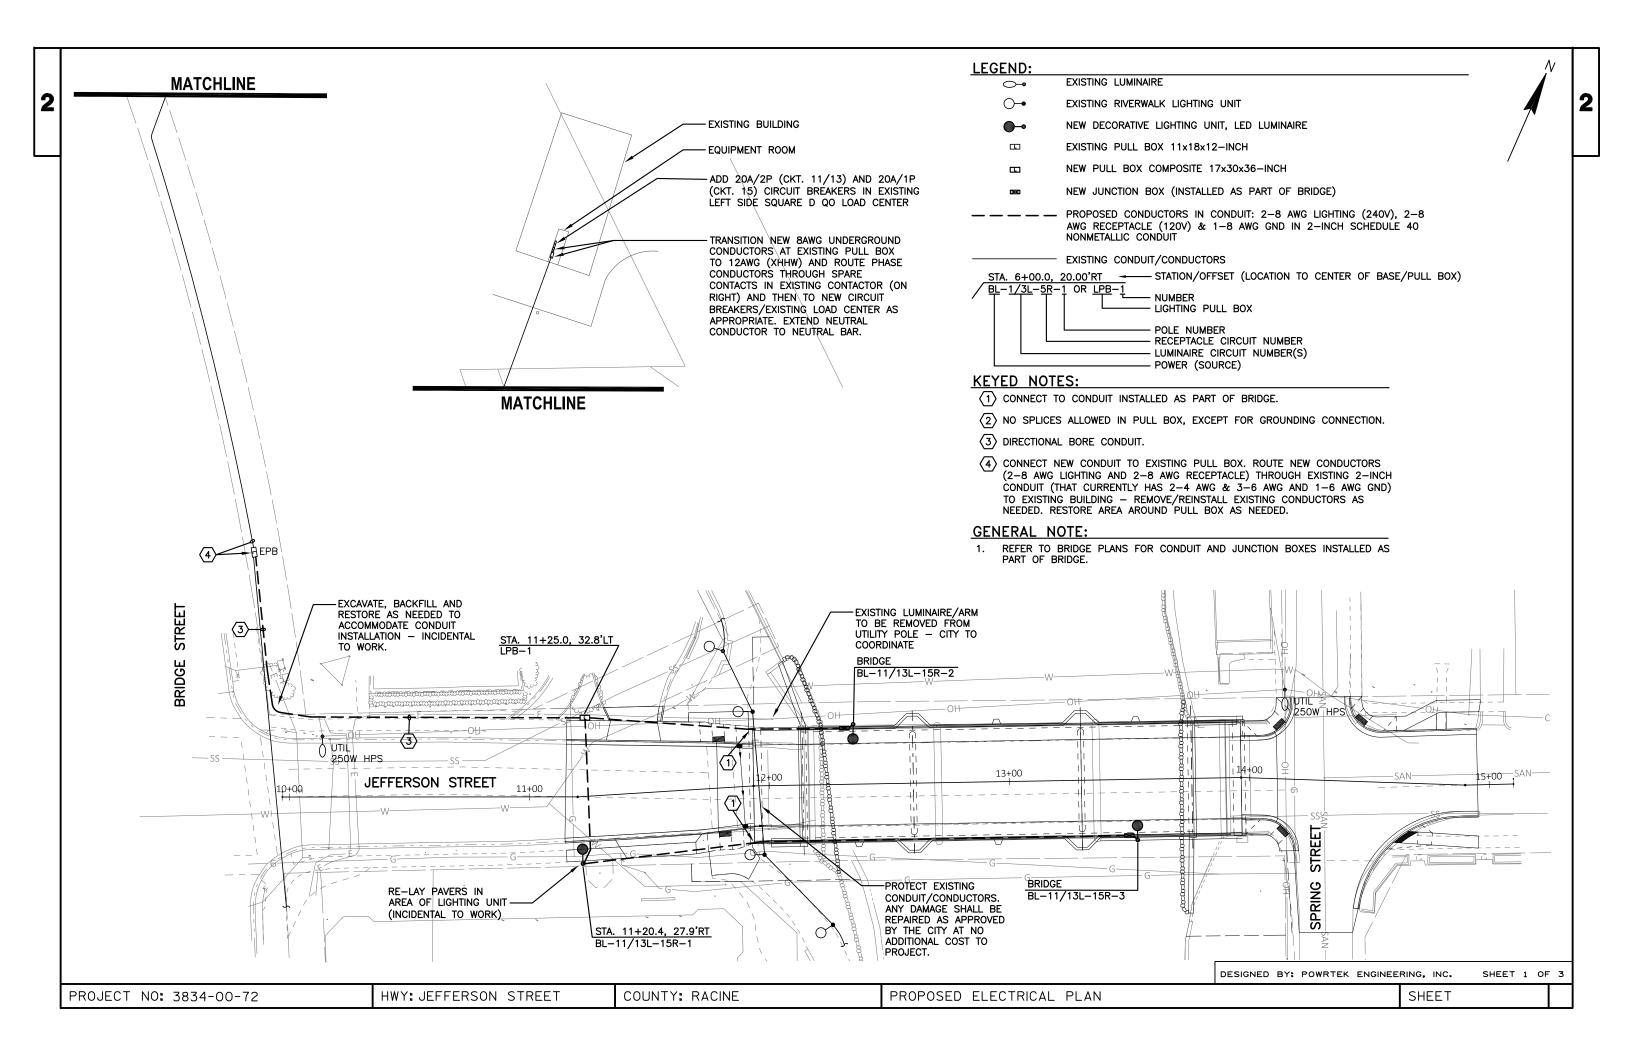

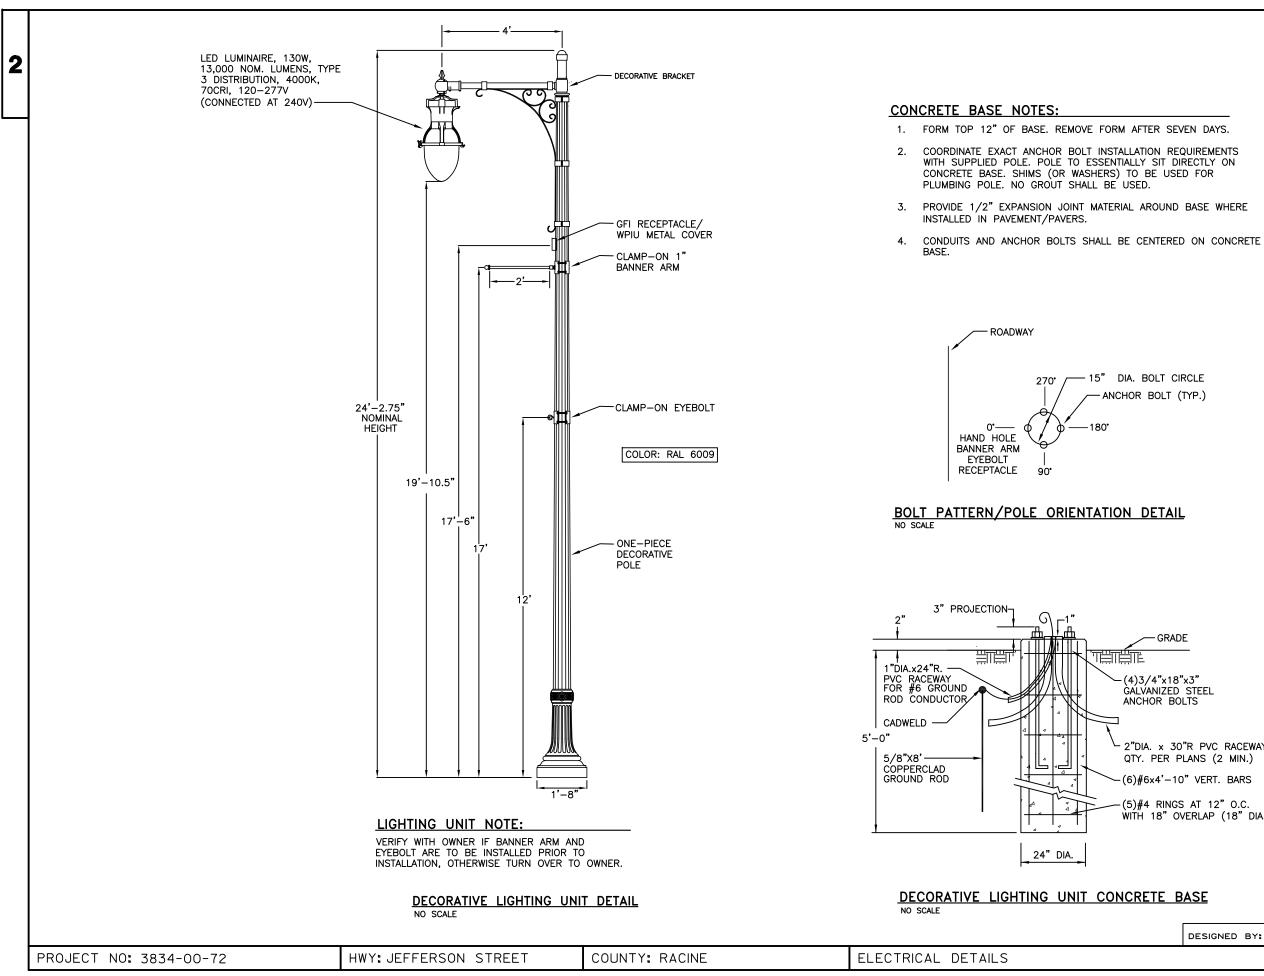

GRADE


- 2"DIA. x 30"R PVC RACEWAYS, QTY. PER PLANS (2 MIN.)

-(6)#6×4'-10" VERT. BARS

-(5)#4 RINGS AT 12" O.C. WITH 18" OVERLAP (18" DIA.)

DESIGNED	BY:	POWRTEK	ENGINEE	RING,	INC.	SHEET	2 0	۶F	3
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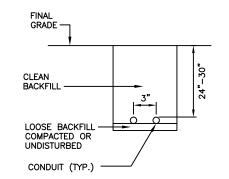
2

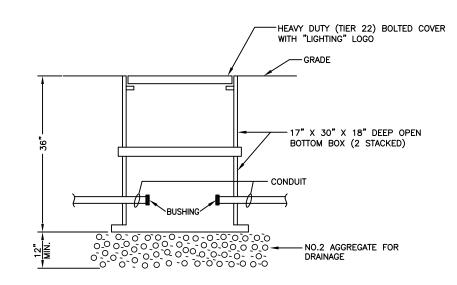

### **NOTES**

- PULLBOX IS A CONCRETE COMPOSITE, UL LISTED, QUAZITE PG SERIES.
   SHIM BETWEEN SECTIONS AS REQUIRED SO BOX IS LEVEL WITH FINAL GRADE.
   SEAL ALL OPENINGS IN BOX FOR DUCT/CONDUIT.
   WHERE SPLICES OCCUR IN PULL BOX PER PLANS, PROVIDE MULTI-CABLE COMPRESSION CONNECTOR ENCASED IN SCOTCHCAST 85 SERIES MULTI-MOLD PERMANENT RESIN COMPOUND.
   LEAVE 6-ET OF SLACK IN CONDUCTORS IN PULL
- 5. LEAVE 6-FT OF SLACK IN CONDUCTORS IN PULL BOX.
- 6. ALL CONDUCTORS TO HAVE A CIRCUIT TAG AS DESCRIBED UNDER POLE WIRING DETAIL.


# PULL BOX DETAIL




NOTE:

1. CONDUIT SHALL BE TRENCHED OR DIRECTIONAL BORED AS REQUIRED.

TRENCH FOR CONDUIT DETAIL NO SCALE

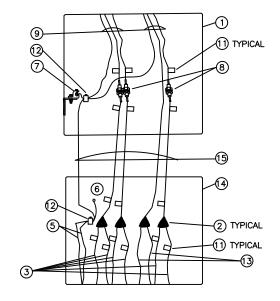

### BRIDGE MOUNTED POLE WIRING DETAIL NO SCALE

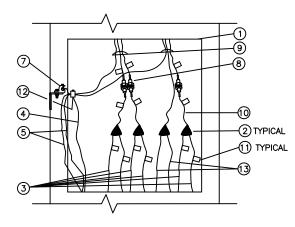


GROUND MOUNTED POLE WIRING DETAIL NO SCALE

PROJECT NO: 3834-00-72	HWY: JEFFERSON STREET	COUNTY: RACINE	ELECTRICAL DETAILS
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# POLE WIRING NOTES:

- 1 POLE HAND HOLE AND COVER
- (2) INSULATED SPLICE
- (3) UNGROUNDED (CIRCUIT) CONDUCTOR
- 4 #6 CONDUCTOR TO GROUND ROD
- (5) SYSTEM GROUNDING CONDUCTORS
- 6 BOND JUNCTION BOX
- (7) GROUNDING LUG
- (8) INLINE 1-POLE OR 2-POLE FUSE ASSEMBLY AND 5AMP FAST ACTING FUSES. WEATHERPROOF BOOTS.
- (9) 3-12 AWG XHHW (XLP) TO LUMINAIRE OR RECEPTACLE
- 12" PIGTAIL BETWEEN SPLICE AND FUSE ASSEMBLY
- 1 CIRCUIT TAG
- 12 REVERSIBLE PRESSURE OR COMPRESSION GROUNDING CONNECTION (NOT INSULATED)
- (3) GROUNDED (NEUTRAL) CONDUCTOR
- (1) BRIDGE JUNCTION BOX
- (5) 5-12 AWG XHHW (XLP)

DESIGNED BY: POWRTEK ENGINEE	RING, INC. SHEET 3 O	- 3
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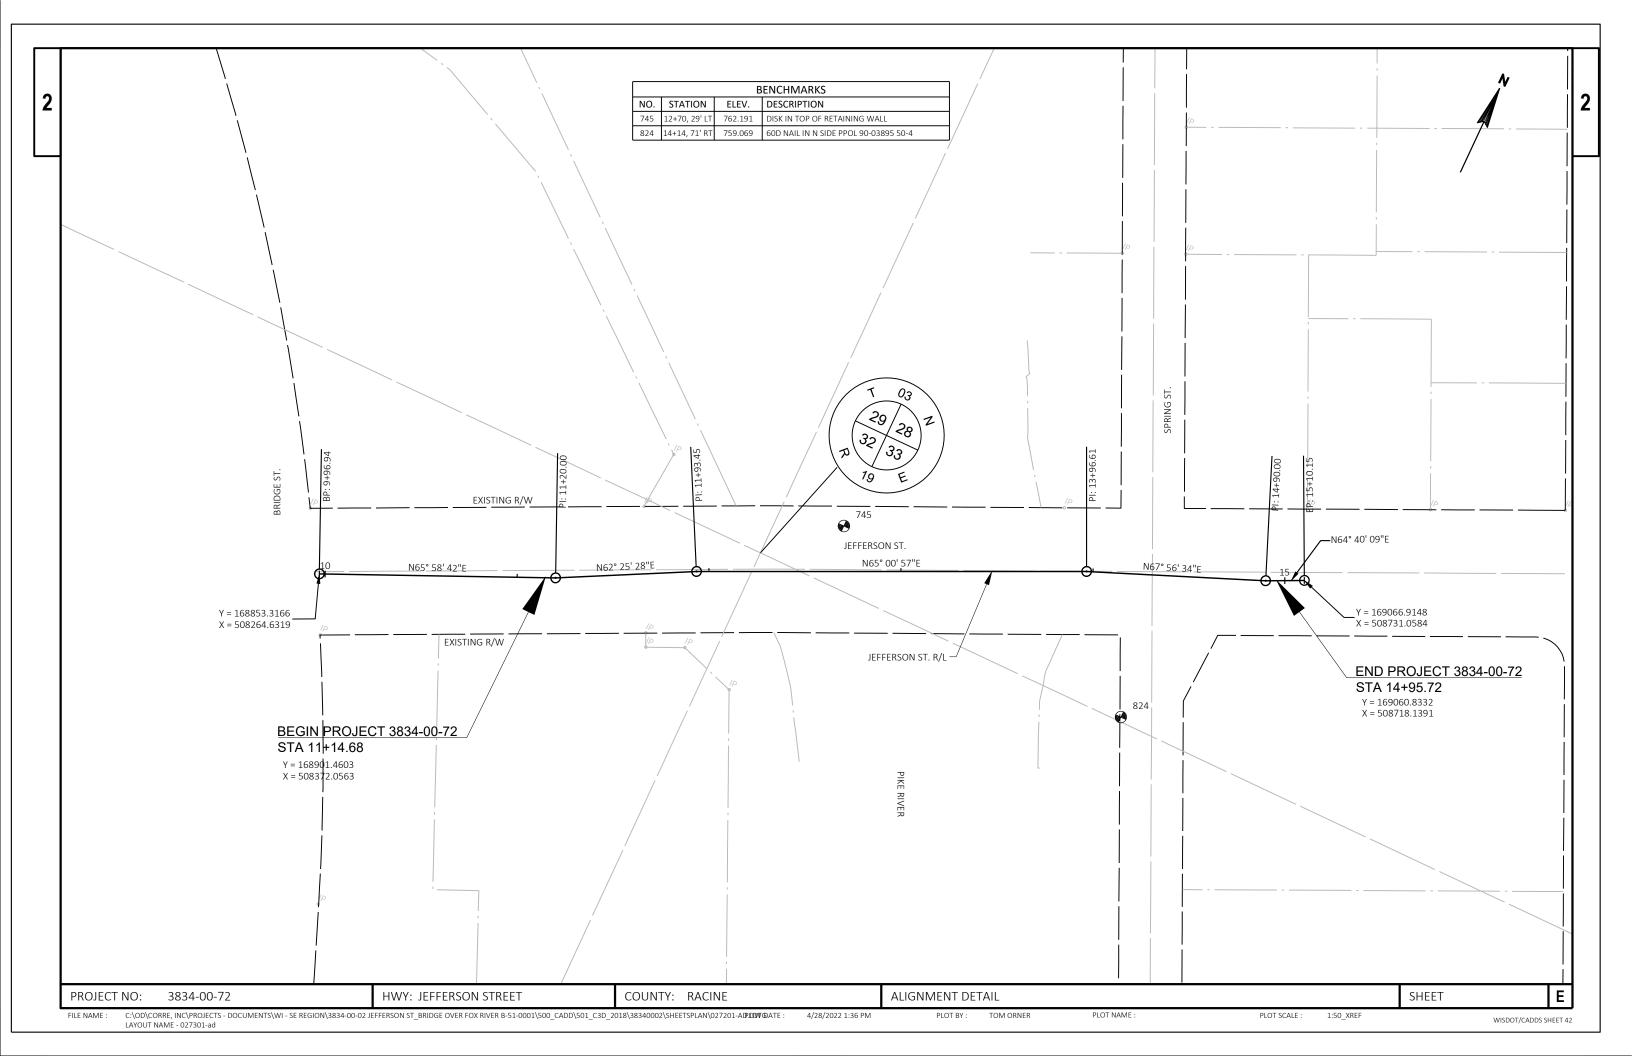
C:\OD\CORRE, INC\PROJECTS - DOCUMENTS\WI - SE REGION\3834-00-02 JEFFERSON ST_BRIDGE OVER FOX RIVER B-51-0001\500_CADD\501_C3D_2018\38340002\SHEETSPLAN\027001-DPDVCDATE : FILE NAME : 4/28/2022 1:36 PM PLOT BY : TOM ORNER LAYOUT NAME - 01

PROJECT NO: 3834-00-72	HWY: JEFFERSON STREET	COUNTY: RACINE D18\38340002\SHEETSPLAN\027002-DT_PED.DWG PLOT DATE : 6/2	PEDESTRIAN DETOUR PLAN           (2022 11:23 AM         PLOT BY : TOM ORNER         PLOT NAME	:
			ADAMS ST.	
R9-11 (MOD) 24"X12"			E.STATEST.	1=1
TYPE II BARRICADE R9-11 (MOD) 24"X12"				37
R9-9 30" X 18" SIDEWALK CLOSED		2 parest	N. DODDEE ST.	11
		Z. B.	N. BRIDGEST.	
→ DIRECTION OF TRAFFIC			E. JEFFERSON ST.	
TYPE II BARRICADE WTH ATTACHED	SIGN			At
LEGEND TYPE II BARRICADE				
				N. SPRINGST.
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> FILE NAME : C:\OD\CORRE, INC\PROJECTS - WI-SE REGION\3834-00-02 JEFFERSON ST_BRIDGE OVER FOX RIVER B-51-0001\500_CADD\501_C3D_2018\38340002\SHEETSPLAN\027002-DT_PED.DWG PLOT DATE : 6/2/2022 11:23 AM LAYOUT NAME - 01 PLOT BY : TOM ORNER

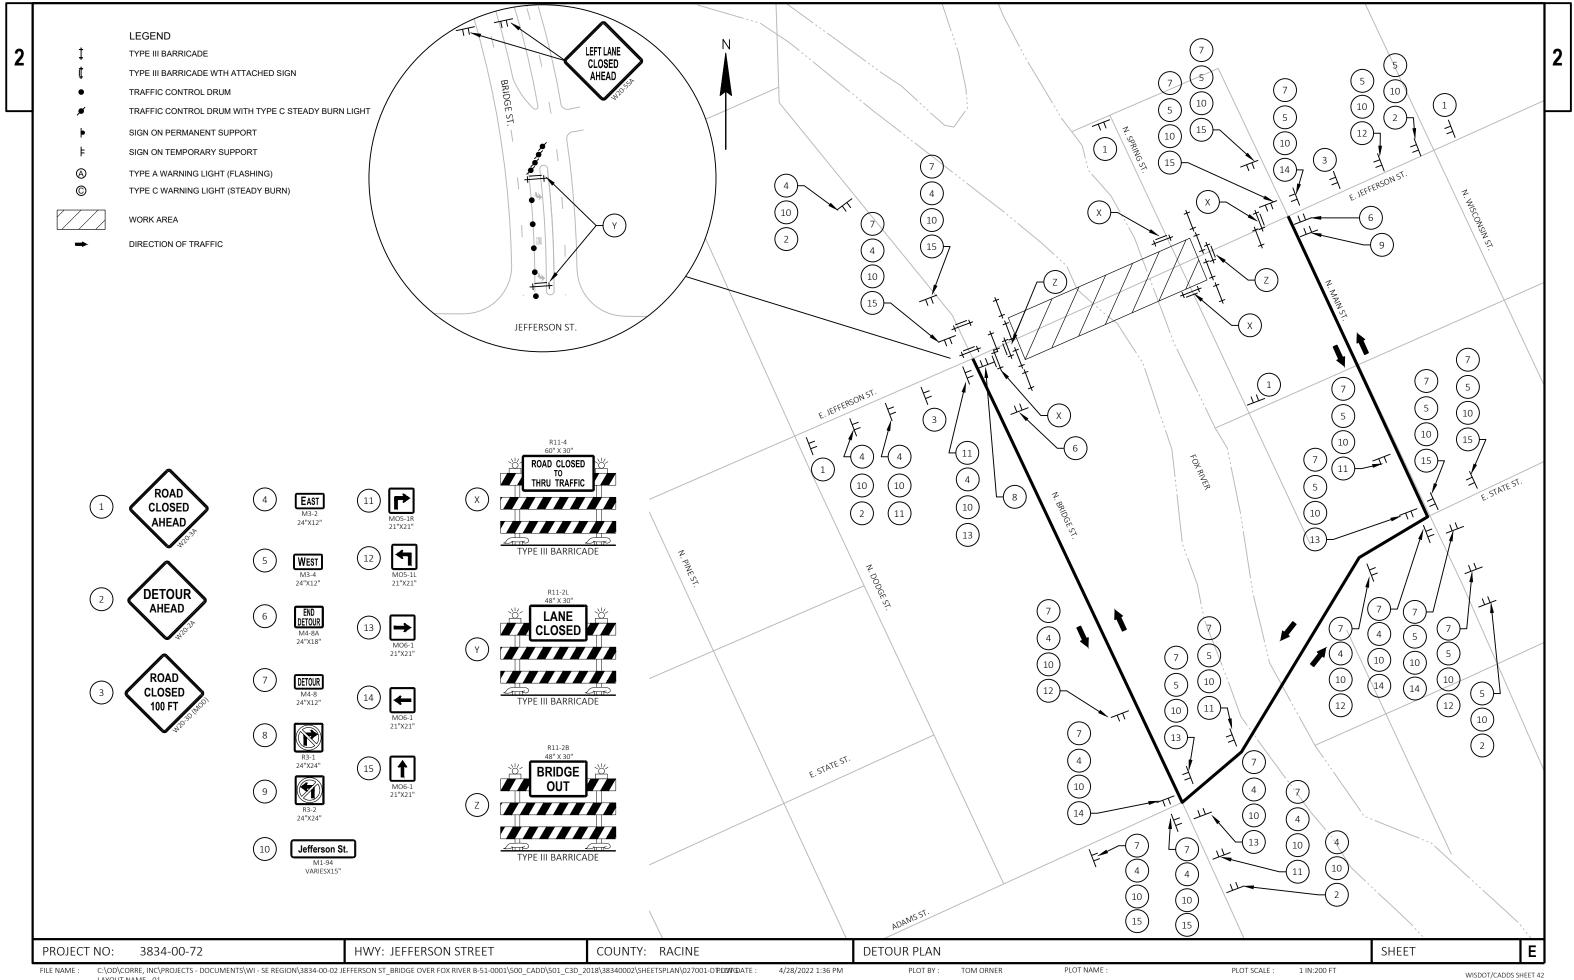



3
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Estimate Of Quantities

					3834-00-72
Line	Item	Item Description	Unit	Total	Qty
0002	203.0260	Removing Structure Over Waterway Minimal Debris (structure) 01. B-51-154	EACH	1.000	1.000
004	204.0100	Removing Concrete Pavement	SY	887.000	887.000
0006	204.0130	Removing Curb	LF	6.000	6.000
8000	204.0150	Removing Curb & Gutter	LF	364.000	364.000
0010	204.0155	Removing Concrete Sidewalk	SY	245.000	245.000
0012	204.0220	Removing Inlets	EACH	2.000	2.000
0014	204.0245	Removing Storm Sewer (size) 01. 12-Inch	LF	31.000	31.000
0016	205.0100	Excavation Common	CY	494.000	494.000
0018	206.1000	Excavation for Structures Bridges (structure) 01. B-51-0154	LS	1.000	1.000
0020	206.5001	Cofferdams (structure) 01. B-51-154	EACH	2.000	2.000
0022	210.1500	Backfill Structure Type A	TON	630.000	630.000
0024	213.0100	Finishing Roadway (project) 01. 3834-00-72	EACH	1.000	1.000
0026	305.0110	Base Aggregate Dense 3/4-Inch	TON	4.000	4.000
0028	305.0120	Base Aggregate Dense 1 1/4-Inch	TON	1,032.000	1,032.000
0030	415.0410	Concrete Pavement Approach Slab	SY	107.000	107.000
0032	416.0160	Concrete Driveway 6-Inch	SY	11.000	11.000
0034	455.0605	Tack Coat	GAL	91.000	91.000
0036	465.0105	Asphaltic Surface	TON	225.000	225.000
0038	465.0120	Asphaltic Surface Driveways and Field Entrances	TON	2.000	2.000
0040	465.0315	Asphaltic Flumes	SY	9.000	9.000
0042	502.0100	Concrete Masonry Bridges	CY	1,228.000	1,228.000
0044	502.3200	Protective Surface Treatment	SY	1,010.000	1,010.000
0046	502.3210	Pigmented Surface Sealer	SY	55.000	55.000
0048	502.9000.S	Underwater Substructure Inspection (structure) 01. B-51-154	EACH	2.000	2.000
0050	505.0400	Bar Steel Reinforcement HS Structures	LB	14,810.000	14,810.000
0052	505.0600	Bar Steel Reinforcement HS Coated Structures	LB	137,490.000	137,490.000
0052	505.0800.S	Bar Steel Reinforcement HS Stainless Structures	LB	450.000	450.000
0056	511.1200	Temporary Shoring (structure) 01. B-51-154	SF	600.000	600.000
0058	513.7016	Railing Steel Type C3	LF	412.000	412.000
0060	513.8016	Railing Steel Pedestrian Type C3 01. B-51-154	LF	29.000	29.000
0062	516.0500	Rubberized Membrane Waterproofing	SY	29.000	29.000
0064		Concrete Staining (structure) 01. B-51-154	SF	3,080.000	3,080.000
0066		Concrete Staining Multi-Color (structure) 01. B-51-154	SF	3,050.000	3,050.000
0068		Architectural Surface Treatment (structure) 01. B-51-154	SF	3,050.000	3,050.000
0000	531.8990	Anchor Assemblies Poles on Structures	EACH	2.000	2.000
0070	550.0010	Pre-Boring Unconsolidated Materials	LF	1,051.000	1,051.000
0072	550.0010	Pre-Boring Onconsolidated Materials	LF	365.000	365.000
		-	LF		
0076	550.1120 601.0110	Piling Steel HP 12-Inch X 53 Lb	LF	1,980.000	1,980.000
0078		Concrete Curb Type D		6.000	6.000
0080	601.0411	Concrete Curb & Gutter 30-Inch Type D	LF	134.000	134.000
0082	602.0405	Concrete Sidewalk 4-Inch	SF	814.000	814.000
0084	602.0415	Concrete Sidewalk 6-Inch	SF	1,388.000	1,388.000
0086	602.0505	Curb Ramp Detectable Warning Field Yellow	SF	50.000	50.000
0088	602.0605	Curb Ramp Detectable Warning Field Radial Yellow	SF	17.000	17.000
0090	606.0300	Riprap Heavy	CY	120.000	120.000
0092	608.0512	Storm Sewer Pipe Reinforced Concrete Class V 12-Inch	LF	58.000	58.000
0094	611.0639	Inlet Covers Type H-S	EACH	2.000	2.000
0096	611.1230	Catch Basins 2x3-FT	EACH	2.000	2.000
0098	611.8115	Adjusting Inlet Covers	EACH	2.000	2.000




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Estimate Of Quantities

04         619 1000         Mobilization         EACH         1.000         1.000           06         624 0100         Water         MGAL         10.000         309.000         309.000         309.000         309.000         309.000         309.000         309.000         309.000         625.010         Topsoil         SY         14.000         14.000         14.000         14.000         14.000         630.000         630.000         630.000         630.000         630.000         16         628.190         Mobilizations Energency Erosion Control         EACH         3.000         3.000         3.
22         618 0100         Mointenance And Repair of Haul Roads (project) 01. 3834-00-72         EACH         1.000         0.000           66         624 0100         Wolf         1000         0.000           06         624 0100         Wolf         1000         0.000           06         624 0100         Wolf         10.000         10.000           06         624 0100         Wolf         10.000         10.000           06         625 0100         Topsoil         SY         14.000         14.000           10         627 0200         Mulching         SY         14.000         63.000           11         628 1905         Mobilizations Emergency Erosion Control         EACH         3.000         3.000           20         628 2006         Erosion Mat Urban Class IType B         SY         211.000         211.000           22         628 0050         Intel Protection Type D         EACH         15.000         15.000           23         630.0100         Seed Water         Quitable         2.000         3.000         3.000           24         628 0201         Fertilizer Type B         CWT         2.000         2.000           24         628 0210         Fertilize
02         618 0100         Mointenance And Repair of Haul Roads (project) 01. 3834-00-72         EACH         1.000         1.000           06         624 0100         Wder         MGAL         10.000         10.000           06         624 0100         Wder         MGAL         10.000         10.000           06         625 0100         Topsoil         SY         14.000         14.000           10         627 0200         Mulching         SY         14.000         63.000           11         628 1520         Silt Fence Maintenance         LF         63.000         63.000           14         628 1520         Mobilizations Erosion Control         EACH         3.000         3.000           20         628 0005         Erosion Mat Urban Class Type B         SY         211.000         121.000           22         628 0505         Intel Protection Type D         EACH         6.000         6.000           24         628 7570         Rock Bags         CWT         2.000         2.000           24         628 7570         Rock Bags         CWT         2.000         2.000           26         630.0100         Sod Lawn         Sod Sod         3.000         3.000
04         619 1000         Mobilization         EACH         1.000         1.000           06         624 0100         Water         MGAL         10.000         309.000           06         625 0100         Topsoil         SY         309.000         309.000           10         627.020         Mulching         SY         14.000         14.000           12         628.1504         Silt Fence         Silt Fence         63.000         63.000           16         628.1005         Mobilizations Emergency Erosion Control         EACH         3.000         3.000           18         628.1910         Mobilizations Emergency Erosion Control         EACH         6.000         6.000           26         628.070         Turbicity Barriers         SY         211.000         214.000           28         629.0210         Fertilizer Type D         EACH         15.000         15.000           28         629.0210         Fertilizer Type B         CWT         2.000         2.000           28         630.044         Seeding Mixture No. 40         LB         2.000         2.000           28         630.0140         Seeding Mixture No. 40.01         1.000         2.000         2.000
66         624.010         Water         MCAL         10.000         10.000           08         625.010         Topsoll         SY         309.000           10         627.0200         Mulching         SY         14.000         14.000           12         628.1504         Silf Fence Maintenance         LF         63.000         63.000           16         628.1905         Mobilizations Encregnory Erosion Control         EACH         3.000         3.000           20         628.2008         Erosion Mat Urban Class I Type B         SY         211.000         211.000           21         628.003         Turbidily Barriers         SY         374.000         36.000           22         628.003         Fortilizer Type D         EACH         6.000         6.000           26         629.020         Fertilizer Type B         CVT         2.000         2.000           26         630.0140         Seeding Mixture No.40         LB         2.000         2.000           26         631.0300         Sod Water         MGAL         3.000         3.000           36         634.0614         Posts Tubular Stele 2x2-Inch X 10-FT         EACH         2.000         2.000           26
98         625.0100         Topsoil         SY         309.000         309.000           10         627.0200         Mulching         SY         14.000           12         628.1504         Silt Fence         LF         63.000         63.000           14         628.1520         Silt Fence Maintenance         LF         63.000         63.000           16         628.1905         Mobilizations Enrogency Erosin Control         EACH         3.000         3.000           20         628.2008         Erosion Mat Urban Class I Type B         SY         374.000         374.000           22         628.6005         Turbitity Barriers         SY         374.000         374.000           22         628.0016         Fertilizer Type B         EACH         6.000         6.000           26         628.777         Rock Bags         EACH         15.000         15.000           26         630.0140         Seeding Mixture No.40         LB         2.000         2.000           26         630.0300         Sod Vater         MGAL         2.000         2.000           36         631.000         Sod Vater         Sign Stype II         4.60.00         1.000           26
10         627.020         Mulching         Y         14.000         14.000           12         628.1504         Silt Fence Maintenance         LF         63.000         63.000           14         628.1505         Mobilizations Encigency Erosion Control         EACH         3.000         3.000           16         628.1905         Mobilizations Encigency Erosion Control         EACH         3.000         3.000           16         628.2008         Erosion Mat Urban Class I Type B         SY         211.000         211.000           22         628.0057         Intel Protection Type D         EACH         6.000         6.000           26         629.020         Fertilizer Type B         EACH         15.000         15.000           26         629.020         Fertilizer Type B         CWT         2.000         2.000           30         630.010         Seeding Mixture No. 40         LB         2.000         2.000           31         631.000         Sod Uwar         MGAL         2.000         2.000           38         634.0614         Posts Wood 4x6-Inch X 14-FT         EACH         2.000         2.000           46         637.220         Signs Type II Reflective F         EACH         1.
12         628.1504         Silt Fence         LF         63.000         63.000           14         628.1520         Mobilizations Erosion Control         EACH         3.000         3.000           16         628.1910         Mobilizations Erosion Control         EACH         3.000         3.000           16         628.1910         Mobilizations Errosion Control         EACH         3.000         3.000           0         628.2008         Erosion Mat Urban Cliss I Type B         SY         374.000         374.000           22         628.6005         Turbidity Barriers         SY         374.000         15.000           26         628.770         Rock Bags         EACH         15.000         2.000           26         630.0500         Seed Water         MGAL         2.000         2.000           36         631.0300         Sod Water         MGAL         2.000         2.000           36         631.030         Sod Water         MGAL         2.000         2.000           36         631.030         Sod Water         SY         98.000         98.000           36         631.030         Sod Water         SY         98.000         2.000           634.0614 </td
14         628.1620         Silf Fence Maintenance         LF         63.000         63.000           16         628.1901         Mobilizations Errosion Control         EACH         3.000         3.000           20         628.2008         Errosion Mat Urban Class I Type B         SY         211.000         211.000           21         628.0005         Turbiful Barriers         SY         374.000         650.000           24         628.7020         Inlet Protection Type D         EACH         15.000         6.000           26         628.021         Fortilizer Type B         EACH         15.000         2.000           26         629.021         Fortilizer Type B         CWT         2.000         2.000           32         630.0500         Seed Water         MGAL         3.000         3.000           33         634.0100         Sod Lawn         SY         98.000         98.000           36         634.0810         Posts Tubular Steel 2x2-Inch X 10-FT         EACH         1.000         1.000           46         637.220         Signs Type II Reflective H         SF         27.250         27.250           46         638.202         Removing Small Sign Stype II         EACH         1.000
16         628.1905         Mobilizations Emergency Erosion Control         EACH         3.000         3.000           18         628.1910         Mobilizations Emergency Erosion Control         EACH         3.000         3.000           20         628.2008         Erosion Mat Urban Class IType B         SY         374.000         374.000           22         628.7570         Rock Bags         EACH         6.000         6.000           26         628.7577         Rock Bags         EACH         15.000         2.000           26         628.7577         Rock Bags         CWT         2.000         2.000           30         630.0500         Seed Water         MGAL         2.000         2.000           36         631.0300         Sod Water         MGAL         3.000         3.000           36         634.0614         Posts Tubular Steel 2x2-Inch X 10-FT         EACH         1.000         2.000           46         637.2210         Signs Type II Reflective F         SF         16.500         16.500           46         637.2220         Signs Type II         EACH         1.000         1.0000           46         637.2230         Signs Type II         EACH         1.000         1.0000<
18         628.1910         Mobilizations Emergency Erosion Control         EACH         3.000         3.000           20         628.2008         Erosion Mat Urban Class I Type B         SY         211.000         211.000           21         628.6005         Turbidity Barriers         SY         374.000         671.000           24         628.7020         Inlet Protection Type D         EACH         6.000         6.000           26         628.770         Rock Bags         EACH         15.000         15.000           28         629.0210         Fertilizer Type B         CWT         2.000         2.000           26         630.050         Seed Water         MGAL         2.000         2.000           26         630.050         Sed Water         MGAL         2.000         2.000           34         631.000         Sod Lawn         SQ         98.000         98.000           36         634.0614         Posts Wood 4x6-Inch X 14-FT         EACH         2.000         2.000           40         634.0614         Posts Tubular Steel 2x2-Inch X 12-FT         EACH         1.000         1.000           41         637.220         Signs Type II Reflective F         EACH         1.000 <td< td=""></td<>
20         628.2008         Erosion Mat Urban Class I Type B         SY         211.000         211.000           22         628.0005         Turbidity Barriers         SY         374.000         374.000           24         628.770         Rock Bags         EACH         6.000         6.000           26         628.770         Rock Bags         EACH         15.000         15.000           28         629.021         Fertilizer Type B         CWT         2.000         2.000           36         0.0100         Seeding Mixture No. 40         LB         2.000         2.000           32         630.0500         Seed Water         MGAL         3.000         3.000           36         631.0300         Sod Water         MGAL         2.000         2.000           46         631.030         Sod Water         MGAL         2.000         2.000           46         631.021         Posts Tubular Steel 2x2-Inch X 12-FT         EACH         2.000         2.000           42         634.0812         Posts Tubular Steel 2x2-Inch X 12-FT         EACH         1.000         1.000           46         637.2210         Signs Type II Reflective F         SF         71.500         7.50      <
22         628.6005         Turbidity Barriers         SY         374.000         374.000           24         628.7020         Inlet Protection Type D         EACH         6.000         6.000           26         628.770         Rock Bags         EACH         15.000         2.000           28         629.0210         Fertilizer Type B         CWT         2.000         2.000           26         628.770         Rock Bags         MGAL         2.000         2.000           26         630.0140         Seeding Mixture No.40         LB         2.000         2.000           26         631.1000         Sod Water         MGAL         3.000         3.000           36         634.0614         Posts Wood 4x6-Inch X 14-FT         EACH         2.000         2.000           40         634.0810         Posts Tubular Steel 2x2-Inch X 10-FT         EACH         1.000         1.000           42         634.0812         Posts Tubular Steel 2x2-Inch X 12-FT         EACH         1.000         1.000           43         637.2210         Signs Type II Reflective F         SF         27.250         27.250           44         637.2210         Signs Type II Reflective F         SF         16.500 <td< td=""></td<>
24         628.7020         Inlet Protection Type D         EACH         6.000         6.000           26         628.7570         Rock Bags         EACH         15.000         15.000           30         630.0140         Seeding Mixture No. 40         LB         2.000         2.000           32         630.0500         Seed Water         MGAL         3.000         3.000           34         631.000         Sod Water         MGAL         3.000         3.000           36         631.1000         Sod Lawn         SY         98.000         98.000           36         634.0614         Posts Tubular Steel 2x2-Inch X 10-FT         EACH         2.000         2.000           42         634.0812         Posts Tubular Steel 2x2-Inch X 12-FT         EACH         2.000         2.000           42         634.0812         Posts Tubular Steel 2x2-Inch X 12-FT         EACH         1.000         1.000           43         637.2230         Signs Type II Reflective F         EACH         1.000         1.000           50         638.2002         Removing Small Sign Supports         EACH         1.000         1.000           51         643.0300         Traffic Control Dums         DAY         731.000
26         628.7570         Rock Bags         EACH         15.000         15.000           28         629.0210         Fertilizer Type B         CWT         2.000         2.000           30         630.0500         Seed Water         MGAL         2.000         2.000           32         630.0500         Seed Water         MGAL         2.000         2.000           34         631.0300         Sod Water         MGAL         3.000         3.000           36         631.000         Sod Lawn         SY         98.000         98.000           38         634.0614         Posts Tubular Steel 2x2-Inch X 10-FT         EACH         1.000         1.000           40         634.0812         Posts Tubular Steel 2x2-Inch X 12-FT         EACH         1.000         1.000           44         637.2210         Signs Type II Reflective F         EACH         1.000         1.000           50         638.2602         Removing Signs Type II         EACH         1.000         1.000           52         638.3000         Removing Signs Type II         EACH         1.000         1.000           54         642.201         Field Offnee Type B         EACH         1.000         1.000
28         629.0210         Fertilizer Type B         CWT         2.000         2.000           30         630.0140         Seeding Mixture No. 40         LB         2.000         2.000           34         631.0300         Sod Water         MGAL         3.000         3.000           34         631.0300         Sod Water         MGAL         3.000         3.000           36         634.0614         Posts Wood 4x6-Inch X 14-FT         EACH         2.000         4.000         1.000           40         634.0810         Posts Tubular Steel 2x2-Inch X 10-FT         EACH         2.000         2.000           42         634.0812         Posts Tubular Steel 2x2-Inch X 12-FT         EACH         2.000         2.000           44         637.2210         Signs Type II Reflective H         SF         16.500         16.500           46         638.2102         Moving Signs Type II         EACH         1.000         1.000           52         638.0300         Removing Small Sign Supports         EACH         1.000         1.000           54         643.0300         Traffic Control Drums         DAY         2.600.000         2.600.000           56         643.0401         Traffic Control Barricades Type II
30         630.0140         Seeding Mixture No. 40         LB         2.000         2.000           32         630.0500         Seed Water         MGAL         2.000         3.000           33         631.000         Sod Water         MGAL         3.000         3.000           36         631.000         Sod Lawn         SY         98.000         98.000           38         634.0614         Posts Wood 4x6-Inch X 14-FT         EACH         2.000         4.000           40         634.0810         Posts Tubular Steel 2x2-Inch X 10-FT         EACH         2.000         2.000           44         637.2210         Signs Type II Reflective F         SF         27.250         27.250           45         638.202         Removing Signs Type II         EACH         1.000         10.000           50         638.2002         Removing Signs Type II         EACH         10.000         10.000           52         638.3000         Ramoving Signs Type II         EACH         1.000         10.000           54         643.0410         Traffic Control Barricades Type II         DAY         730.000         730.000           56         643.0410         Traffic Control Barricades Type II         DAY         130
32         630.0500         Seed Water         MGAL         2.000         2.000           34         631.0300         Sod Water         MGAL         3.000         3.000           36         631.000         Sod Lawn         SY         98.000         98.000           38         634.0614         Posts Wood 4x6-Inch X 14-FT         EACH         2.000         2.000           40         634.0812         Posts Tubular Steel 2x2-Inch X 10-FT         EACH         1.000         1.000           42         634.0812         Posts Tubular Steel 2x2-Inch X 10-FT         EACH         1.000         2.000           44         637.2210         Signs Type II Reflective F         EACH         1.000         10.000           638.2022         Moving Signs Type II         EACH         1.000         10.000           56         643.0300         Removing Small Sign Supports         EACH         1.000         1.000           56         643.0401         Traffic Control Barricades Type II         DAY         2.600.000         2.600.000           56         643.0400         Traffic Control Barricades Type II         DAY         13.085.000         13.085.000           643.0400         Traffic Control Barricades Type III         DAY         <
34         631.0300         Sod Water         MGAL         3.000         3.000           36         631.000         Sod Lawn         SY         98.000         98.000           38         634.0614         Posts Wood 4x6-Inch X 14-FT         EACH         2.000         2.000           40         634.0810         Posts Tubular Steel 2x2-Inch X 10-FT         EACH         1.000         1.000           42         634.0812         Posts Tubular Steel 2x2-Inch X 12-FT         EACH         2.000         2.000           44         637.2210         Signs Type II Reflective H         SF         27.250         27.250           46         633.202         Removing Signs Type II         EACH         1.000         1.000           50         638.2002         Removing Signs Supports         EACH         1.000         1.000           52         643.0300         Traffic Control Drums         DAY         569.000         569.000           54         642.0301         Field Office Type B         Acth         1.000         1.000           56         643.0400         Traffic Control Barricades Type II         DAY         7.000         7.31.000           56         643.0400         Traffic Control Sarricades Type IIS <td< td=""></td<>
36         631.1000         Sod Lawn         SY         98.000         98.000           38         634.0614         Posts Wood 4x6-Inch X 14-FT         EACH         2.000         2.000           40         634.0810         Posts Tubular Steel 2x2-Inch X 10-FT         EACH         1.000         1.000           42         633.0812         Posts Tubular Steel 2x2-Inch X 12-FT         EACH         2.000         2.000           44         637.2210         Signs Type II Reflective H         SF         27.250         27.250           46         638.2102         Moving Signs Type II         EACH         1.000         1.000           50         638.2602         Removing Small Sign Supports         EACH         1.000         1.000           52         643.0410         Traffic Control Drums         DAY         569.000         569.000           54         643.0401         Traffic Control Barricades Type II         DAY         569.000         2,600.000         2,600.000         2,600.000         2,600.000         2,600.000         2,600.000         2,600.000         2,600.000         2,600.000         2,600.000         2,600.000         2,600.000         2,600.000         2,600.000         2,600.000         2,600.000         2,600.000         2,600.0
38         634.0614         Posts Wood 4x6-Inch X 14-FT         EACH         2.000         2.000           40         634.0810         Posts Tubular Steel 2x2-Inch X 10-FT         EACH         1.000         1.000           42         634.0812         Posts Tubular Steel 2x2-Inch X 12-FT         EACH         2.000         2.000           44         637.2230         Signs Type II Reflective F         SF         16.500         16.500           45         632.202         Removing Signs Type II         EACH         1.000         1.000           50         638.2602         Removing Signs Type II         EACH         1.000         1.000           52         638.3000         Removing Small Sign Supports         EACH         5.000         7.000           54         642.5001         Field Office Type B         EACH         1.000         1.000           56         643.0300         Traffic Control Drums         DAY         7.81.000         7.80.000           56         643.0410         Traffic Control Barricades Type III         DAY         7.81.000         7.81.000           64         643.0900         Traffic Control Signs POMS         DAY         1.463.000         1.463.000           64         643.0900         Tr
40         634.0810         Posts Tubular Steel 2x2-Inch X 10-FT         EACH         1.000         1.000           42         634.0812         Posts Tubular Steel 2x2-Inch X 12-FT         EACH         2.000         2.000           44         637.2210         Signs Type II Reflective H         SF         27.250         27.250           46         637.2230         Signs Type II Reflective F         SF         16.500         16.500           48         638.2102         Moving Signs Type II         EACH         1.000         1.000           50         638.2602         Removing Small Sign Supports         EACH         1.000         10.000           52         643.0300         Traffic Control Drums         DAY         569.000         569.000           56         643.0410         Traffic Control Barricades Type II         DAY         731.000         731.000           62         643.0420         Traffic Control Barricades Type III         DAY         1,463.000         1,463.000           644.0705         Traffic Control Signs PCMS         DAY         1,463.000         1,463.000           643.0500         Traffic Control Signs PCMS         DAY         13,085.000         13,085.000           643.0500         Traffic Control Signs PCMS
42         634.0812         Posts Tubular Steel 2x2-Inch X 12-FT         EACH         2.000         2.000           44         637.2210         Signs Type II Reflective H         SF         27.250         27.250           46         637.2210         Signs Type II Reflective F         SF         16.500         16.500           46         638.2102         Moving Signs Type II         EACH         1.000         1.000           50         638.2602         Removing Signs Type II         EACH         1.000         10.000           52         638.3000         Removing Small Sign Supports         EACH         5.000         5.000           54         642.5001         Field Office Type B         EACH         0.000         2.600.000         569.000           56         643.0400         Traffic Control Barricades Type II         DAY         2.600.000         2.600.000         44         637.2210         Signs Type II Reflective H         SF         27.250         27.250           46         637.2230         Signs Type II Reflective F         SF         16.500         16.500           48         638.2102         Moving Signs Type II         EACH         1.000         1.000           50         638.2002         Removing Small Sign Supports         EACH         10.000         10.000           52         638.3000         Removing Small Sign Supports         EACH         1.000         1.000           54         642.5001         Field Office Type B         EACH         1.000         1.000           56         643.0300         Traffic Control Drums         DAY         2.600.000         2.600.000           66         643.0410         Traffic Control Barricades Type III         DAY         731.000         731.000           66         643.0420         Traffic Control Warning Lights Type A         DAY         13.085.000         1.463.000           64         643.0900         Traffic Control Signs PCMS         DAY         13.085.000         1.463.000           64         643.0900         Traffic Control Signs PCMS         DAY         13.085.000         1.000           70         645.0120
46       637.2230       Signs Type II Reflective F       SF       16.500       16.500         48       638.2102       Moving Signs Type II       EACH       1.000       1.000         50       638.2602       Removing Signs Type II       EACH       10.000       10.000         52       638.3000       Removing Small Sign Supports       EACH       5.000       5.000         54       642.5001       Field Office Type B       EACH       1.000       1.000         56       643.0300       Traffic Control Drums       DAY       569.000       569.000         58       643.0410       Traffic Control Barricades Type II       DAY       2,600.000       2,600.000         64       643.0420       Traffic Control Barricades Type III       DAY       731.000       731.000         64       643.0420       Traffic Control Signs PCMS       DAY       1,463.000       14,63.000         64       643.0500       Traffic Control Signs PCMS       DAY       13,085.000       13,085.000         64       643.0500       Traffic Control Signs PCMS       DAY       146.000       16.000         70       645.0111       Geotextile Type DF Schedule A       SY       180.000       160.000
448         638.2102         Moving Signs Type II         EACH         1.000         1.000           50         638.2602         Removing Signs Type II         EACH         10.000         10.000           52         638.3000         Removing Small Sign Supports         EACH         5.000         5.000           54         642.5001         Field Office Type B         EACH         1.000         1.000           56         643.0300         Traffic Control Drums         DAY         569.000         2.600.000           60         643.0410         Traffic Control Barricades Type II         DAY         2.600.000         2.600.000           62         643.0420         Traffic Control Barricades Type III         DAY         731.000         731.000           64         643.0900         Traffic Control Signs         DAY         1.463.000         1.463.000           64         643.0900         Traffic Control Signs PCMS         DAY         1.3085.000         13.085.000           64         643.0900         Traffic Control Signs PCMS         DAY         1.400         1.000           70         645.0111         Geotextile Type DF Schedule A         SY         180.000         180.000           72         645.0120
50         638.2602         Removing Signs Type II         EACH         10.000         10.000           52         638.3000         Removing Small Sign Supports         EACH         5.000         5.000           54         642.5001         Field Office Type B         EACH         1.000         1.000           56         643.0300         Traffic Control Drums         DAY         569.000         2,600.000           58         643.0410         Traffic Control Barricades Type II         DAY         2,600.000         2,600.000           60         643.0420         Traffic Control Barricades Type III         DAY         1,463.000         1,463.000           62         643.0705         Traffic Control Signs         DAY         1,463.000         1,463.000           64         643.0900         Traffic Control Signs PCMS         DAY         13,085.000         13,085.000           66         643.1050         Traffic Control Signs PCMS         DAY         13,085.000         13,085.000           70         645.0111         Geotextile Type DF Schedule A         SY         180.000         180.000           72         645.0120         Geotextile Type HR         SY         260.000         260.000           74         646.7520
52         638.3000         Removing Small Sign Supports         EACH         5.000         5.000           54         642.5001         Field Office Type B         EACH         1.000         1.000           56         643.0300         Traffic Control Drums         DAY         569.000         2,600.000           58         643.0410         Traffic Control Barricades Type II         DAY         2,600.000         2,600.000           60         643.0420         Traffic Control Barricades Type III         DAY         731.000         731.000           62         643.0705         Traffic Control Signs         DAY         1,463.000         1,463.000           64         643.0900         Traffic Control Signs PCMS         DAY         13,085.000         13,085.000           66         643.5000         Traffic Control         EACH         1.000         1.000           70         645.0111         Geotextile Type DF Schedule A         SY         180.000         180.000           72         645.0120         Geotextile Type HR         SY         260.000         260.000           74         646.1200         Marking Stop Line Epoxy 18-Inch         LF         18.000         18.000           78         646.7520         Mark
54642.5001Field Office Type BEACH1.0001.00056643.0300Traffic Control DrumsDAY569.000569.00058643.0410Traffic Control Barricades Type IIDAY2,600.0002,600.00060643.0420Traffic Control Barricades Type IIIDAY731.000731.00062643.0705Traffic Control Warning Lights Type ADAY1,463.0001,463.00064643.0900Traffic Control SignsDAY13,085.00013,085.00066643.1050Traffic Control Signs PCMSDAY35.00035.00068643.000Traffic Control Signs PCMSDAY35.00035.00070645.0111Geotextile Type DF Schedule ASY180.000180.00072645.0120Geotextile Type HRSY260.000260.00074646.1020Marking Line Epoxy 4-InchLF756.000756.00076646.6120Marking Stop Line Epoxy 18-InchLF34.00034.00080650.4000Construction Staking Storm SewerEACH2.0002.00082650.5000Construction Staking BaseLF370.000370.00086650.6501Construction Staking Structure Layout (structure) 01. B-51-154EACH1.0001.000
56643.0300Traffic Control DrumsDAY569.000569.00058643.0410Traffic Control Barricades Type IIDAY2,600.0002,600.00060643.0420Traffic Control Barricades Type IIIDAY731.000731.00062643.0705Traffic Control Warning Lights Type ADAY1,463.0001,463.00064643.0900Traffic Control SignsDAY13,085.00013,085.00066643.1050Traffic Control Signs PCMSDAY35.00035.00068643.000Traffic Control Signs PCMSDAY35.00036.00070645.0111Geotextile Type DF Schedule ASY180.000180.00072645.0120Geotextile Type HRSY260.000260.00074646.1020Marking Line Epoxy 4-InchLF18.00018.00076646.6120Marking Stop Line Epoxy 18-InchLF34.00034.00080650.4000Construction Staking Storm SewerEACH2.0002.00082650.5000Construction Staking BaseLF204.0002.00084650.5500Construction Staking Curb Gutter and Curb & GutterLF370.000370.00086650.6501Construction Staking Structure Layout (structure) 01. B-51-154EACH1.0001.000
58       643.0410       Traffic Control Barricades Type II       DAY       2,600.000       2,600.000         60       643.0420       Traffic Control Barricades Type III       DAY       731.000       731.000         62       643.0705       Traffic Control Warning Lights Type A       DAY       1,463.000       1,463.000         64       643.0900       Traffic Control Signs       DAY       13,085.000       13,085.000         66       643.1050       Traffic Control Signs PCMS       DAY       35.000       35.000         66       643.5000       Traffic Control       EACH       1.000       1.000         70       645.0111       Geotextile Type DF Schedule A       SY       260.000       260.000         72       645.0120       Geotextile Type HR       SY       260.000       260.000         74       646.1020       Marking Stop Line Epoxy 18-Inch       LF       756.000       756.000         78       646.7520       Marking Crosswalk Epoxy Block Style 24-Inch       LF       34.000       34.000         80       650.4000       Construction Staking Storm Sewer       EACH       2.000       2.000         82       650.5000       Construction Staking Base       LF       370.000       370.000<
60         643.0420         Traffic Control Barricades Type III         DAY         731.000         731.000           62         643.0705         Traffic Control Warning Lights Type A         DAY         1,463.000         1,463.000           64         643.0900         Traffic Control Signs         DAY         13,085.000         13,085.000           66         643.1050         Traffic Control Signs PCMS         DAY         35.000         35.000           68         643.5000         Traffic Control         EACH         1.000         1.000           70         645.0111         Geotextile Type DF Schedule A         SY         180.000         180.000           72         645.0120         Geotextile Type HR         SY         260.000         260.000           74         646.1020         Marking Line Epoxy 4-Inch         LF         756.000         756.000           76         646.6120         Marking Stop Line Epoxy 18-Inch         LF         34.000         34.000           78         646.7520         Marking Crosswalk Epoxy Block Style 24-Inch         LF         34.000         34.000           80         650.4000         Construction Staking Storm Sewer         EACH         2.000         2.000           82         650.
62       643.0705       Traffic Control Warning Light Type A       DAY       1,463.000       1,463.000         64       643.0900       Traffic Control Signs       DAY       13,085.000       13,085.000         66       643.1050       Traffic Control Signs PCMS       DAY       35.000       35.000         68       643.5000       Traffic Control Signs PCMS       EACH       1.000       1.000         70       645.0111       Geotextile Type DF Schedule A       SY       180.000       180.000         72       645.0120       Geotextile Type HR       SY       260.000       260.000         74       646.1020       Marking Line Epoxy 4-Inch       LF       756.000       756.000         76       646.6120       Marking Stop Line Epoxy 18-Inch       LF       34.000       34.000         78       646.7520       Marking Crosswalk Epoxy Block Style 24-Inch       LF       34.000       34.000         80       650.4000       Construction Staking Storm Sewer       EACH       2.000       2.000         82       650.5000       Construction Staking Base       LF       370.000       370.000         84       650.5500       Construction Staking Structure Layout (structure) 01. B-51-154       EACH       1.000
64       643.0900       Traffic Control Signs       DAY       13,085.000       13,085.000         66       643.1050       Traffic Control Signs PCMS       DAY       35.000       35.000         68       643.5000       Traffic Control       EACH       1.000       1.000         70       645.0111       Geotextile Type DF Schedule A       SY       180.000       180.000         72       645.0120       Geotextile Type HR       SY       260.000       260.000         74       646.1020       Marking Line Epoxy 4-Inch       LF       756.000       756.000         76       646.6120       Marking Stop Line Epoxy 18-Inch       LF       34.000       34.000         78       646.7520       Marking Crosswalk Epoxy Block Style 24-Inch       LF       34.000       34.000         80       650.4000       Construction Staking Storm Sewer       EACH       2.000       2.000         82       650.5000       Construction Staking Base       LF       370.000       370.000         84       650.5500       Construction Staking Structure Layout (structure) 01. B-51-154       EACH       1.000       1.000
66643.1050Traffic Control Signs PCMSDAY35.00035.00068643.5000Traffic ControlEACH1.0001.00070645.0111Geotextile Type DF Schedule ASY180.000180.00072645.0120Geotextile Type HRSY260.000260.00074646.1020Marking Line Epoxy 4-InchLF756.000756.00076646.6120Marking Stop Line Epoxy 18-InchLF18.00018.00078646.7520Marking Crosswalk Epoxy Block Style 24-InchLF34.00034.00080650.4000Construction Staking Storm SewerEACH2.0002.00082650.5000Construction Staking BaseLF370.000370.00084650.5500Construction Staking Curb Gutter and Curb & GutterLF370.000370.00086650.6501Construction Staking Structure Layout (structure) 01. B-51-154EACH1.0001.000
68       643.5000       Traffic Control       EACH       1.000       1.000         70       645.0111       Geotextile Type DF Schedule A       SY       180.000       180.000         72       645.0120       Geotextile Type HR       SY       260.000       260.000         74       646.1020       Marking Line Epoxy 4-Inch       LF       756.000       756.000         76       646.6120       Marking Stop Line Epoxy 18-Inch       LF       18.000       18.000         78       646.7520       Marking Crosswalk Epoxy Block Style 24-Inch       LF       34.000       34.000         80       650.4000       Construction Staking Storm Sewer       EACH       2.000       2.000         82       650.5000       Construction Staking Base       LF       370.000       370.000         84       650.5500       Construction Staking Curb Gutter and Curb & Gutter       LF       370.000       370.000         86       650.6501       Construction Staking Structure Layout (structure) 01. B-51-154       EACH       1.000       1.000
70       645.0111       Geotextile Type DF Schedule A       SY       180.000       180.000         72       645.0120       Geotextile Type HR       SY       260.000       260.000         74       646.1020       Marking Line Epoxy 4-Inch       LF       756.000       756.000         76       646.6120       Marking Stop Line Epoxy 18-Inch       LF       18.000       18.000         78       646.7520       Marking Crosswalk Epoxy Block Style 24-Inch       LF       34.000       34.000         80       650.4000       Construction Staking Storm Sewer       EACH       2.000       2.000         82       650.5000       Construction Staking Base       LF       370.000       370.000         84       650.5500       Construction Staking Structure Layout (structure) 01. B-51-154       EACH       1.000       1.000
72       645.0120       Geotextile Type HR       SY       260.000       260.000         74       646.1020       Marking Line Epoxy 4-Inch       LF       756.000       756.000         76       646.6120       Marking Stop Line Epoxy 18-Inch       LF       18.000       18.000         78       646.7520       Marking Crosswalk Epoxy Block Style 24-Inch       LF       34.000       34.000         80       650.4000       Construction Staking Storm Sewer       EACH       2.000       2.000         82       650.5000       Construction Staking Base       LF       370.000       370.000         84       650.5500       Construction Staking Storuct Layout (structure) 01. B-51-154       EACH       1.000       1.000
74       646.1020       Marking Line Epoxy 4-Inch       LF       756.000       756.000         76       646.6120       Marking Stop Line Epoxy 18-Inch       LF       18.000       18.000         78       646.7520       Marking Crosswalk Epoxy Block Style 24-Inch       LF       34.000       34.000         80       650.4000       Construction Staking Storm Sewer       EACH       2.000       2.000         82       650.5000       Construction Staking Base       LF       370.000       370.000         84       650.5500       Construction Staking Curb Gutter and Curb & Gutter       LF       370.000       370.000         86       650.6501       Construction Staking Structure Layout (structure) 01. B-51-154       EACH       1.000       1.000
76         646.6120         Marking Stop Line Epoxy 18-Inch         LF         18.000         18.000           78         646.7520         Marking Crosswalk Epoxy Block Style 24-Inch         LF         34.000         34.000           80         650.4000         Construction Staking Storm Sewer         EACH         2.000         2.000           82         650.5000         Construction Staking Base         LF         204.000         204.000           84         650.5500         Construction Staking Curb Gutter and Curb & Gutter         LF         370.000         370.000           86         650.6501         Construction Staking Structure Layout (structure) 01. B-51-154         EACH         1.000         1.000
78         646.7520         Marking Crosswalk Epoxy Block Style 24-Inch         LF         34.000         34.000           80         650.4000         Construction Staking Storm Sewer         EACH         2.000         2.000           82         650.5000         Construction Staking Base         LF         204.000         204.000           84         650.5500         Construction Staking Curb Gutter and Curb & Gutter         LF         370.000         370.000           86         650.6501         Construction Staking Structure Layout (structure) 01. B-51-154         EACH         1.000         1.000
80         650.4000         Construction Staking Storm Sewer         EACH         2.000         2.000           82         650.5000         Construction Staking Base         LF         204.000         204.000           84         650.5500         Construction Staking Curb Gutter and Curb & Gutter         LF         370.000         370.000           86         650.6501         Construction Staking Structure Layout (structure) 01. B-51-154         EACH         1.000         1.000
82         650.5000         Construction Staking Base         LF         204.000         204.000           84         650.5500         Construction Staking Curb Gutter and Curb & Gutter         LF         370.000         370.000           86         650.6501         Construction Staking Structure Layout (structure) 01. B-51-154         EACH         1.000         1.000
84650.5500Construction Staking Curb Gutter and Curb & GutterLF370.000370.00086650.6501Construction Staking Structure Layout (structure) 01. B-51-154EACH1.0001.000
86650.6501Construction Staking Structure Layout (structure) 01. B-51-154EACH1.0001.000
oo oo uuuu Construction Staking Concrete Pavement IF 30.000 30.000
•
90       650.8501       Construction Staking Electrical Installations (project) 01. 3834-00-72       EACH       1.000       1.000         90       650.8501       Construction Staking Electrical Installations (project) 01. 3834-00-72       EACH       1.000       1.000
92 650.9000 Construction Staking Curb Ramps EACH 6.000 6.000
94         650.9500         Construction Staking Sidewalk (project) 01. 3834-00-72         EACH         1.000         1.000
96650.9911Construction Staking Supplemental Control (project) 01. 3834-0072EACH1.0001.000



					3834-00-72	
Line	Item	Item Description	Unit	Total	Qty	
0198	650.9920	Construction Staking Slope Stakes	LF	204.000	204.000	
0200	652.0125	Conduit Rigid Metallic 2-Inch	LF	50.000	50.000	
0202	652.0225	Conduit Rigid Nonmetallic Schedule 40 2-Inch	LF	1,070.000	1,070.000	
0204	652.0605	Conduit Special 2-Inch	LF	200.000	200.000	
0206	653.0222	Junction Boxes 18x12x6-Inch	EACH	2.000	2.000	
0208	655.0620	Electrical Wire Lighting 8 AWG	LF	4,323.000	4,323.000	
0210	690.0150	Sawing Asphalt	LF	23.000	23.000	
0212	690.0250	Sawing Concrete	LF	225.000	225.000	
0214	715.0502	Incentive Strength Concrete Structures	DOL	7,350.000	7,350.000	
0216	715.0720	Incentive Compressive Strength Concrete Pavement	DOL	500.000	500.000	
0218	999.1001.S	Seismograph	EACH	1.000	1.000	
0220	999.1501.S	Crack and Damage Survey	EACH	1.000	1.000	
0222	999.2000.S	Installing and Maintaining Bird Deterrent System (station) 01. 13+00	EACH	1.000	1.000	
0224	ASP.1T0A	On-the-Job Training Apprentice at \$5.00/HR	HRS	1,600.000	1,600.000	
0226	ASP.1T0G	On-the-Job Training Graduate at \$5.00/HR	HRS	3,600.000	3,600.000	
0228	SPV.0060	Special 01. Lighting Pull Boxes	EACH	1.000	1.000	
0230	SPV.0060	Special 02. Decorative Lighting Unit Concrete Bases	EACH	1.000	1.000	
0232	SPV.0060	Special 03. Decorative Lighting Units	EACH	3.000	3.000	
0234	SPV.0060	Special 04. Utility Line Opening (ULO)	EACH	1.000	1.000	
0236	SPV.0060	Special 05. Building Electrical Work	EACH	1.000	1.000	
0238	SPV.0090	Special 01. Concrete Curb & Gutter 24-Inch, Type A	LF	60.000	60.000	
0240	SPV.0090	Special 02. Concrete Curb & Gutter 24-Inch, Type D	LF	170.000	170.000	
0242	SPV.0090	Special 04. NW Wingwall Decorative Railing	LF	27.000	27.000	

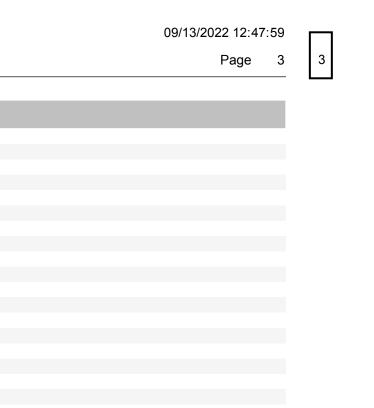

### PAVEMENT REMOVALS

### REMOVING CONCRETE PAVEMENT CATEGORY ROADWAY STATION - STATION LOCATION SY 0010 JEFFERSON STREET 11+15 - 11+79 Mainline 312 14+11 - 14+95 575 Mainline TOTALS 887

							204.0150 REMOVING CURB &	
							GUTTER	SIDEWALK
CATEGORY	ROADWAY	STATION	-	STATION	LOCATION	LF	LF	SY
0010	JEFFERSON STREET							
		11+15	-	11+94	LT	6	85	82
		11+15	-	11+94	RT		79	73
		13+96	-	14+95	LT		97	56
		13+96	-	14+95	RT		103	35
TOTALS						6	364	245

REMOVING CONCRETE ITEMS

Division	From/To Station	Location	Common Excavation (1) Item 205.0100 Cut (2)	Salvaged/Unusable Pavement Material (4)	Available Material (5)	Unexpanded Fill		Mass Ordinate +/- (8)	Waste
Jefferson Street	11+15 - 14+96		494	91	403	2	3	410	410
Grand Total			494	91	403	2	3	410	410

1) Common Excavation is the sum of the Cut and EBS Excavation columns. Item number 205.0100

2) Salvaged/Unsuable Pavement Material is included in Cut.

3) No EBS Excavation to be backfilled.

4) Salvaged/Unusable Pavement Material

204.0100

5) Available Material = Cut - Salvaged/Unusuable Pavement Material

6) No Reduced EBS in Fill.

7) Expanded Fill. Factor = 1.25

### Expanded Fill = (Unexpanded Fill - Reduced EBS) * Fill Factor

8) The Mass Ordinate + or - Qty calculated for the Division. Plus quantity indicates an excess of material within the Division. Minus indicates a shortage of material within the Division.

PROJECT NO: 3834-00-72	HWY: JEFFERSON STREET	COUNTY: RACINE			MISCELLANEOUS	JUUANIIILJ	
FILE NAME : C:\OD\CORRE, INC\PROJECTS - WI-SE REGION\3834-00-02 JEFFERSON ST BRIDGE OVER FOX RIVER B-51-0001\500 CADD\501 C3D 2018\38340002\SHEETSPLAN\030201-MQ,DWG PLOT DATE : 7/31/2022 10:29 AM PLOT BY : JESSICA LEWIS, F							PLOT NAME :

3

### REMOVING/ADJUSTING STORM SEWER

				204.0220 REMOVING INLETS	204.0245 REMOVING STORM SEWER	611.8115 ADJUSTING INLET
CATEGORY	ROADWAY	STATION	LOCATION	EACH	0.1.12-INCH LF	COVERS EACH
0010	JEFFERSON STREET					
		11+99	RT	1		
		12+00	LT	1		
		12+00	LT/RT		31	
		14+00	LT/RT			2
TOTALS				2	31	2

SHEET

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				BASE AGGREGATE DENSE			
					305.0110	305.0120	624.0100
					<b>BASE AGGREGATE</b>	BASE AGGREGATE	-
					DENSE	DENSE	
					3/4-INCH	11/4-INCH	WATER
CATEGORY	ROADWAY	STATION -	STATION	LOCATION	TON	TON	MGAL
0010	JEFFERSON STREE	Т					
		11+15 -	11+79	MAINLINE		181	2
		11+79 -	11+94	WEST APPROACH SLAB		21	1
		13+96 -	14+11	EAST APPROACH SLAB		20	1
		14+11 -	14+95	MAINLINE		367	4
		11+15 -	14+95	CURB AND GUTTER, LT		55	1
		11+15 -	14+95	CURB AND GUTTER, RT		55	1
		11+15 -	14+95	SHOULDER RT	4	17	1
		11+15 -	14+95	DRIVEWAY, LT		5	
fotals					4	722	10

## CONCRETE ITEMS

					415.0410	416.0160	601.0110	601.0411	602.0405	602.0415	SPV.0090.01	SPV.0090.02
					CONCRETE	CONCRETE	CONCRETE	CONCRETE	CONCRETE	CONCRETE	CONCRETE	CONCRETE
					PAVEMENT	DRIVEWAY	CURB	CURB AND GUTTER	SIDEWALK	SIDEWALK	CURB AND GUTTER	CURB AND GUTTER
					APPROACH SLAB	6-INCH	TYPE D	30-INCH TYPE D	4-INCH	6-INCH	24-INCH, TYPEA	24-INCH, TYPE D
CATEGORY	ROADWAY	STATION	- STATION	LOCATION	SY	SY	LF	LF	SF	SF	LF	LF
0010	JEFFERSON STREET											
		11+15	- 11+94	LT	27		6			735	15	70
		11+15	- 11+94	RT	27	11				653	15	64
		13+96	- 14+95	LT	27			63	501		15	19
		13+96	- 14+95	RT	26			71	313		15	17
TOTALS					107	11	6	134	814	1,388	60	170

### ASPHALTIC ITEMS

					455.0605	465.0105	465.0120	465.0315
					TACK	ASPHLATIC	ASPHALTIC SURFACE	
					COAT	SURFACE	DRIVEWAY & FIELD ENTRANCE	ASPHALTIC FLUMES
CATEGORY	ROADWAY	STATION	- STATION	LOCATION	GAL	TON	TON	SY
0010	JEFFERSON STREET							
		11+15	- 11+79	Mainline	36	75	2	
		14+11	- 14+95	Mainline	55	150		9
TOTALS					91	225	2	9

			CUR	<u>B RAMP ITE</u>	<u>MS</u> 602.0505	602.0605							<u>STOR</u>	<u>M SEWER</u>		
					CURB RAMP DETECTABLE WARNIN FIELD YELLOW	CURB RAMP				-			608.0512 STORM SEWER PIPE REINFORCED CONCRETE		CATCH BASINS	I
CATEGORY	ROADWAY	STATION	- STATION	I LOCATIC	N SF	SF	CATECODY		STRUCTUR		0/5	COVER	CLASS V 12-INCH	TYPE H-S	2X3	0/ 0
0010	JEFFERSON STREET						CATEGORY	ROADWAY	NUMBER	STATION	O/S	ELEV	LF	EACH	EACH	% SI
		11+15	- 11+94	LT	10		0010	EFFERSON STREET								
		11+15	- 11+94	R⊤	10				1.1	11+89	17'LT	760.59		1	1	0.
		13+96	- 14+95	LT	20				1.2	11+89	17'RT	760.60	24	1	1	1.2
		13+96	- 14+95	R⊤	10	17	TOTALS						58	2	2	
TOTALS					50	17										
ROJECT NO:	3834-00-72				HWY: JEFFERSON S	reet	COUNTY: RAG	CINE			MISCEL	LANEOU	IS QUANTITIES			

FILE NAME : C:\OD\CORRE, INC\PROJECTS - DOCUMENTS\WI - SE REGION\3834-00-02 JEFFERSON ST_BRIDGE OVER FOX RIVER B-51-0001\500_CADD\501_C3D_2018\38340002\SHEETSPLAN\030201-MPLDWGATE : 4/28/2022 2:34 PM LAYOUT NAME - 02 PLOT BY : BEN KROLCZYK PLOT NAME :

WISDOT/CADDS SHEET 42

0 *** TRUCTURE DEPTH DOES NOT 1.25% 5.86 1.2 ** STRUCTURE DEPTH DOES NOT NICLUDE 6 INCHES OF ADJUSTMENT RINGS ** STRUCTURE STRUCTURE ** STRUCTURE STRUCTURE ** STRUCTURE STRUCTURE ** STRUCTURE DEPTH DOES NOT ** STRUCTURE DEPTH DOES NOT NIFORMATION ONLY						SH	EET		Ε
DEPTHFROMTOINLETDISCHPIPE TIES REQ'D% SLOPEFTSTRUCTURESTRUCTUREELEVELEVEACH0.33%5.701.11.2754.48756.15			INCLUD	E 6 INCHES O				INFORMATION	
** * DEPTH FROM TO INLET DISCH PIPE TIES REQ'D % SLOPE FT STRUCTURE STRUCTURE ELEV ELEV EACH					1.2 -				
** * DEPTH FROM TO INLET DISCH PIPE TIES REQ'D									
0	0	% SLOPF	DEPTH					PIPE TIES REQ'D	
	0								
		19 17							
		64							
64 19		70							
19	3 A	NCRETE ND GUTTE CH, TYPE D LF							

### LANDSCAPING ITEMS

					625.0100	629.0210 FERTILIZER	630.0140 SEEDING	630.0500 SEED	631.0300 SOD	631.1000 SOD
					TOPSOIL	TYPE B	MIXTURE NO. 40	WATER	WATER	LAWN
CATEGORY	ROADWAY	STATION	- STATION	LOCATION	SY	CW⊤	LB	MGAL	MGAL	SY
0010	JEFFERSON STREET									
		11+15	- 11+94	LT	15	0.01			0.40	15
		11+15	- 11+94	R⊤	35	0.02			0.90	35
		13+96	- 14+95	LT	28	0.02			0.70	28
		13+96	- 14+95	R⊤	169	0.11	1.00	1.00		
				SUBTOTAL	247	1	1	1	2	78
		UNDIS	TRIBUTED		62	1	1	1	1	20
TOTALS					309	2	2	2	3	98

### EROSION CONTROL

						627.0200	628.1504	628.1520	628.1905 MC	628.1910 DBILIZATIONS	628.2008 EROSION	628.6005	628.7020	628.7
											-		INLET	
							SILT	SILT FENCE	EROSION	EMERGENCY	MAT URBAN	TURBIDITY	PROTECTION	ROC
						MULCHING	FENCE	MAINTENANCE	CONTROL	EROSION CONTROL	CLASS I TYPE B	BARRIERS	TYPE D	BAG
CATEGORY	ROADWAY	STATION	TO	STATION	O/S	SY	LF	LF	EA	EA	SY	SY	EA	EA
0010	JEFFERSON STREET													
		11+15	-	11+94	LT/RT	2			1	1		160	4	
		13+96	-	14+95	LT/RT	9	50	50	1	1	169	139	2	12
					SUBTOTAL	11	50	50	2	2	169	299	6	12
		UNDI	STRI	BUTED		3	13	13	1	1	42	75		3
TOTALS						14	63	63	3	3	211	374	6	15

							PERMAN	NENT SIGNING	<u>3</u>					
					634.0614	634.0810 POSTS	634.0812 POSTS	637.2210 SIGNS	637.2230 SIGNS	638.2102	638.2602	638.3000 REMOVING		
				SIGN	POSTS	TUBULAR	TUBULAR	TYPEII	TYPE II	MOVE	REMOVING	SMALL		
				SIZE	WOOD	STEEL	STEEL	REFLECTIVE	REFLECTIVE	SIGNS	SIGNS	SIGN		
		SIGN	SIGN	WхН	4x6-INCH x 14-F⊤	2x2-INCH x 10-FT	2x2-INCH x 12-FT	Н	F	TYPE II	TYPE II	SUPPORTS		
STATION	LOCATION	NO.	CODE	IN x IN	EA	EA	EA	SF	SF	EA	EA	EA	DESCRIPTION	
EFFERSON STREET														
11+32	32'LT	1-1	R3-2	24 x 24	-	1	-	4.00	-	-	1	1	<b>REGULATORY SIGN</b>	N
11+73	28'R⊤	1-2	W11-2	30 x 30	-	-	1	-	6.25	-	1	1	WARNING SIGN	P
11175	20 111	ΤZ	S16-7	24 x 12	-	-	-	-	2.00	-	1	-	SCHOOL SIGN	DC
11+93	26.5'LT	1-3	W11-2	30 x 30	-	-	1	-	6.25	-	1	-	WARNING SIGN	PE
11155	20.5 ET	тJ	S16-7	24 x 12	-	-	-	-	2.00	-	1	-	SCHOOL SIGN	DC
11+92	25'R⊤	1-4	I3-1	36 x 24	1	-	-	6.00	-	-	1	1	INFFORMATIONAL SIGN	I
12+00	23.5'RT	1-5	R12-1	-	-	-	-	-	-	-	1	-	<b>REGULATORY SIGN</b>	W
12+10	25.5'LT	1-6	R3-8	45 x 36	-	-	-	11.25	-	-	1	1	<b>REGULATORY SIGN</b>	VAIRIO P
13+98	26'LT	1-7	I3-1	36 x 24	1	-	-	6.00	-	-	1	1	INFFORMATIONAL SIGN	
12+90	23.5'LT	1-8	R12-1	-	-	-	-	-	-	-	1	-	<b>REGULATORY SIGN</b>	W
14+56	33'RT	1-9	R1-1	-	-	-	-	-	-	1	-	-	<b>REGULATORY SIGN</b>	
		TO	TALS		2	1	2	27.25	16.5	1	10	5		

PROJECT NO	D: 3834-00-72	HWY: JEFFERSON STREET	COUNTY: RACINE			MISCELLANEOU		
	OD\CORRE, INC\PROJECTS - WI-SE REGION\3834-00-02 JEFFERSON ST_B	SHEETSPLAN\030201-MQ.DWG	PLOT DATE :	9/1/2022 11:44 AM	PLOT BY :	JESSICA LEWIS, PE	PLOT NAME :	

LAYOUT NAME - 03

3.7570

OCK AGS

EA

.2

COMMENTS

NO LEFT TURN SYMBOL PEDESTRIAN CROSSING DOWN ARROW SYMBOL PEDESTRIAN CROSSING DOWN ARROW SYMBOL FOX RIVER WEIGHT LIMIT 45 TONS IOUS ARROW COMBINATION PLACE ON LIGHT POLE FOX RIVER WEIGHT LIMIT 45 TONS STOP

SHEET

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### TRAFFIC CONTROL ITEMS

			643.0300 TRAFFIC CONTROL DRUMS	643.0410 TRAFFIC CONTROL BARRICADES TYPE II	643.0420 TRAFFIC CONTROL BARRICADES TYPE III	643.0705 TRAFFIC CONTROL WARNING LIGHTS A	643.0900 6 SIGNS
CATEGORY	ROADWAY	LOCATION	DAYS	DAYS	DAYS	DAYS	DAYS
0010	JEFFERSON STREET						
		BRIDGE STREET AND JEFFERSON STREET	455	780	585	1,170	2,795
		JEFFERSON STREET AND ADAMS STREET		325			2,600
		STATE STREET AND MAIN STREET		195			2,470
		MAIN STREET AND JEFFERSON STREET		780			2,600
		SUBTOTAL	455	2,080	585	1,170	10,465
		UNDISTRIBUTED	114	520	146	293	2,620
TOTALS			569	2,600	731	1,463	13,085

### PAVEMENT MARKING

							646.6120	646.7520
					MARK	(ING	MARKING	MARKING
					2		STOP LINE	CROSSWALK EPOXY
					EPOXY 4	1-INCH	EPOXY	BLOCK STYLE
					YELLOW	WHITE	18-INCH	24-INCH
CATEGORY	ROADWAY	STATION	ТО	STATION	LF	LF	LF	LF
0010	JEFFERSON	STREET						
	11+15 -		14+95	694 62		18	34	
TOTALS				756		18	34	

### CONSTRUCTION STAKING ITEMS

					650.4000	650.5000	650.5500	650.7000	650.8501	650.9000	650.9500	650.9911	650.9920
					CONSTRUCTION	CONSTRUCTION	CONSTRUCTION	CONSTRUCTION	CONSTRUCTION	CONSTRUCTION	CONSTRUCTION	CONSTRUCTION	CONSTRUCTION
					STAKING STORM	STAKING BASE	CURB GUTTER AND	STAKING CONCRETE	STAKING ELECTRICAL	STAKING CURB	STAKING	SUPPLEMENTAL	STAKING SLOPE
					SEWER		CURB & GUTTER	PAVEMENT	INSTALLATIONS	RAMPS	SIDEWALK	CONTROL	STAKES
CATEGORY	ROADWAY	STATION - STA	TION L	OCATION	EACH	LF	LF	LF	EACH	EACH	EACH	EACH	LF
0010	JEFFERSON STREET												
		11+15 - 12	+15 N	MAINLINE	2	100	170	15	1	2	1	1	100
		13+92 - 14	+96 N	MAINLINE		104	200	15		4			104
TOTALS					2	204	370	30	1	6	1	1	204

				SAWING PAVEME	<u>NT ITEMS</u>					UTILITY LINE OPENING	
						690.0150	690.0151				SPV.0060.04
						SAWING	SAWING				UTILITY LINE
						ASPHALT	CONCRETE				OPENING (ULO)
		CATEGORY F	ROADWAY	STATION - STATION	LOCATION	LF	LF	CATEGO	RY ROADWAY	STATION - STATION LOCATION	EACH
		0010 J	JEFFERSON STREE	T				0010	JEFFERSON STREE	Т	
				11+15 - 14+95	MAINLINE		119			13+70 - 13+87 40',RT	1
				11+15 - 14+95	SIDEWALK, LT		45	TOTALS			1
				11+15 - 14+95	SIDEWALK, R⊤		22				
				11+15 - 14+95	DRIVEWAY, L⊤	23	4				
				11+15 - 14+95	DRIVEWAY, R⊤		35				
		TOTALS				23	225				
PROJECT NO:	3834-00-72		HWY: J	EFFERSON STREET		COUNTY:	RACINE	MISCELLANEOUS C	QUANTITIES		

FILE NAME : C:\OD\CORRE, INC\PROJECTS - WI-SE REGION\3834-00-02 JEFFERSON ST_BRIDGE OVER FOX RIVER B-51-0001\500_CADD\501_C3D_2018\38340002\SHEETSPLAN\030201-MQ.DWG PLOT DATE : 9/1/2022 12:18 PM PLOT BY : JESSICA LEWIS, PE PLOT NAME : LAYOUT NAME - 04

900 S	643.1050 SIGNS PCMS
S	DAYS
5	14
0	
0	
0	14
55	28
0	7
35	35

3

SHEET

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## LIGHTING PULL BOX QUANTITIES

## BUILDING WORK QUANTITIES

	SPV.0060.01
	LIGHTING
	PULL BOXES
NO.	EACH
LPB-1	1
TOTAL	1

	SPV.0060.05
	BUILDING
	ELECTRICAL WORK
LOC.	EACH
BUILDING	1
TOTAL	1

# LIGHTING UNIT QUANTITIES

	SPV.0060.02	SPV.0060.03	
	DECORATIVE LIGHTING	DECORATIVE	
	UNIT CONCRETE BASES	LIGHTING UNITS	
NO.	EACH	EACH	
BL-11/13L-15R-1	1	1	
BL-11/13L-15R-2		1	
BL-11/13L-15R-3		1	

# LIGHTING BRANCH CIRCUIT WIRE AND CONDUIT QUANTITIES

		NONMETALLIC SCHEDULE 40 2-INCH	2-INCH *	ELECTRICAL WIF
FROM	ТО		LF	LF
BUILDING	EPB			1068
EPB	LPB-1		200	1060
LPB-1 BR	NDGE (BL-11/13L-15R-2)	68		615
LPB-1	BL-11/13L-15R-1	60		360
BL-11/13L-15R-1 BR	RIDGE (BL-11/13L-15R-3)	72		1220
	TOTALS	200	200	4323


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HWY: JEFFERSON STREET

COUNTY: RACINE

3


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FILE NAME : 040101-TLE.DWG


PLOT DATE : 4/19/2021 12:13 PM

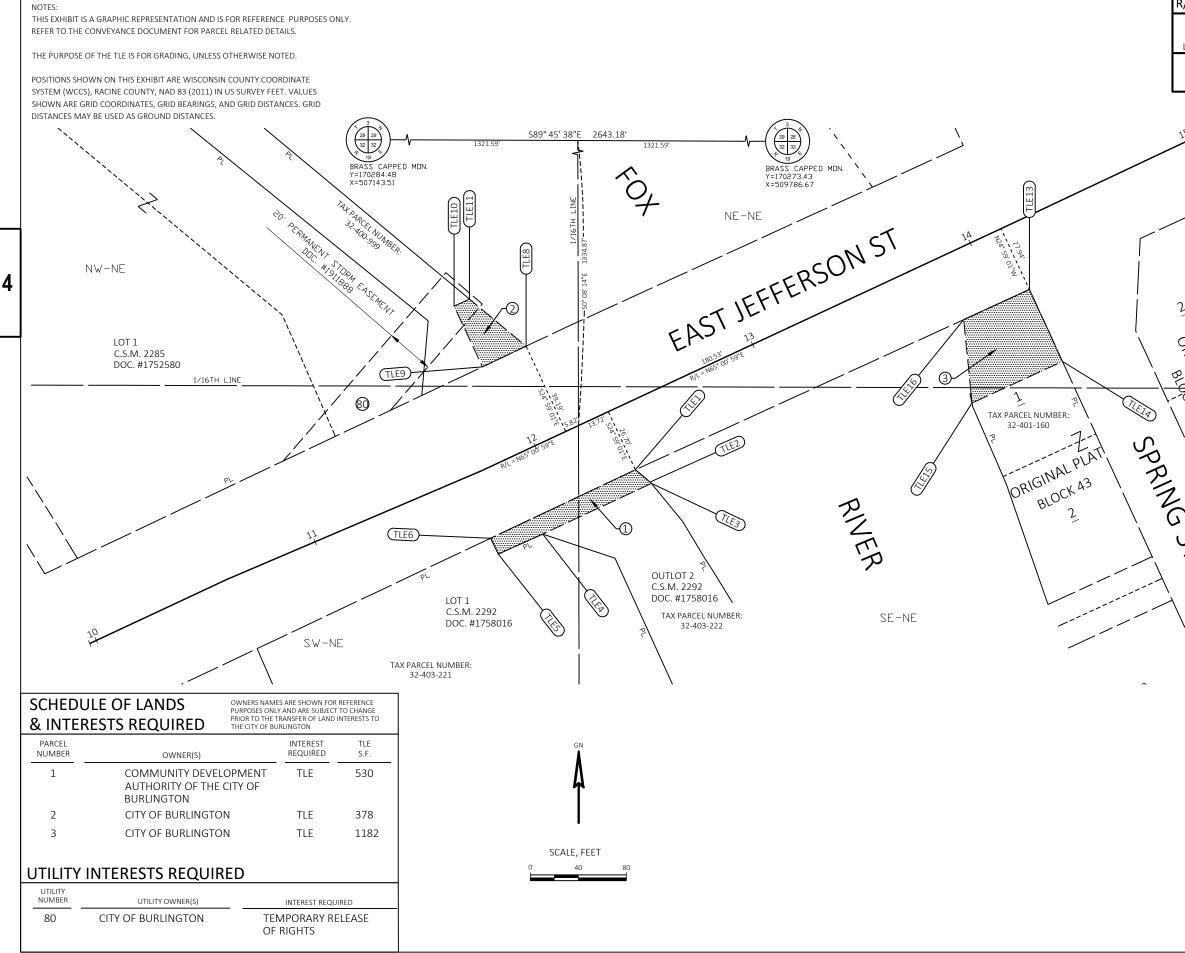
R/W PROJECT NUMBER: 3834-00-02 SHEET NUMBER: 1							
TLE ACQUISITION EXHIBIT JEFFERSON ST							
LOCAL STREET FOX RIVER BRIDGE B51-0001 RACINE COUNTY PART OF THE NW 1/4 OF THE NE 1/4, NE 1/4 OF THE NE 1/4, SE 1/4							
OF THE	NE 1/4, A	ND SW 1/4 OF	THE NE 1/4	1, ALL IN SECT	ON 32,		
T3N, R19E, CITY OF BURLINGTON, RACINE COUNTY, WISCONSIN.  STATION & OFFSET TABLE							
15	Point	Station	Offset	Northing	Easting		
	TLE 1	12+33.65	26.70'	168925.67	508492.0	00	
	TLE 2	12+37.07	33.94'	168920.55	508498.2	15	
/	TLE 3	12+37.28	34.66'	168919.99	508498.6	65	
/	TLE 4	11+87.33	34.66'	168898.89	508453.3	37	
	TLE 5	11+68.17	34.64'	168890.56	508434.8	85	
	TLE 6	11+67.90	27.33'	168897.18	508431.7	73 4	
2	TLE 8	12+14.12	-39.19'	168977.15	508446.4		
5/	TLE 9	11+94.00	-39.08'	168968.55	508428.2	27	
ORIGINAL PLAT	TLE 10	11+94.00	-67.00'	168993.86	508416.4	48	
GIN	TLE 11	12+01.02	-67.00'	168996.82	508422.8	84	
V- CF P	TLE 13	14+14.19	27.94'	169000.8	508656.3	16	
135	TLE 14	14+14.02	60.94'	168970.81	508669.9	95	
Ň.	TLE 15	13+72.53	60.73'	168953.48	508632.2	25	
	TLE 16	13+84.03	27.79'	168988.20	508628.7	76	
Ź \			COURSE	TABLE			
	Poi	nt - Poir	nt E	Bearing	Distance		
	TL	E1 - TLE2	2 S50	° 12' 54"E	8.01'		
	TL	E 2 - TLE 3	3 S41	° 27' 46"E	0.75'		
1	TL	E 3 - TLE 4	S65	° 00' 59"W	49.95'		
$\backslash$	TL	E4 - TLE5	5 S65	° 47' 16"W	20.31'		
$\backslash$	TL	E5 - TLE6	5 N25	5° 11' 40"W	7.32'		
	TL	E6 - TLE1	L N64	₽° 41' 50"E	66.66'		
١	TL	E8 - TLE9	9 S64	° 41' 50"W	20.12'		
	TL	E9 - TLE1	LO N24	° 59' 01"W	27.92'		
	TL	E 10 - TLE	11 N65	5° 00' 59"E	7.02'		
TL		E 11 - TLE	8 S50	° 12' 40"E	30.74'		
TL		E 13 - TLE	14 S24	° 41' 14"E	33.00'		
TL		E 14 - TLE	15 S65	° 18' 46"W	41.49'		
TL		E 15 - TLE	16 N05	6 N05° 44' 21"W			
		E 16 - TLE		5° 18' 46"E	30.16'		
THIS	MAP IS AF	YROVED FOR	I HE CITY O	BURLINGTON	N		
SIGN	ATURE:			1	DATE:		
	t name: jea						




# Standard Detail Drawing List

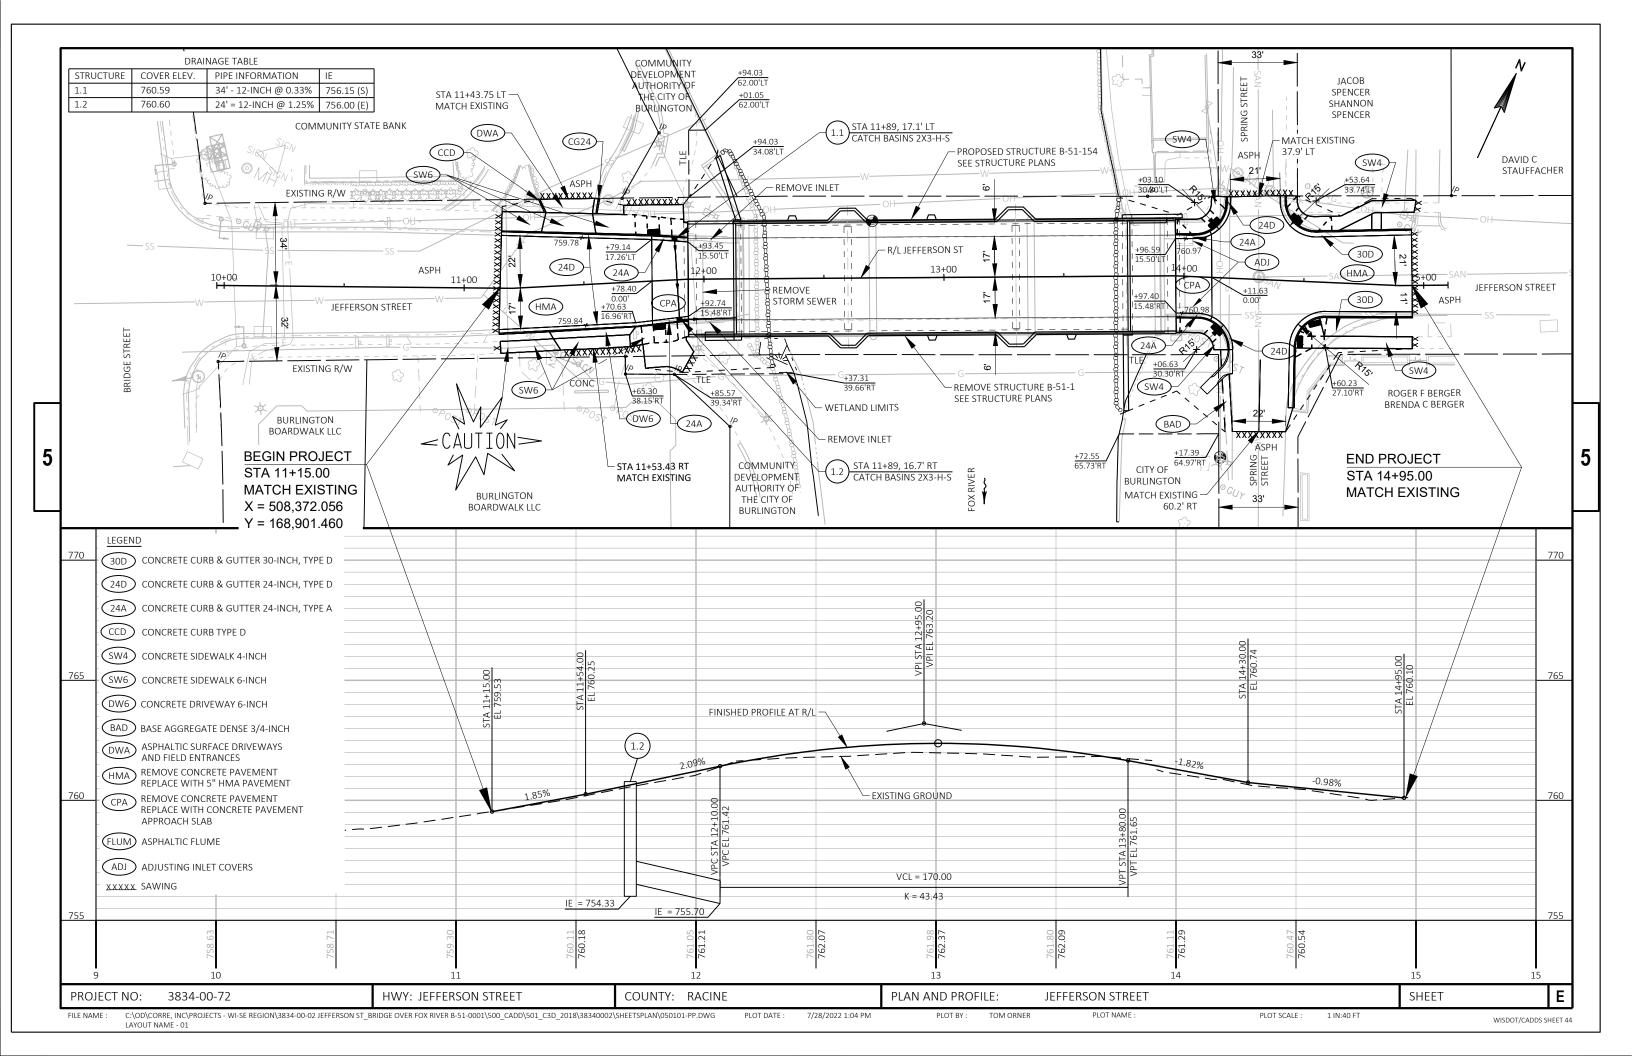08A05-19A	INLET COVERS TYPE A, H, A-S, H-S & Z
08A09-02	CATCH BASINS 2X3-FT AND 2.5X3-FT
08D01-22A	CONCRETE CURB & GUTTER
08D01-22B	CONCRETE CURB, TIES AND CURB AND GUTTER APPLICATIONS
08D04-06	CONCRETE SURFACE DRAINS & ASPHALTIC FLUMES
08d05-20a	CURB RAMPS TYPES 1 AND 1-A
08d05-20b	CURB RAMPS TYPES 2 AND 3
08D05-20C	CURB RAMPS TYPES 4A AND 4A1
08d05-20d	CURB RAMPS TYPE 4B AND 4B1
08D05-20E	CURB RAMPS TYPES 5, 6, 7A, 7B & 8
08d05-20f	CURB RAMPS RADIAL DETECTABLE WARNING FIELD APPLICATIONS
08d05-20g	CURB RAMPS RECTANGULAR AND RADIAL DETECTABLE WARNING PLATES
08D19-03	DRIVEWAY AND SIDEWALK RAMPS TYPE Z
08E09-06	SILT FENCE
08E10-02	INLET PROTECTION TYPE A, B, C AND D
08E11-02	TURBIDITY BARRIER
09в02-10	CONDUIT
12A03-10	NAME PLATE (STRUCTURES)
13B02-09A	CONCRETE PAVEMENT APPROACH SLAB
13в02-09в	STRUCTURAL APPROACH SLAB AND CONCRETE PAVEMENT APPROACH SLAB
13C19-03	HMA LONGITUDINAL JOINTS
15C02-08A	BARRICADES AND SIGNS FOR MAINLINE CLOSURES
15С02-08В	BARRICADES AND SIGNS FOR VARIOUS CLOSURES
15C02-08C	DETOUR SIGNING FOR MAINLINE CLOSURES
15C03-05	BARRICADES AND SIGNS FOR SIDEROAD CLOSURES
15C08-21A	LONGITUDINAL MARKING (MAINLINE)
15С11-09В	CHANNELIZING DEVICES DRUMS, CONES, BARRICADES AND VERTICAL PANELS
15C33-04	STOP LINE AND CROSSWALK PAVEMENT MARKING
15C35-05A	PAVEMENT MARKING (INTERSECTIONS)

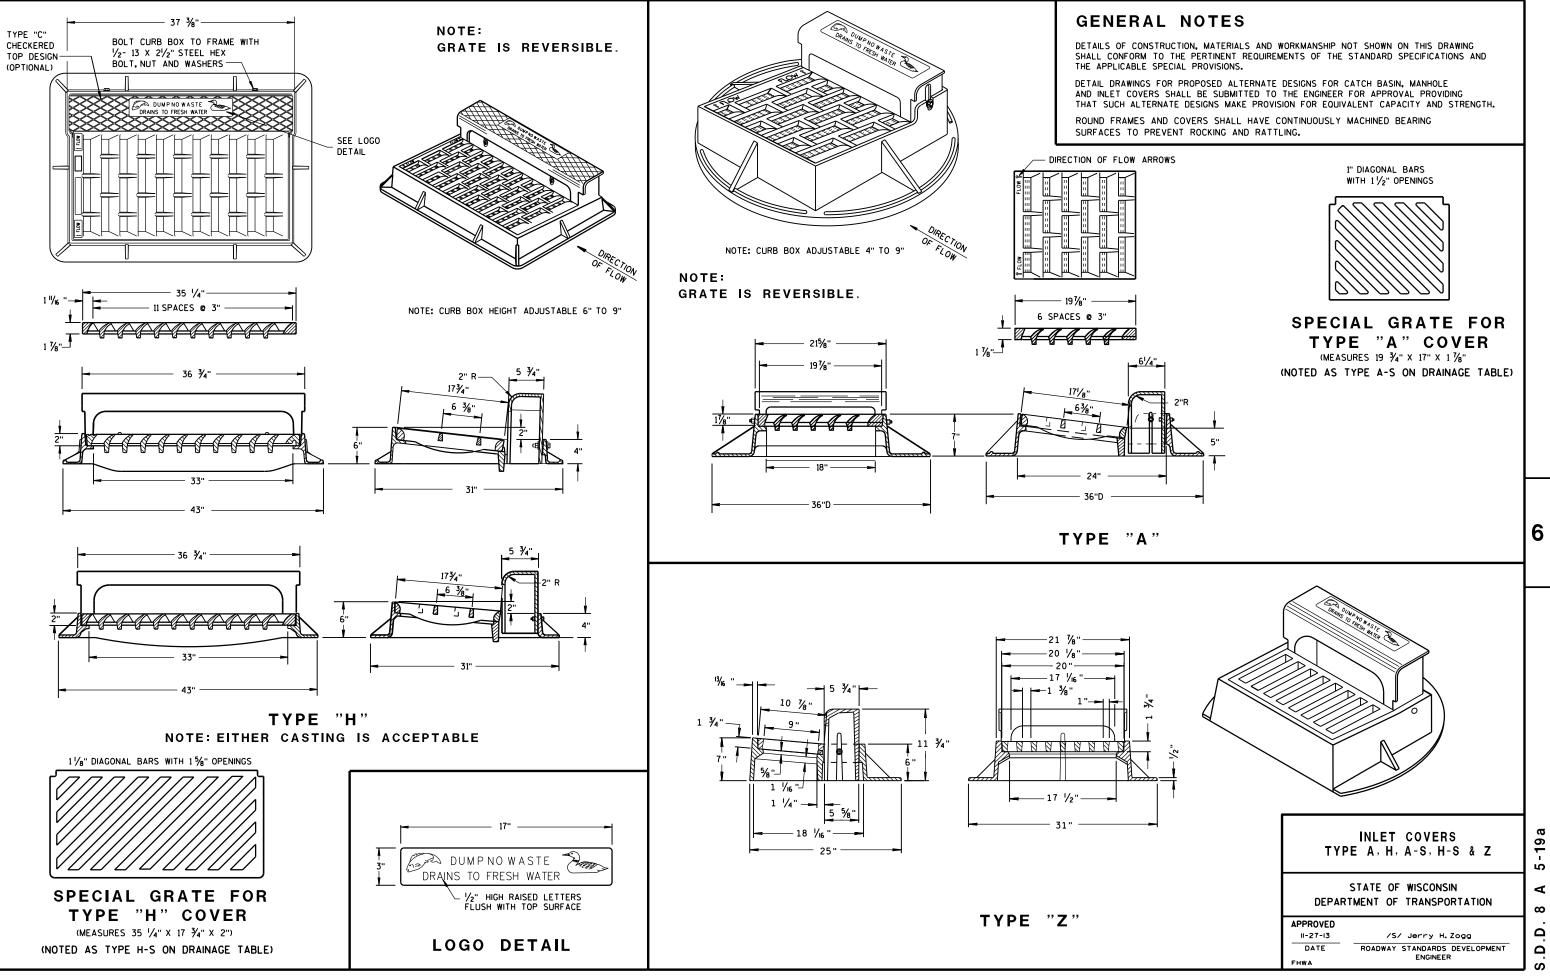

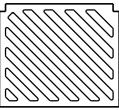

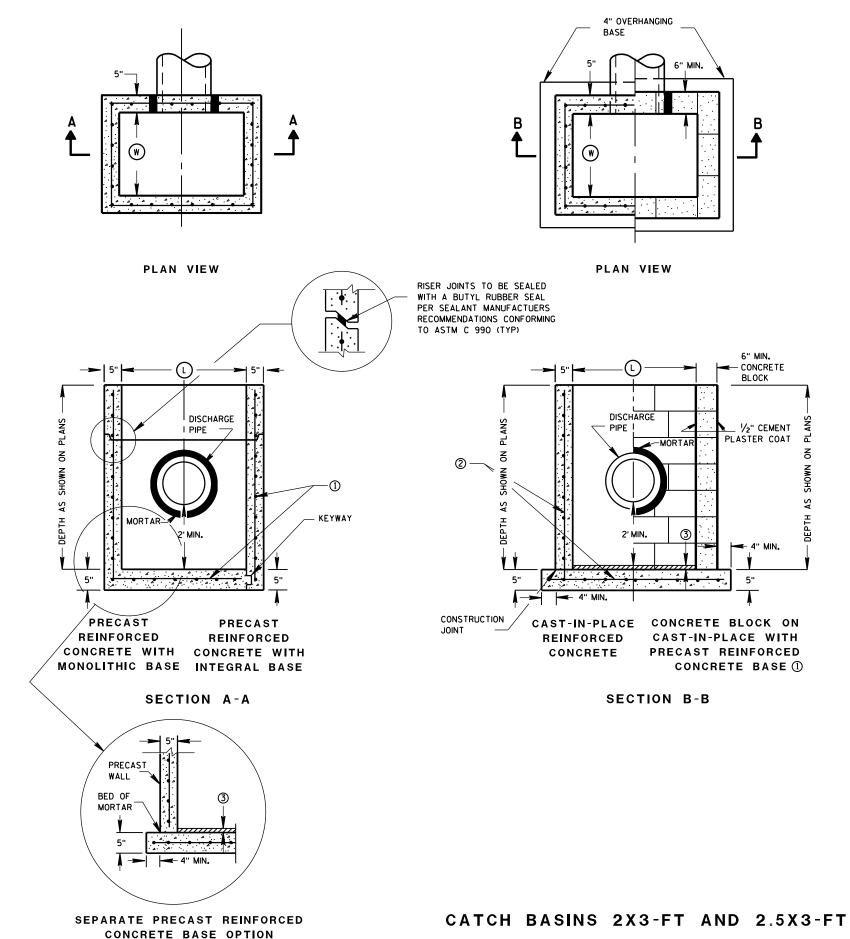

# **GENERAL NOTES**

THE ENGINEER.

EQUIVALENT CAPACITY AND STRENGTH.

SUPPORT FOR THE ENTIRE AREA OF THE BASE.

4" OVERHANG IS REQUIRED WHEN SEPARATE PRECAST BASE IS PROVIDED. OVERHANG IS NOT REQUIRED ON PRECAST STRUCTURES WITH AN INTEGRAL OR MONOLITHIC BASE.

PIPE. SEE DETAIL "A". ASSUMES PIPE ENTERS PERPENDICULAR TO THE STRUCTURE.

(1) FOR PRECAST CATCH BASINS PROVIDE REINFORCING STEEL IN ACCORDANCE TO ASTM C 913.

CAST-IN-PLACE STRUCTURES.

(3) I" CONCRETE KEY POURED AFTER INSTALLATION. 2' SUMP MEASURED FROM TOP OF KEY.

### CATCH BASIN COVER MATRIX


CATCH BASIN SIZE		INLET COVER Type	F	A
	WIDTH (W) (FT)	LENGTH () (FT)		
2X3-FT	2	3		
2.5X3-FT	2.5	3	х	


### PIPE MATRIX

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	MAXIMUM INSIDE PIPE DIAMETEI FOR TWO PIPES			
CATCH BASIN SIZE	WIDTH (IN)	LENGTH (IN		
2X3-FT	12	24		
2.5X3-FT	18	24		

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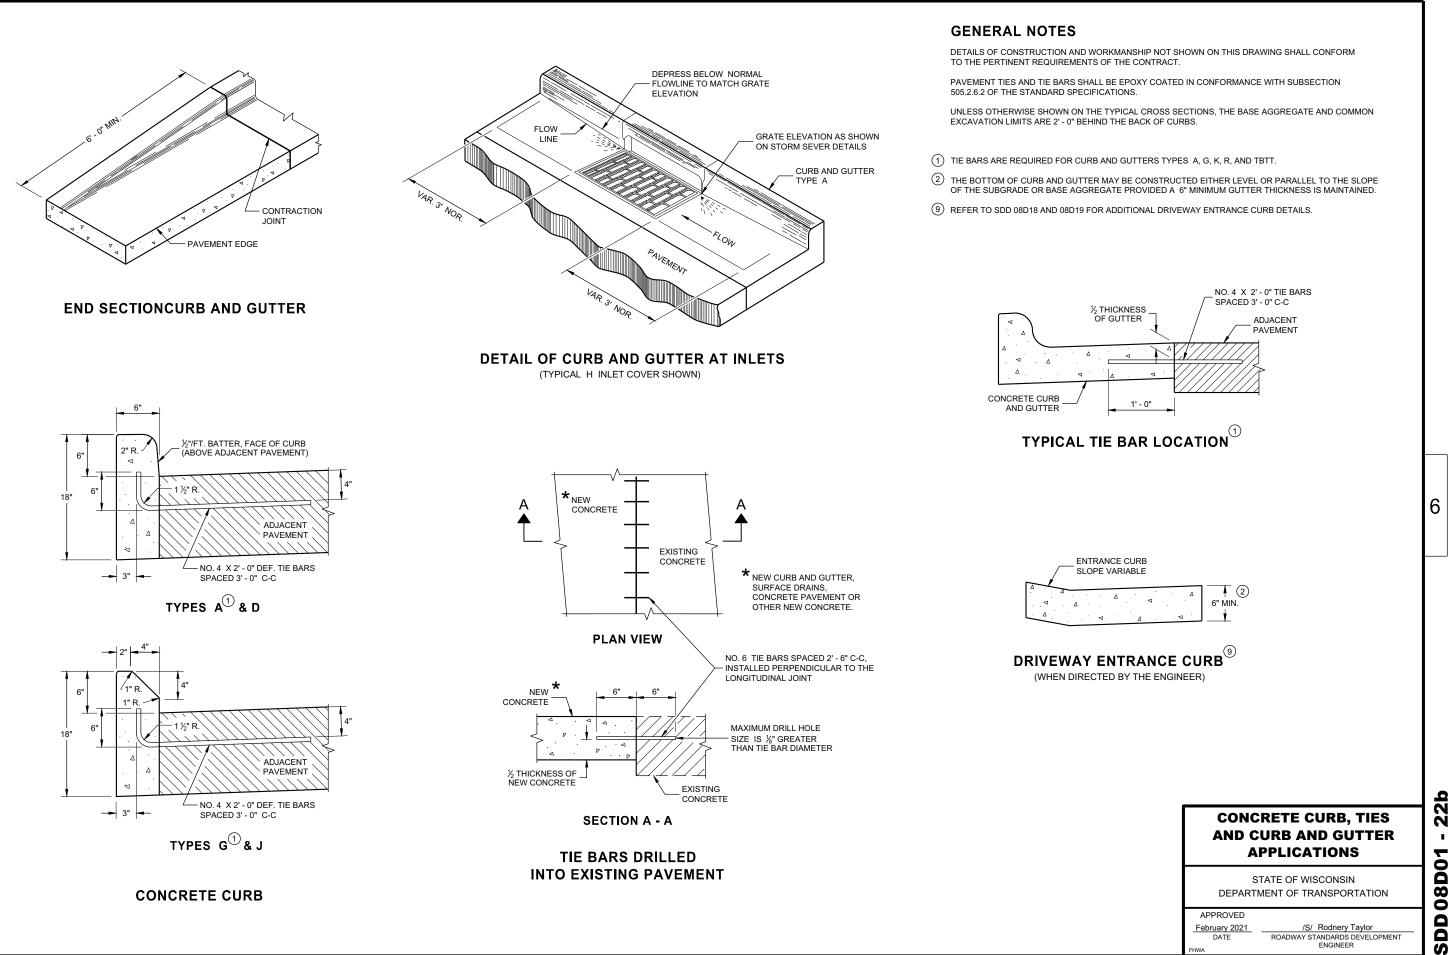


**SDD 08D01** 22a

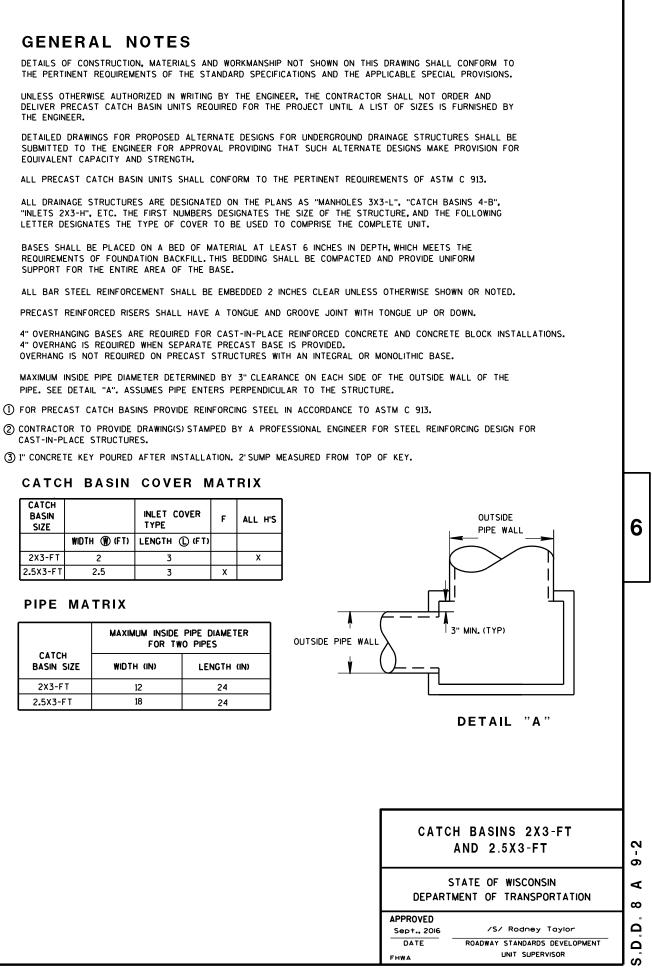
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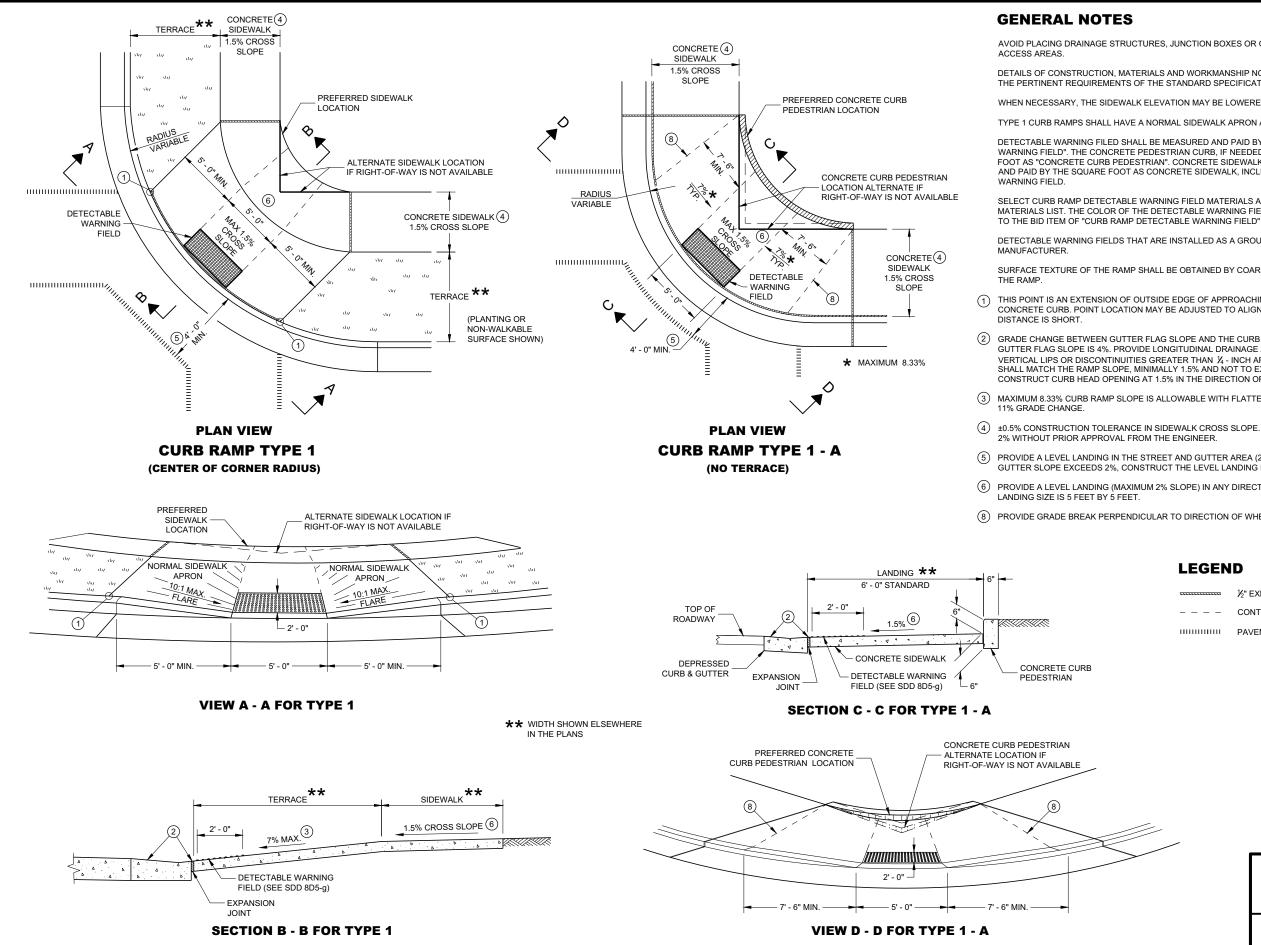
DEPARTMENT OF TRANSPORTATION

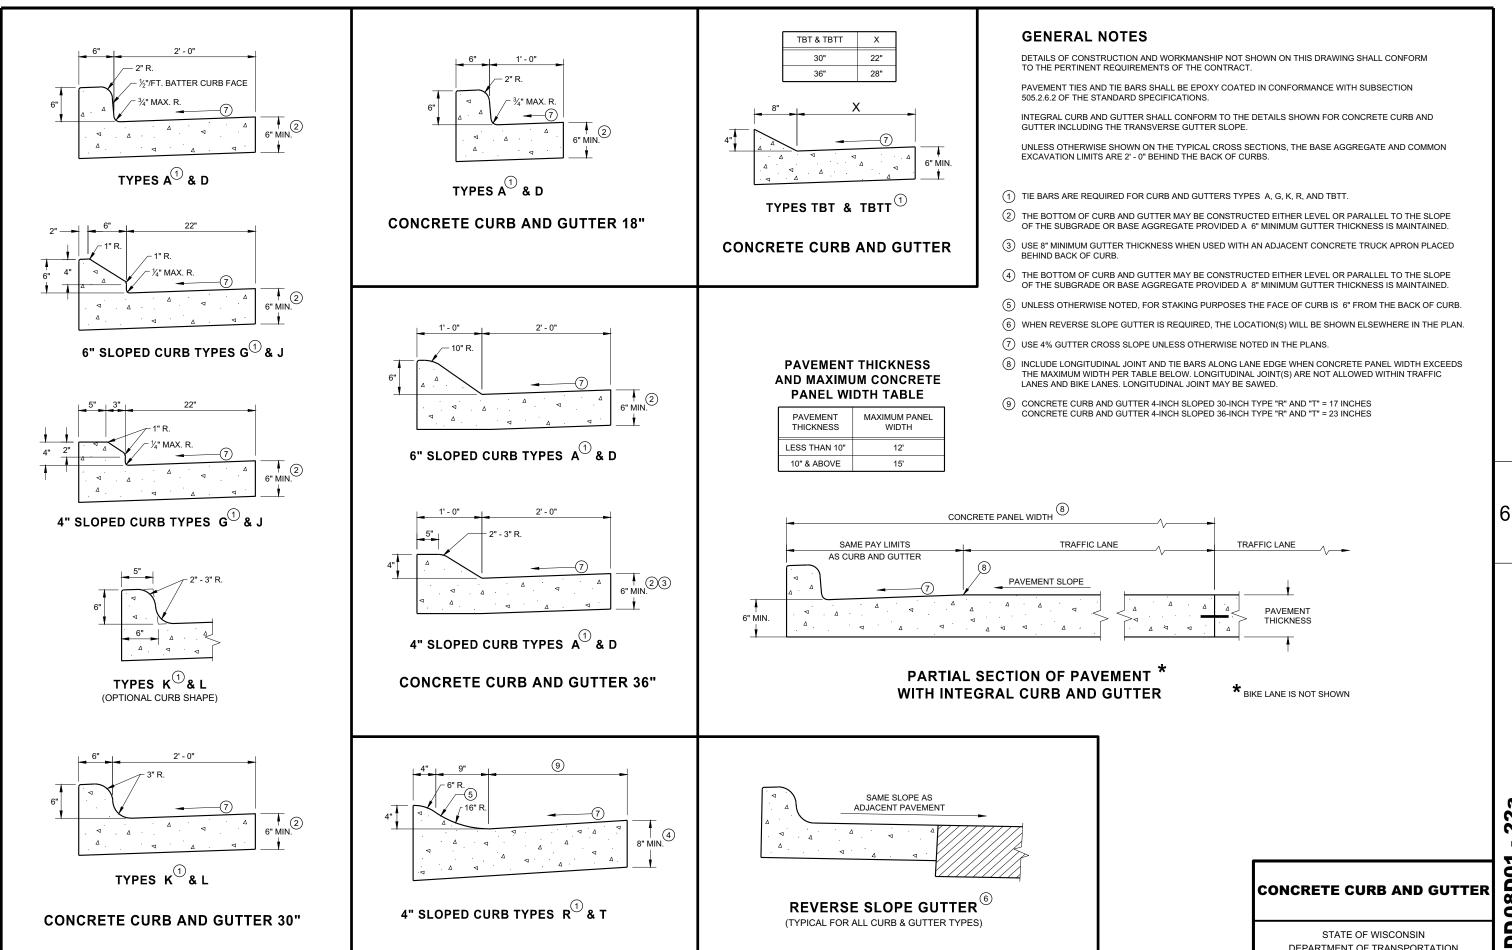22 . **08D01** SDD



**SDD 08D01 22b** 



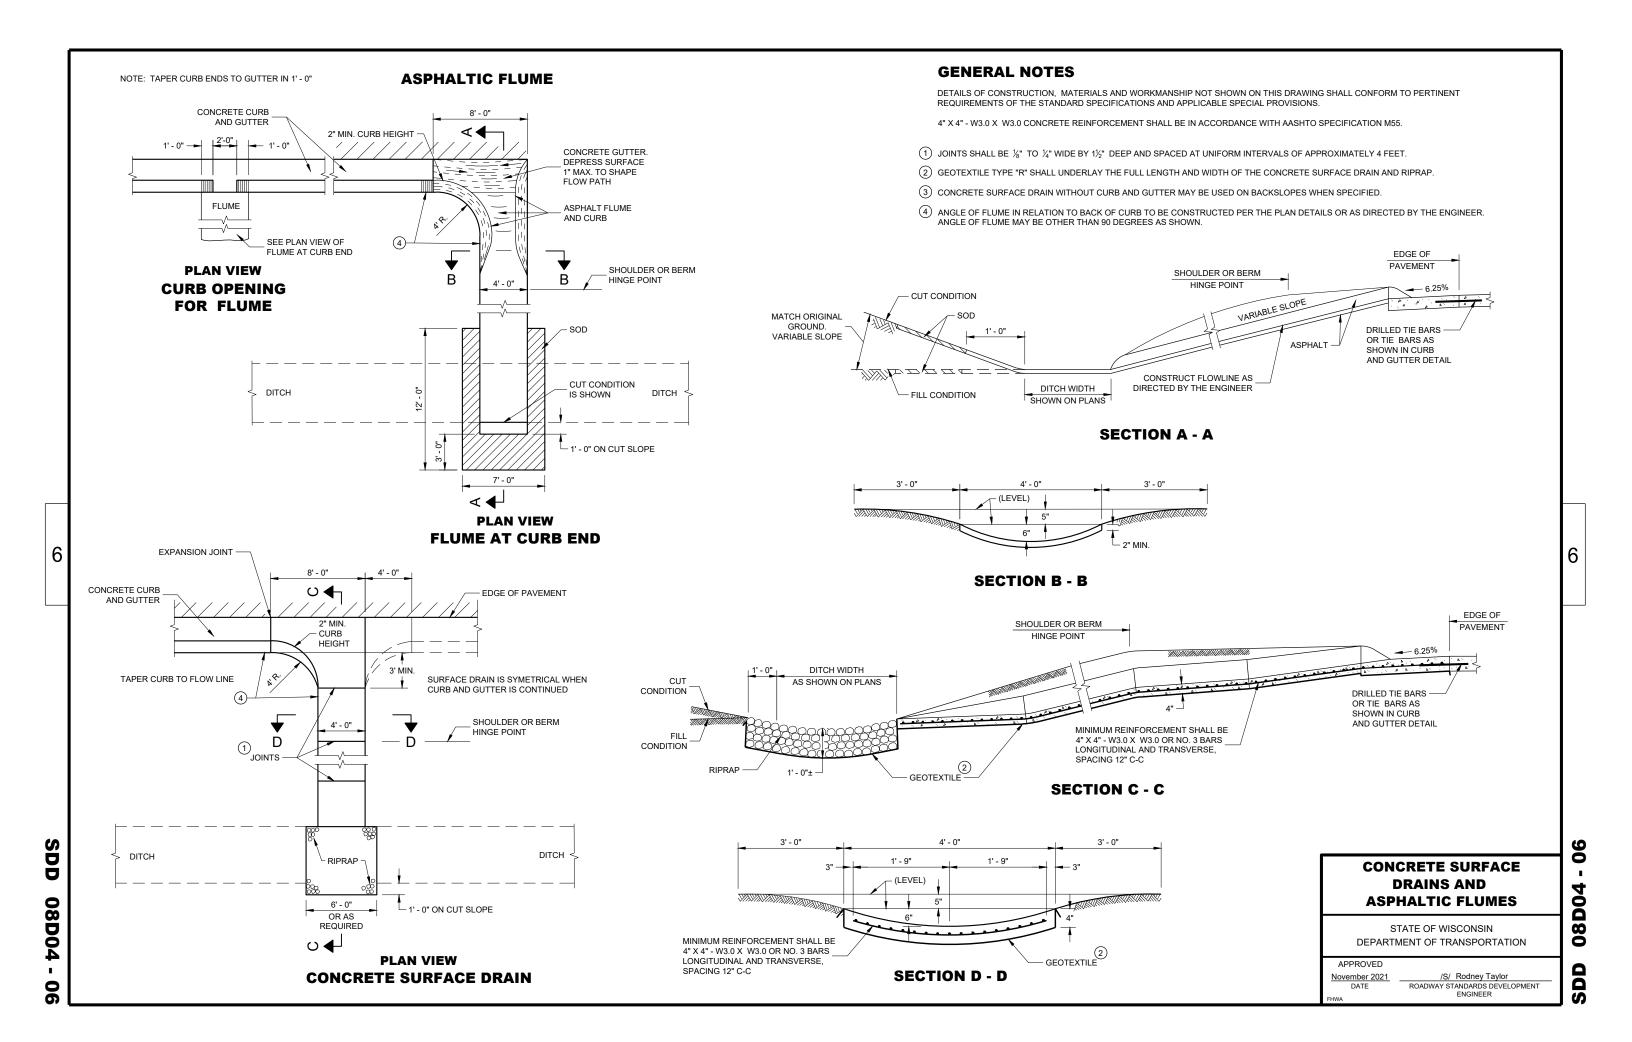

**SDD 08D05** N Öa

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AVOID PLACING DRAINAGE STRUCTURES, JUNCTION BOXES OR OTHER OBSTRUCTIONS IN FRONT OF RAMP

DETAILS OF CONSTRUCTION, MATERIALS AND WORKMANSHIP NOT SHOWN ON THIS DRAWING SHALL CONFORM TO THE PERTINENT REQUIREMENTS OF THE STANDARD SPECIFICATIONS AND THE APPLICABLE SPECIAL PROVISIONS.

WHEN NECESSARY, THE SIDEWALK ELEVATION MAY BE LOWERED TO MEET THE HIGH POINT ON THE RAMP

TYPE 1 CURB RAMPS SHALL HAVE A NORMAL SIDEWALK APRON AND CURB ON BOTH SIDES OF RAMP.

DETECTABLE WARNING FILED SHALL BE MEASURED AND PAID BY THE SQUARE FOOT AS "CURB RAMP DETECTABLE WARNING FIELD". THE CONCRETE PEDESTRIAN CURB, IF NEEDED, SHALL BE MEASURED AND PAID BY THE LINEAR FOOT AS "CONCRETE CURB PEDESTRIAN". CONCRETE SIDEWALK IN THE CURB RAMP AREA SHALL BE MEASURED AND PAID BY THE SQUARE FOOT AS CONCRETE SIDEWALK, INCLUDING THE AREA UNDER THE DETECTABLE

SELECT CURB RAMP DETECTABLE WARNING FIELD MATERIALS AND DEVICES FROM THE DEPARTMENT'S APPROVED MATERIALS LIST. THE COLOR OF THE DETECTABLE WARNING FIELD IS SPECIFIED ELSEWHERE AND IS INCIDENTAL

DETECTABLE WARNING FIELDS THAT ARE INSTALLED AS A GROUP OR SIDE BY SIDE, SHALL BE FROM THE SAME

SURFACE TEXTURE OF THE RAMP SHALL BE OBTAINED BY COARSE BROOMING TRANSVERSE TO THE SLOPE OF

THIS POINT IS AN EXTENSION OF OUTSIDE EDGE OF APPROACHING SIDEWALK WHERE IT MEETS THE BACK OF CONCRETE CURB. POINT LOCATION MAY BE ADJUSTED TO ALIGN WITH BEGINNING OF FULL-HEIGHT CURB IF THIS

(2) GRADE CHANGE BETWEEN GUTTER FLAG SLOPE AND THE CURB RAMP SLOPE SHALL NOT EXCEED 11%. MAXIMUM GUTTER FLAG SLOPE IS 4%. PROVIDE LONGITUDINAL DRAINAGE AROUND CURB AND AWAY FROM CURB RAMP. NO VERTICAL LIPS OR DISCONTINUITIES GREATER THAN 1/4 - INCH ARE ALLOWED. SLOPE OF CURB HEAD OPENING SHALL MATCH THE RAMP SLOPE, MINIMALLY 1.5% AND NOT TO EXCEED 7%. WHEN ADJACENT TO 1.5% LANDING, CONSTRUCT CURB HEAD OPENING AT 1.5% IN THE DIRECTION OF PEDESTRIAN TRAVEL.

(3) MAXIMUM 8.33% CURB RAMP SLOPE IS ALLOWABLE WITH FLATTENED GUTTER FLAG SLOPE AND NOT TO EXCEED

(4) ±0.5% CONSTRUCTION TOLERANCE IN SIDEWALK CROSS SLOPE. THE SIDEWALK CROSS SLOPE SHALL NOT EXCEED

(5) PROVIDE A LEVEL LANDING IN THE STREET AND GUTTER AREA (2% MAXIMUM SLOPE IN ANY DIRECTION). WHEN THE GUTTER SLOPE EXCEEDS 2%, CONSTRUCT THE LEVEL LANDING IN THE STREET AREA.

(6) PROVIDE A LEVEL LANDING (MAXIMUM 2% SLOPE) IN ANY DIRECTION OF PEDESTRIAN TRAVEL. STANDARD LEVEL


(8) PROVIDE GRADE BREAK PERPENDICULAR TO DIRECTION OF WHEELCHAIR TRAVEL.

### LEGEND

 $\frac{1}{2}$ " EXPANSION JOINT SIDEWALK
 CONTRACTION JOINT FIELD LOCATED
 PAVEMENT MARKING CROSSWALK (WHITE)

### **CURB RAMPS TYPE 1 AND 1-A**

STATE OF WISCONSIN DEPARTMENT OF TRANSPORTATION

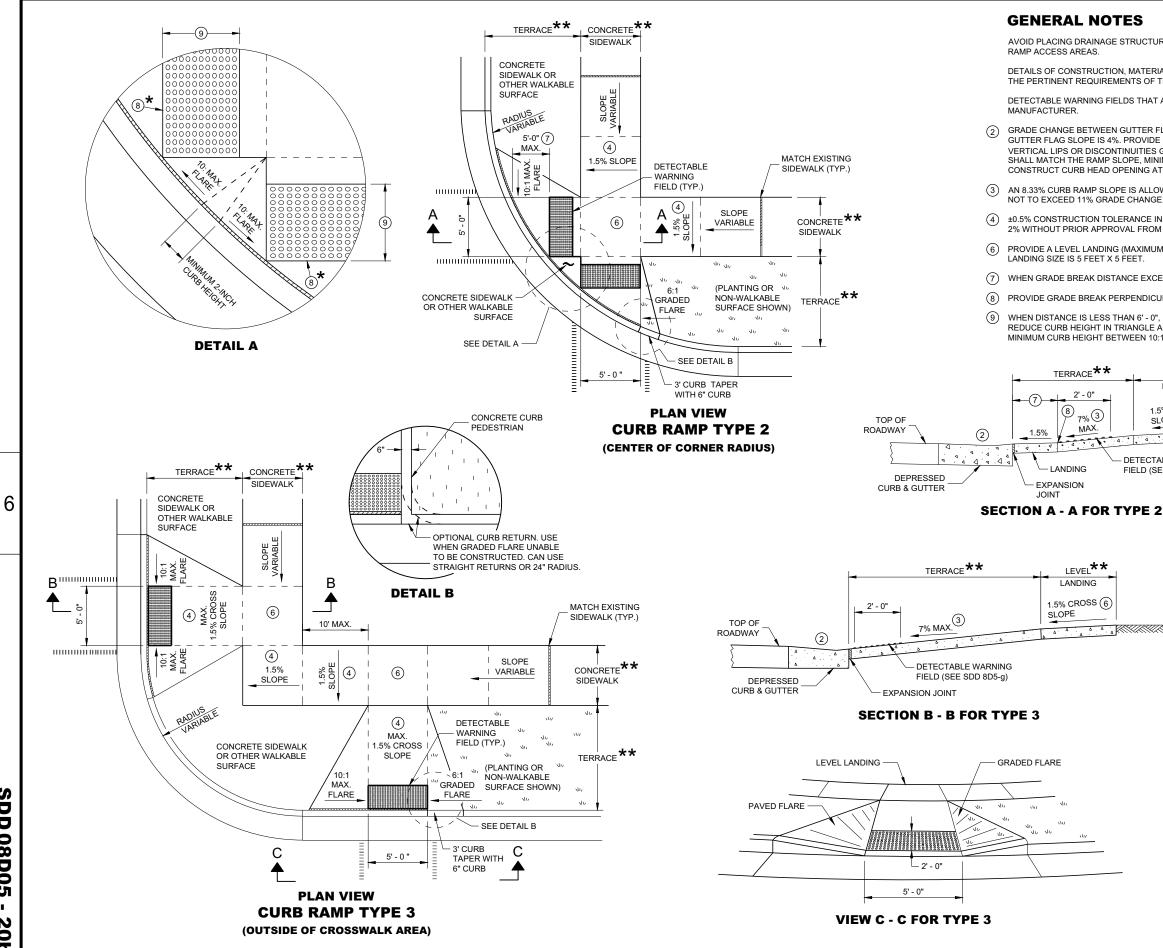



**SDD 08D05** 20Ь

CURB RAMPS TYPE 2 AND	⁵ 3 08DC
	08D05 - 20b
Image: Second system       ½" EXPANSION JOINT SIDEWALK          CONTRACTION JOINT SIDEWALK         Image: Second system       PAVEMENT MARKING CROSSWALK	(WHITE)
(SEE SDD 8D5-g)	6
LEVEL** LANDING 1.5% CROSS (6) SLOPE TABLE WARNING * MAXIMUM 2.0% SLOPE IN ALL DIRECTIONS IN FRONT OF GRADE BREAK	
ICULAR TO DIRECTION OF WHEELCHAIR TRAVEL. 0", IT MAY BE DIFFICULT TO ACHIEVE A 7% SLOPE OR FLATTER ALONG E AREA TO ACHIEVE 7% SLOPE OR FLATTER ON RAMP. CONSTRUCT 2-I 10:1 FLARES.	
MUM 2% SLOPE) IN ANY DIRECTION OF PEDESTRIAN TRAVEL. STANDARE	
E IN SIDEWALK CROSS SLOPE. THE SIDEWALK CROSS SLOPE SHALL NO OM THE ENGINEER.	
LOWABLE WITH FLATTENED GUTTER FLAG SLOPE (2.67% OR LESS) AND IGE.	)
R FLAG SLOPE AND THE CURB RAMP SLOPE SHALL NOT EXCEED 11%. IN DE LONGITUDINAL DRAINAGE AROUND CURB AND AWAY FROM CURB R ES GREATER THAN $\frac{1}{4}$ - INCH ARE ALLOWED. SLOPE OF CURB HEAD OPE IINIMALLY 1.5% AND NOT TO EXCEED 7%. WHEN ADJACENT TO 1.5% LAN E AT 1.5% IN THE DIRECTION OF PEDESTRIAN TRAVEL.	iaximum Amp. No :Ning
IF THE STANDARD SPECIFICATIONS AND THE APPLICABLE SPECIAL PRO AT ARE INSTALLED AS A GROUP OR SIDE BY SIDE SHALL BE FROM THE	
TURES, JUNCTION BOXES OR OTHER OBSTRUCTIONS IN FRONT OF	IFORM TO

STATE OF WISCONSIN DEPARTMENT OF TRANSPORTATION

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20d

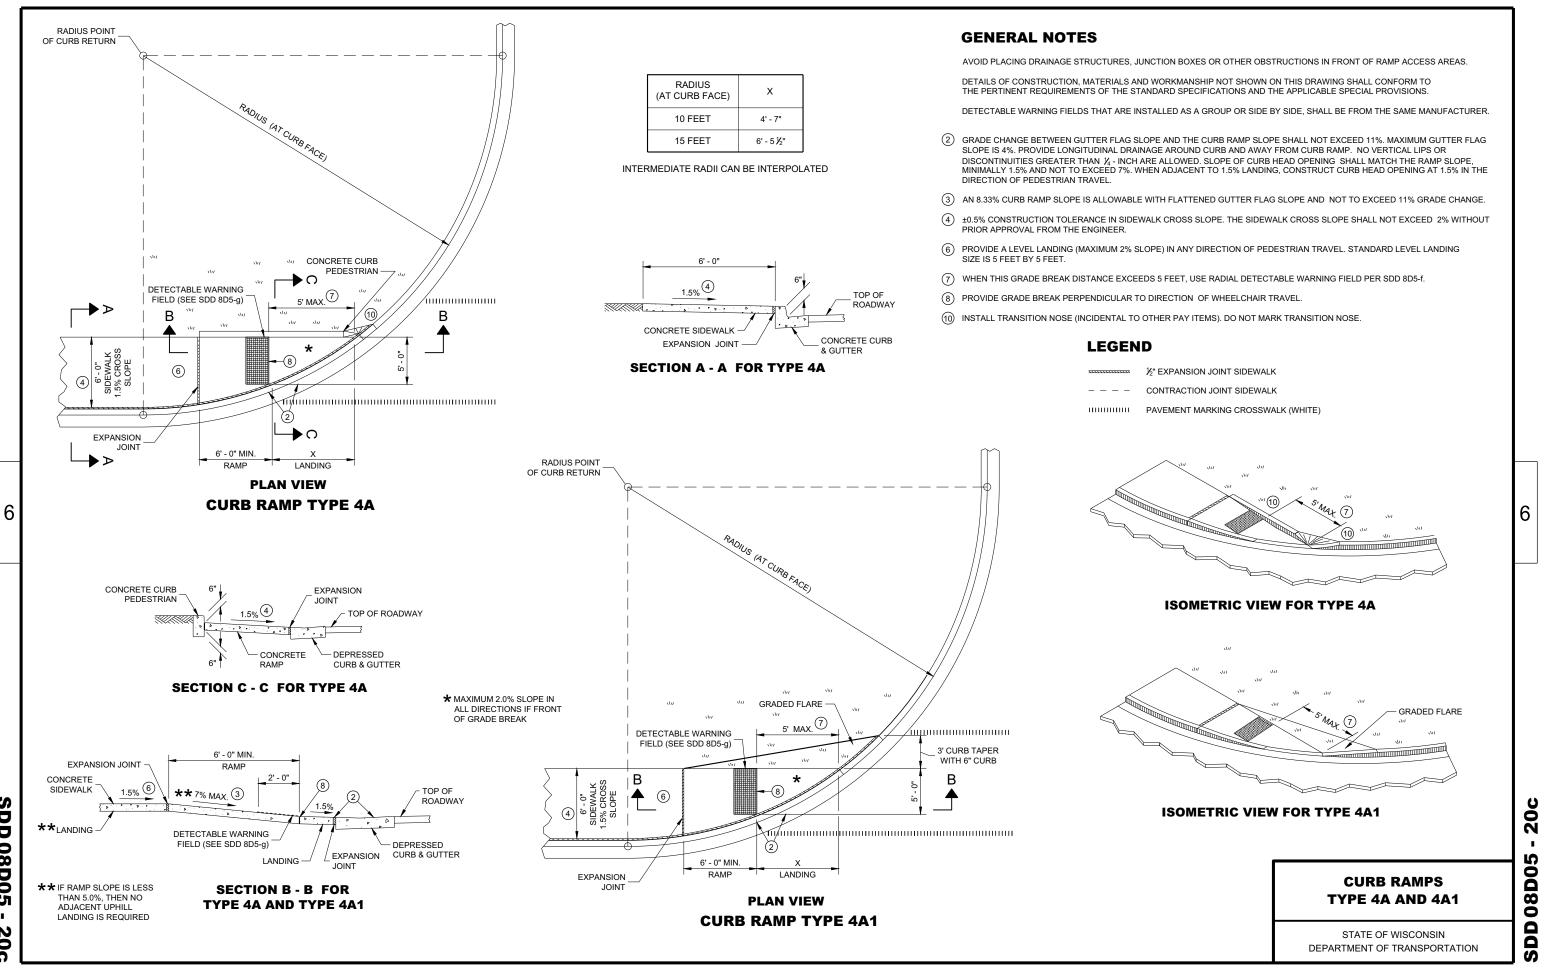9' - 0"	W = 10' - 0"			
Y	Х	Y		
7' - 2 1⁄2"	0' - 10 ¾"	7' - 7 1⁄4"		
10' - 1 ¼"	2' - 1 ¼"	10' - 9"		
14' - 8 ½"	3' - 8 ½"	15' - 8 ¼"		
18' - 5 ¾"	4' - 10 ¾"	19' - 8 ¼"		
	5' - 10 ¼"	23' - 2"		
	7' - 2 ½" 10' - 1 ¼" 14' - 8 ½"	Y         X           7' - 2 ½"         0' - 10 ¾"           10' - 1 ¼"         2' - 1 ¼"           14' - 8 ½"         3' - 8 ½"           18' - 5 ¾"         4' - 10 ¾"		

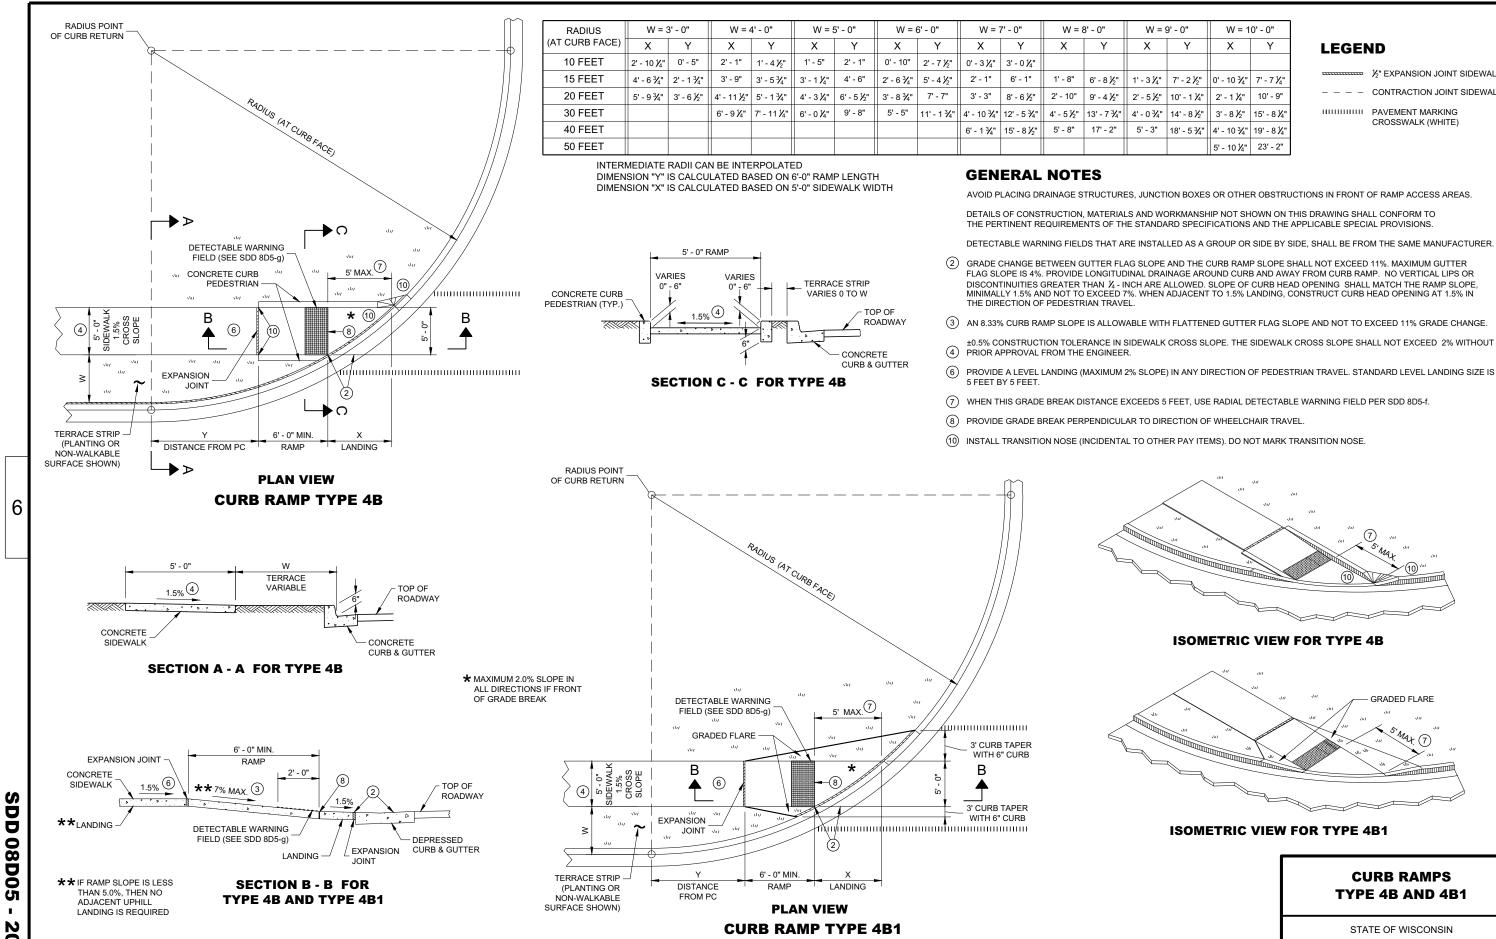 $\frac{\gamma}{2}$ " EXPANSION JOINT SIDEWALK
 CONTRACTION JOINT SIDEWALK
 PAVEMENT MARKING CROSSWALK (WHITE)

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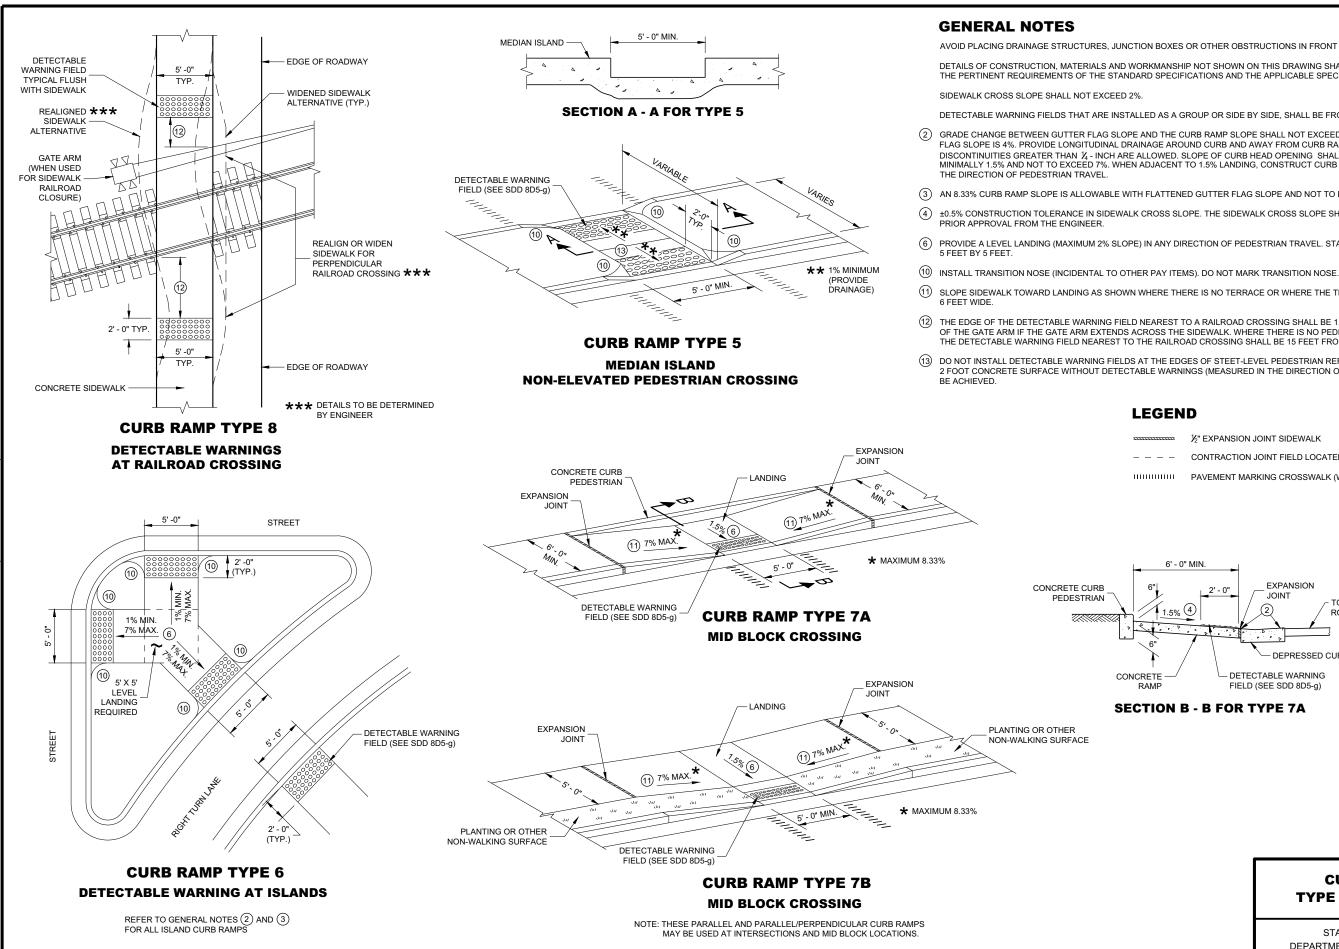
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# TYPE 4B AND 4B1

DEPARTMENT OF TRANSPORTATION





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AVOID PLACING DRAINAGE STRUCTURES, JUNCTION BOXES OR OTHER OBSTRUCTIONS IN FRONT OF RAMP ACCESS AREAS. DETAILS OF CONSTRUCTION, MATERIALS AND WORKMANSHIP NOT SHOWN ON THIS DRAWING SHALL CONFORM TO THE PERTINENT REQUIREMENTS OF THE STANDARD SPECIFICATIONS AND THE APPLICABLE SPECIAL PROVISIONS. DETECTABLE WARNING FIELDS THAT ARE INSTALLED AS A GROUP OR SIDE BY SIDE, SHALL BE FROM THE SAME MANUFACTURER. (2) GRADE CHANGE BETWEEN GUTTER FLAG SLOPE AND THE CURB RAMP SLOPE SHALL NOT EXCEED 11%. MAXIMUM GUTTER FLAG SLOPE IS 4%. PROVIDE LONGITUDINAL DRAINAGE AROUND CURB AND AWAY FROM CURB RAMP. NO VERTICAL LIPS OR DISCONTINUITIES GREATER THAN  $\frac{1}{4}$  - INCH ARE ALLOWED. SLOPE OF CURB HEAD OPENING SHALL MATCH THE RAMP SLOPE, MINIMALLY 1.5% AND NOT TO EXCEED 7%. WHEN ADJACENT TO 1.5% LANDING, CONSTRUCT CURB HEAD OPENING AT 1.5% IN (3) AN 8.33% CURB RAMP SLOPE IS ALLOWABLE WITH FLATTENED GUTTER FLAG SLOPE AND NOT TO EXCEED 11% GRADE CHANGE. (4) ±0.5% CONSTRUCTION TOLERANCE IN SIDEWALK CROSS SLOPE. THE SIDEWALK CROSS SLOPE SHALL NOT EXCEED 2% WITHOUT (6) PROVIDE A LEVEL LANDING (MAXIMUM 2% SLOPE) IN ANY DIRECTION OF PEDESTRIAN TRAVEL. STANDARD LEVEL LANDING SIZE IS 5 FEET BY 5 FEET. (1) SLOPE SIDEWALK TOWARD LANDING AS SHOWN WHERE THERE IS NO TERRACE OR WHERE THE TERRACE WIDTH IS LESS THAN (12) THE EDGE OF THE DETECTABLE WARNING FIELD NEAREST TO A RAILROAD CROSSING SHALL BE 1.5 FEET ±0.1' FROM THE FACE OF THE GATE ARM IF THE GATE ARM EXTENDS ACROSS THE SIDEWALK. WHERE THERE IS NO PEDESTRIAN GATE, THE EDGE OF THE DETECTABLE WARNING FIELD NEAREST TO THE RAILROAD CROSSING SHALL BE 15 FEET FROM THE NEAREST RAIL (13) DO NOT INSTALL DETECTABLE WARNING FIELDS AT THE EDGES OF STEET-LEVEL PEDESTRIAN REFUGE ISLANDS IF A MINIMUM 2 FOOT CONCRETE SURFACE WITHOUT DETECTABLE WARNINGS (MEASURED IN THE DIRECTION OF PEDESTRIAN TRAVEL) CANNOT LEGEND ½" EXPANSION JOINT SIDEWALK CONTRACTION JOINT FIELD LOCATED PAVEMENT MARKING CROSSWALK (WHITE) ..... 6 6' - 0" MIN EXPANSION JOINT TOP OF 1.5% (4) ROADWAY DEPRESSED CURB & GUTTER - DETECTABLE WARNING FIELD (SEE SDD 8D5-g) RAMP **SECTION B - B FOR TYPE 7A** 0 Ň . S 08D0 **CURB RAMPS TYPE 5, 6, 7A, 7B & 8** STATE OF WISCONSIN DEPARTMENT OF TRANSPORTATION ົ





DO NOT EMBED IN CONCRETE ANY FIELD-CUT PLATES WITH CUT EDGES SHORTER THAN 6 INCHES. CONSULT WITH MANUFACTURER FOR RE-DRILLING AND ANCHORING REQUIREMENTS OF FIELD-CUT PLATES.

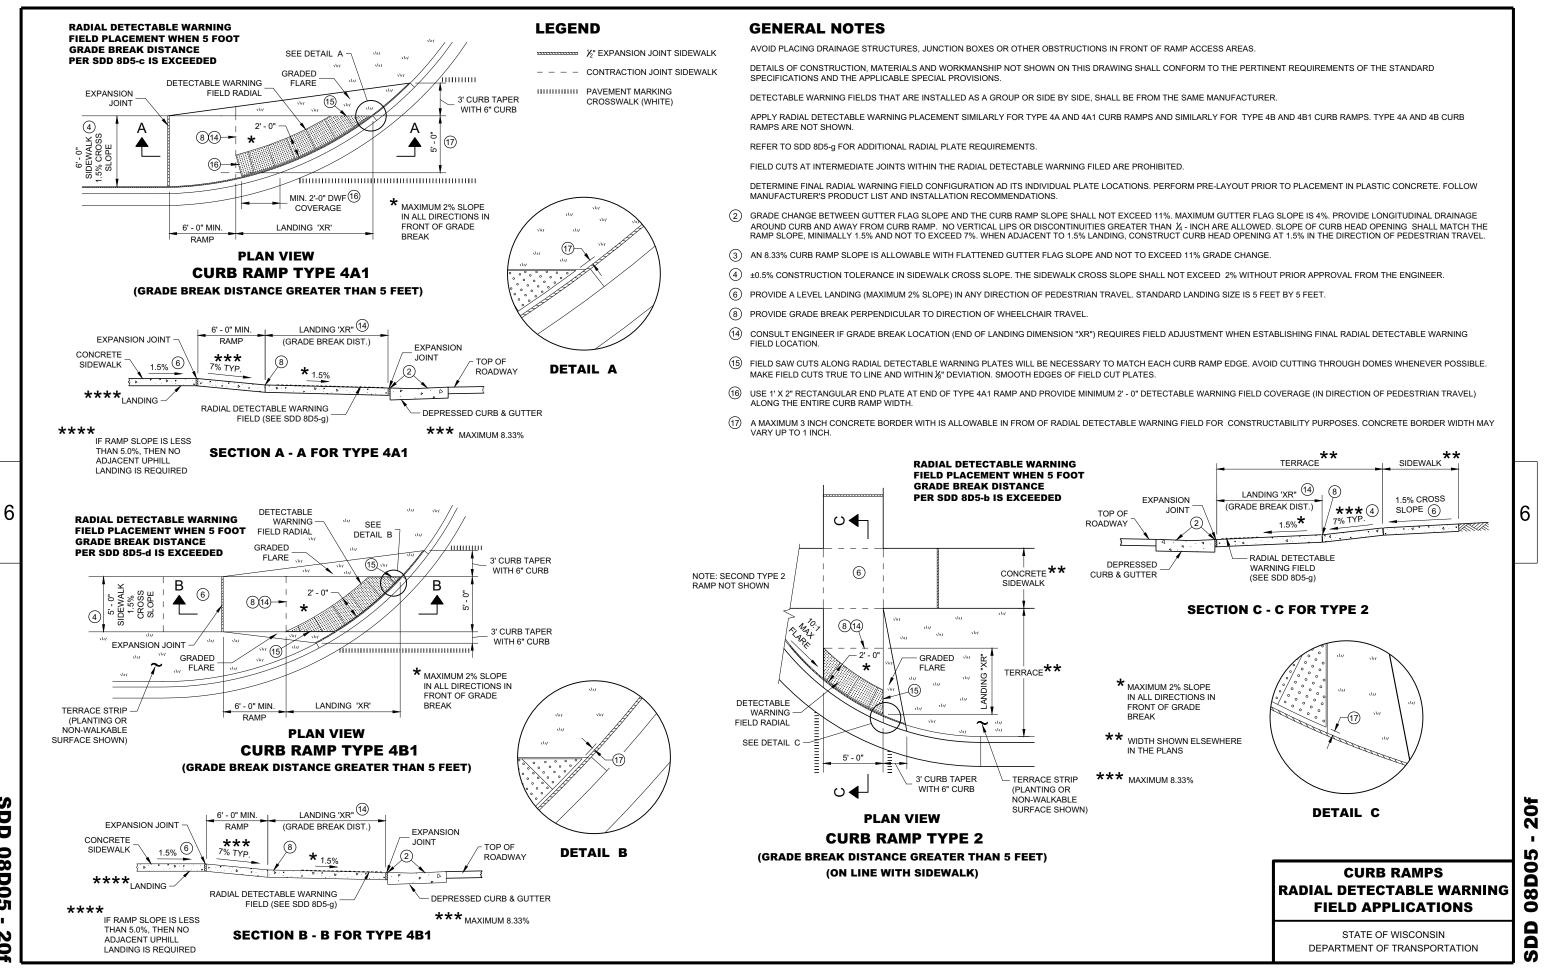
**GENERAL NOTES** 

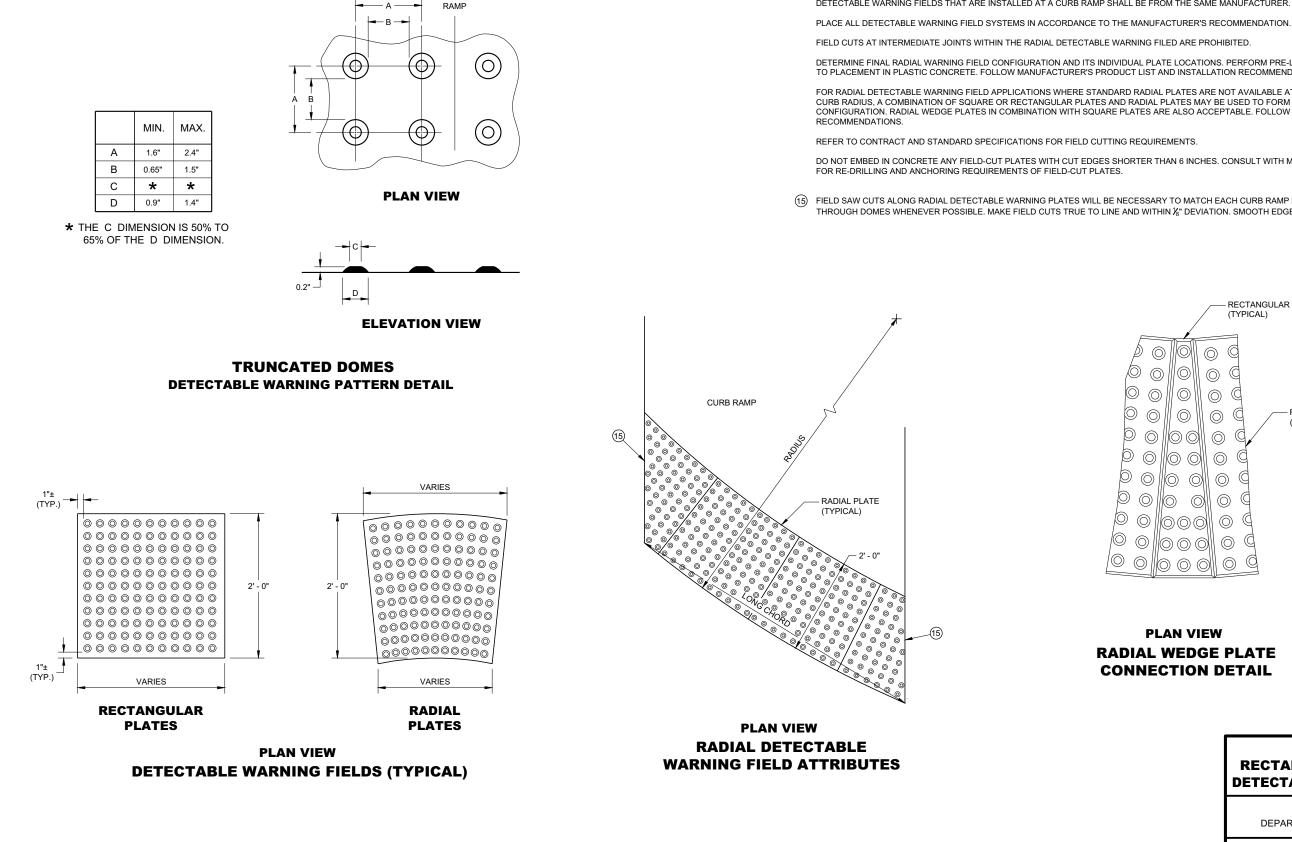(15) FIELD SAW CUTS ALONG RADIAL DETECTABLE WARNING PLATES WILL BE NECESSARY TO MATCH EACH CURB RAMP EDGE. AVOID CUTTING THROUGH DOMES WHENEVER POSSIBLE. MAKE FIELD CUTS TRUE TO LINE AND WITHIN X[®] DEVIATION. SMOOTH EDGES OF FIELD CUT PLATES.

**SDD 08D05** 20g

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- DETECTABLE WARNING FIELDS THAT ARE INSTALLED AT A CURB RAMP SHALL BE FROM THE SAME MANUFACTURER.
- DETERMINE FINAL RADIAL WARNING FIELD CONFIGURATION AND ITS INDIVIDUAL PLATE LOCATIONS. PERFORM PRE-LAYOUT PRIOR TO PLACEMENT IN PLASTIC CONCRETE. FOLLOW MANUFACTURER'S PRODUCT LIST AND INSTALLATION RECOMMENDATIONS.
- FOR RADIAL DETECTABLE WARNING FIELD APPLICATIONS WHERE STANDARD RADIAL PLATES ARE NOT AVAILABLE AT AN INTERSECTION CURB RADIUS, A COMBINATION OF SQUARE OR RECTANGULAR PLATES AND RADIAL PLATES MAY BE USED TO FORM RADIAL CONFIGURATION. RADIAL WEDGE PLATES IN COMBINATION WITH SQUARE PLATES ARE ALSO ACCEPTABLE. FOLLOW MANUFACTURER'S

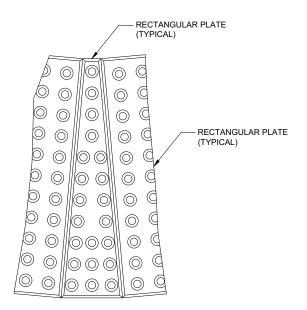

### **PLAN VIEW RADIAL WEDGE PLATE CONNECTION DETAIL**

### **CURB RAMPS RECTANGULAR AND RADIAL DETECTABLE WARNING PLATES**

STATE OF WISCONSIN DEPARTMENT OF TRANSPORTATION

APPROVED May 2019 DATE

/S/ Rodney Taylor ROADWAY STANDARDS DEVELOPMENT UNIT SUPERVISOR

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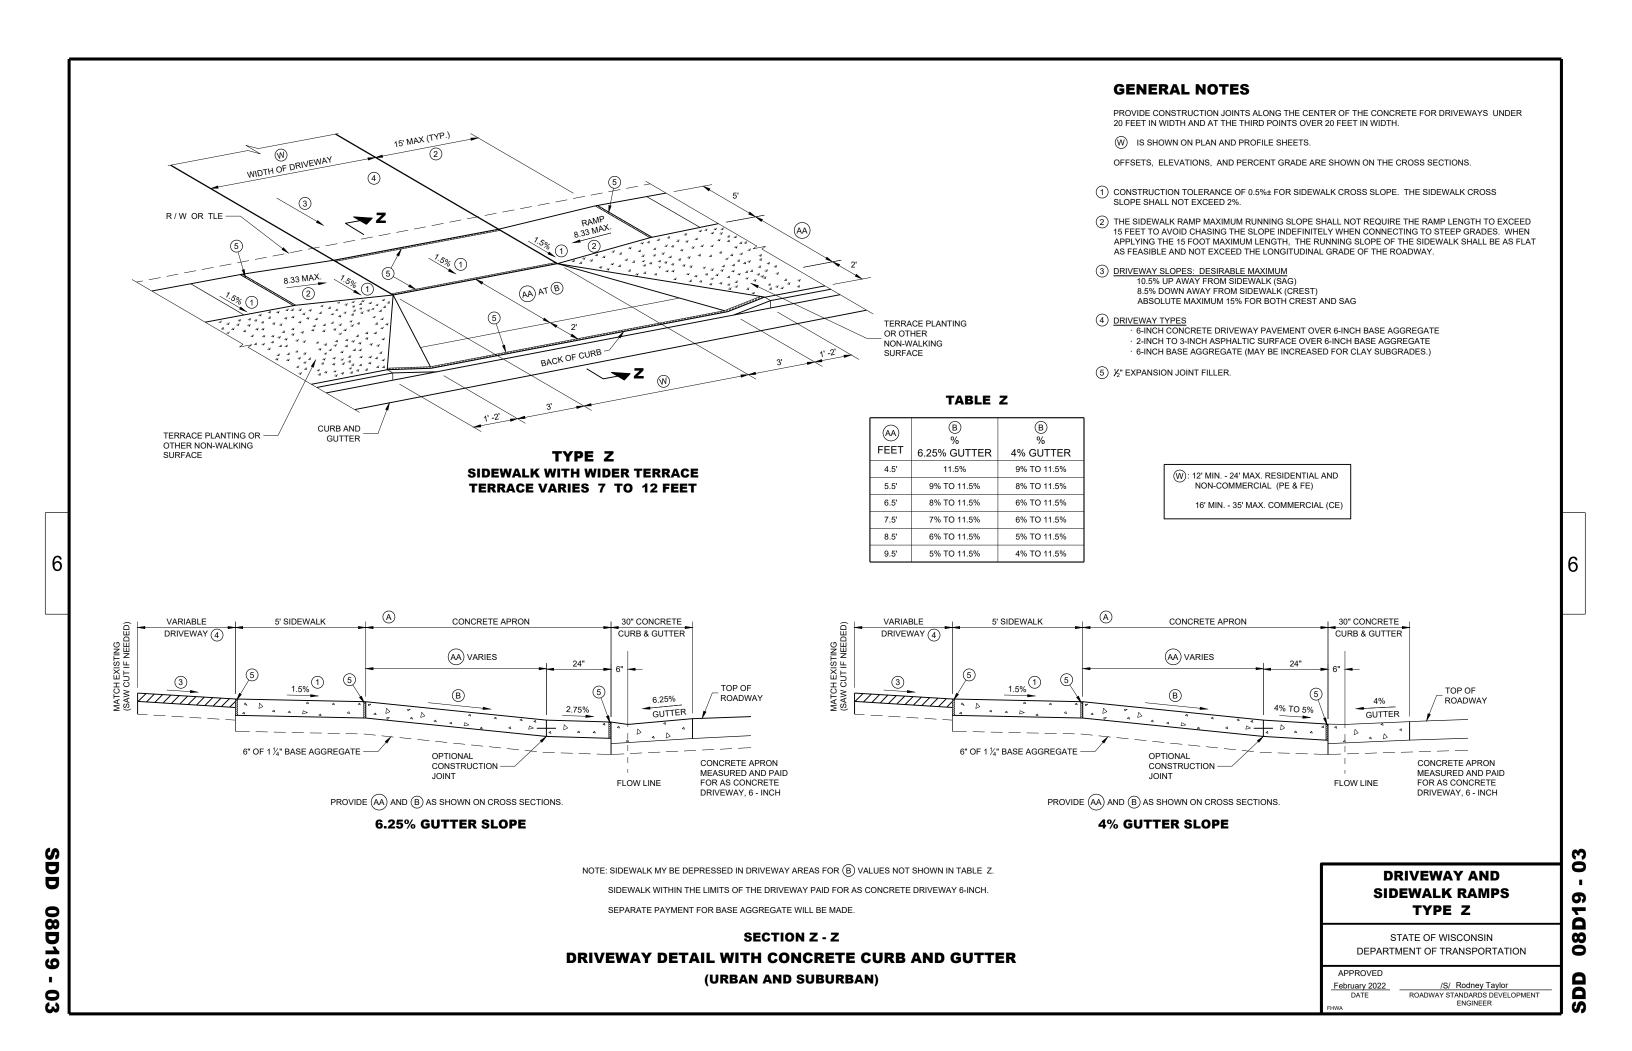
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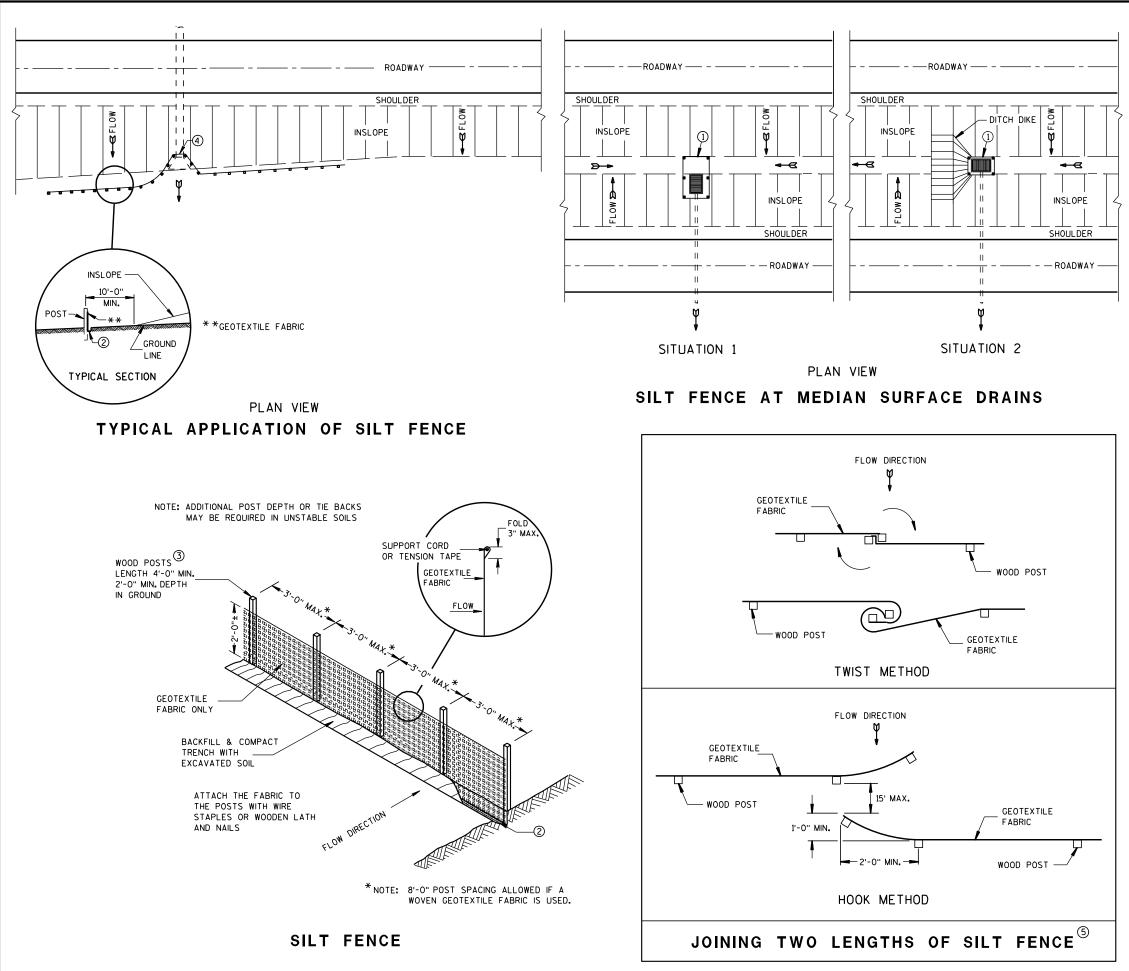
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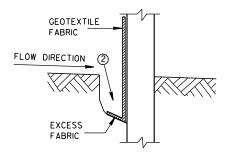
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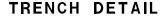
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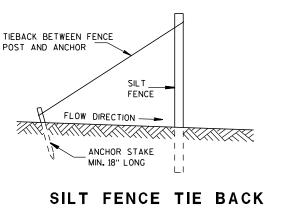
### **GENERAL NOTES**

DETAILS OF CONSTRUCTION NOT SHOWN ON THIS DRAWING SHALL CONFORM TO THE PERTINENT REQUIREMENTS OF THE STANDARD SPECIFICATIONS AND APPLICABLE SPECIAL PROVISIONS.


- $\bigcirc$  horizontal brace required with 2" x 4" wooden frame or equivalent at top of posts.
- (2) FOR MANUAL INSTALLATIONS THE TRENCH SHALL BE A MINIMUM OF 4" WIDE & 6" DEEP TO BURY AND ANCHOR THE GEOTEXTILE FABRIC. FOLD MATERIAL TO FIT TRENCH AND BACKFILL & COMPACT TRENCH WITH EXCAVATED SOIL.
- (3) WOOD POSTS SHALL BE A MINIMUM SIZE OF  $1/_8$ " X  $1/_8$ " OF OAK OR HICKORY.
- (4) SILT FENCE TO EXTEND ACROSS THE TOP OF THE PIPE.
- (5) CONSTRUCT SILT FENCE FROM A CONTINUOUS ROLL IF POSSIBLE BY CUTTING LENGTHS TO AVOID JOINTS. IF A JOINT IS NECESSARY USE ONE OF THE FOLLOWING TWO METHODS; A) OVERLAP THE END POSTS AND TWIST, OR ROTATE, AT LEAST 180 DEGREES, B) HOOK THE END OF EACH SILT FENCE LENGTH.









(WHEN REQUIRED BY THE ENGINEER)

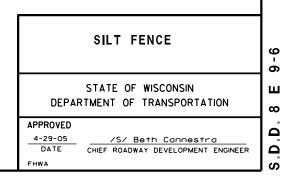


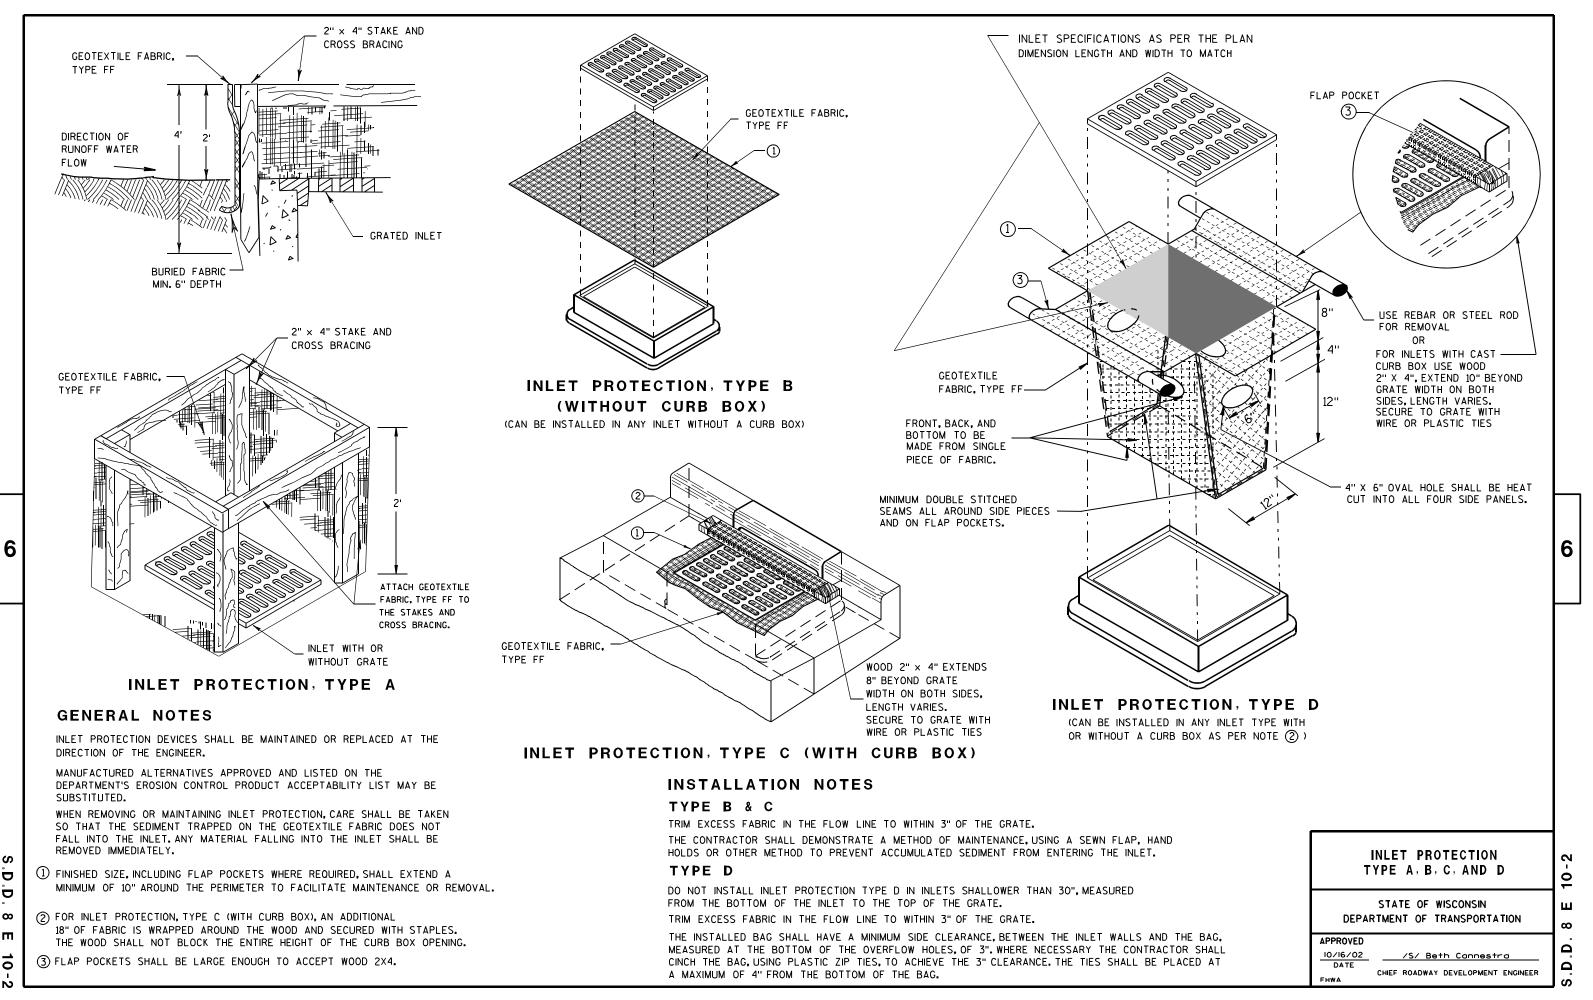


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- WATER ELEVATIONS.

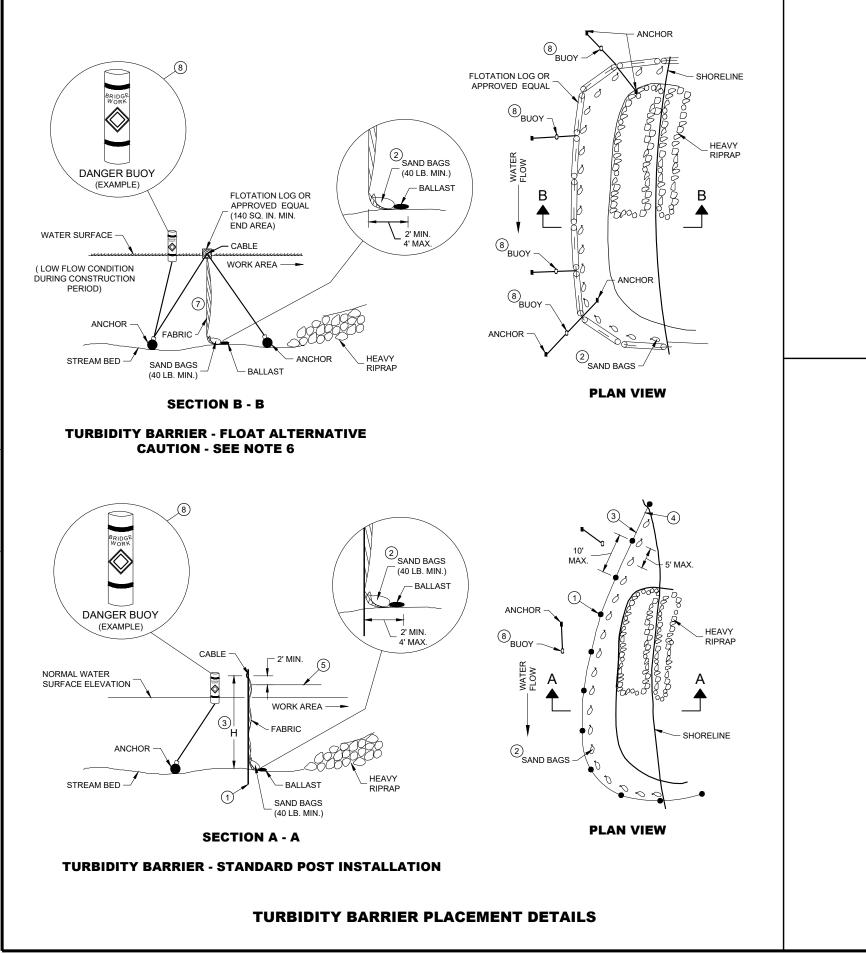

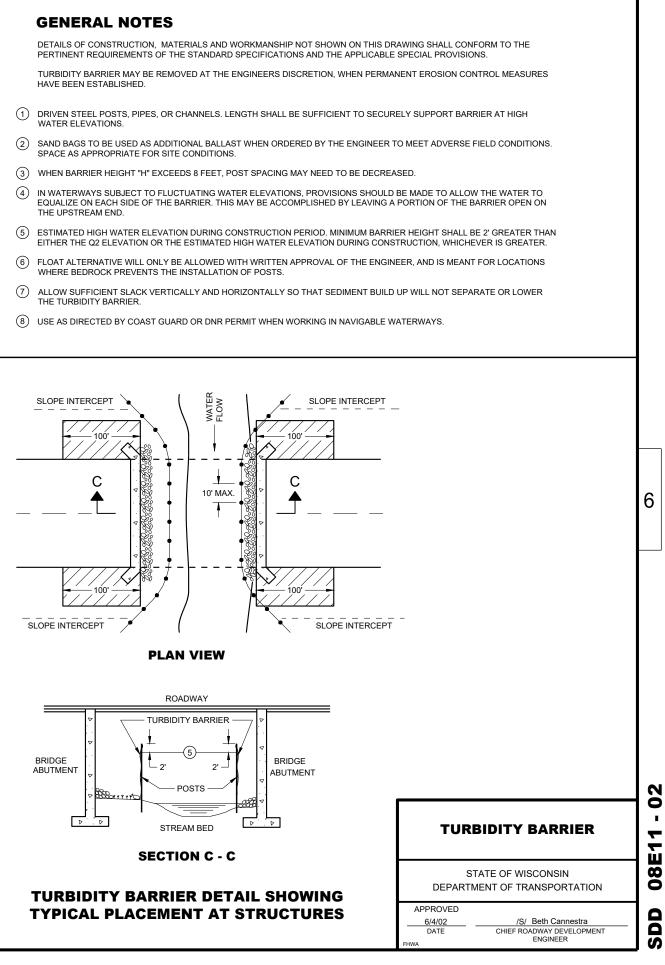

SDD 08E -. 02

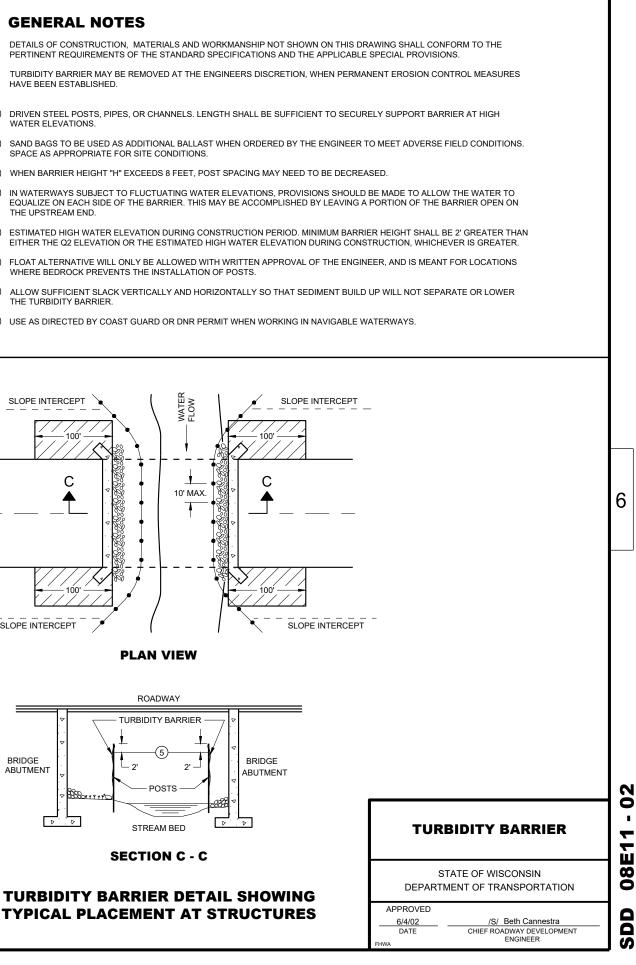METALLIC (STANDARD SPECIFICATION 652.2.2) OR NONMETALLIC (STANDARD SPECIFICATION 652.2.3) CONDUIT SHALL BE FURNISHED AND PLACED AS SHOWN.

AND 36 INCHES MAXIMUM.

DEPTH OF CONDUIT INSTALLED THAT IS NOT BELOW THE TRAVELED WAY SHALL BE 18 INCHES MINIMUM AND 36 INCHES MAXIMUM.

ANY EXCEPTION TO THE MAXIMUM DEPTH SHALL BE ONLY WITH THE WRITTEN APPROVAL OF THE ENGINEER.

THE TRENCH SHALL NOT BE BACKFILLED PRIOR TO INSPECTION OF THE CONDUIT.

ALL METALLIC CONDUIT RACEWAY ENDS SHALL BE REAMED AND THREADED.

ALL METALLIC CONDUIT IN WHICH WIRE OR CABLE IS TO BE INSTALLED SHALL BE BUSHED WITH APPROVED THREADED BUSHINGS BEFORE INSTALLATION OF THE WIRE OR CABLE.

ALL METALLIC CONDUITS IN WHICH WIRE OR CABLE IS NOT TO BE INSTALLED SHALL BE CAPPED WITH THREADED PROTECTIVE CAPS, AS APPROVED BY THE ENGINEER.

ALL NONMETALLIC CONDUIT SHALL BE CAPPED OR PLUGGED IMMEDIATELY AFTER INSTALLATION AND SHALL REMAIN CAPPED OR PLUGGED UNTIL WIRE/CABLES ARE INSTALLED.

CAPPED OR PLUGGED.

BENDING OF PVC ELECTRICAL CONDUIT SHALL BE ACCOMPLISHED BY USING A BLANKET OR EMERSION TYPE TANK DESIGNED FOR THE PURPOSE OF BENDING PVC ELECTRICAL CONDUIT.


CONDUIT. (SEE NEC 347.5)


WHEN REQUIRED TO CONNECT NONMETALLIC CONDUIT TO METALLIC CONDUIT, ONLY U.L. LISTED ADAPTER FITTINGS SHALL BE USED.

ATTACHED.

CONDUIT RUNS SHALL BE THE SAME SIZE OF CONDUIT FROM ONE END TO THE OTHER (FROM PULL BOX TO PULL BOX-OR-JUNCTION BOX TO JUNCTION BOX-OR-BASE TO BASE, ETC.).

ALL CONDUIT RUNS SHALL BE STRAIGHT (WITHOUT BENDS) FROM PULL BOX TO PULL BOX, PULL BOX TO BASE AND BASE TO BASE AS SHOWN ON THE PLANS.

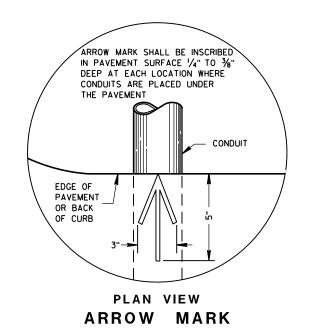

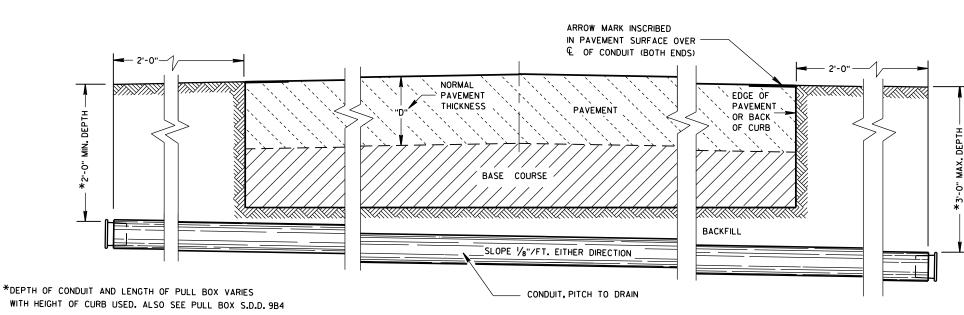

SIDE ELEVATION DETAIL FOR CONDUIT UNDER PAVED HIGHWAYS

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DETAILS OF CONSTRUCTION, MATERIALS AND WORKMANSHIP NOT SHOWN ON THIS DRAWING SHALL CONFORM TO THE PERTINENT REQUIREMENTS OF THE CONTRACT.

DEPTH OF CONDUIT INSTALLED BELOW THE TRAVELED WAY SHALL BE 24 INCHES MINIMUM

NONMETALLIC CONDUITS IN WHICH WIRE OR CABLE IS NOT BEING INSTALLED SHALL REMAIN

ALL CUT ENDS SHALL BE TRIMMED INSIDE AND OUTSIDE TO REMOVE ALL ROUGH EDGES ON NONMETALLIC

PRIOR TO CONDUIT ACCEPTANCE, CONDUIT CAPS OR PLUGS SHALL BE REMOVED, AND THE CAPS, PLUGS AND CONDUIT ENDS SHALL BE THOROUGHLY CLEANED AND THEN THE CAPS OR PLUGS REIN-STALLED TO ENSURE THAT THE CAPS OR PLUGS CAN BE EASILY REMOVED IN THE FUTURE.

ALL CONDUIT BEING FURNISHED AND INSTALLED SHALL HAVE THE U.L. LABEL FIRMLY

TRACER WIRE SHALL BE INSTALLED AS STATED IN THE STANDARD SPECIFICATION, ITEM 652.3.1.1.

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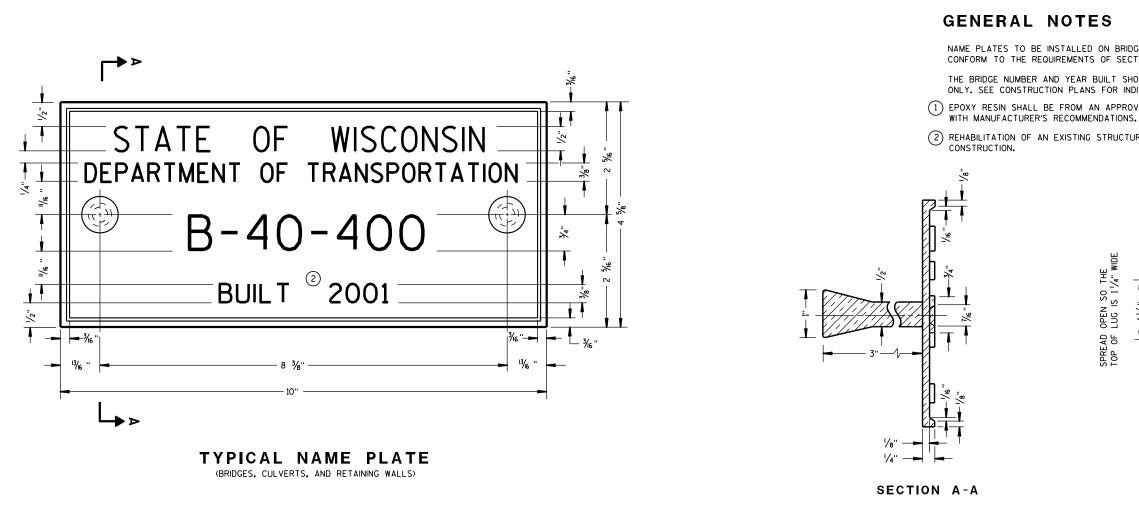
#### CONDUIT


#### STATE OF WISCONSIN DEPARTMENT OF TRANSPORTATION

APPROVED March, 2017 DATE

/S/ Ahmet Demirbilek STATE ELECTRICAL ENGINEER

FHWA



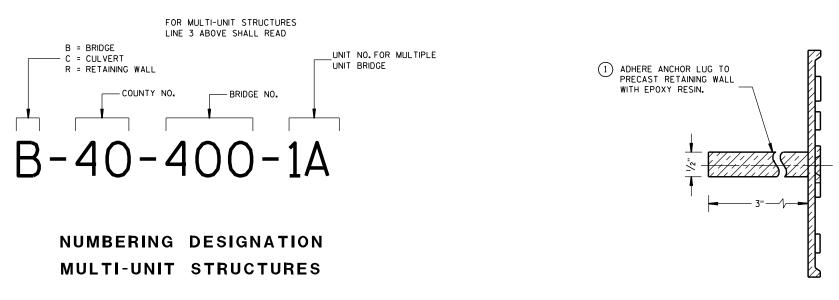


ALTERNATE LUG (FOR ATTACHMENT TO PRECAST STRUCTURES)

NAME PLATES TO BE INSTALLED ON BRIDGES, CULVERTS, AND RETAINING WALLS SHALL CONFORM TO THE REQUIREMENTS OF SECTION 502.3.11 OF THE STANDARD SPECIFICATIONS.

THE BRIDGE NUMBER AND YEAR BUILT SHOWN ON THIS DRAWING ARE EXAMPLES ONLY. SEE CONSTRUCTION PLANS FOR INDIVIDUAL NUMBERING AND YEAR BUILT. (1) EPOXY RESIN SHALL BE FROM AN APPROVED MANUFACTURER AND USED IN ACCORDANCE

(2) REHABILITATION OF AN EXISTING STRUCTURE SHOULD USE THE DATE OF ORIGINAL STRUCTURE

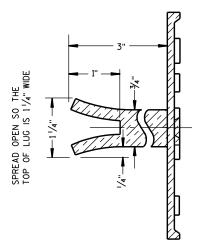

#### ALTERNATE LUG

### NAME PLATE (STRUCTURES)

STATE OF WISCONSIN DEPARTMENT OF TRANSPORTATION


#### APPROVED

3/26/10 DATE FHWA

/S/ Scot Becker CHIEF STRUCTURAL DEVELOPMENT ENGINEER 3-10 ∢ 2 Δ

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**SDD 13B02** 09

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## **CONCRETE PAVEMENT** 0 2 3 DEPARTMENT OF TRANSPORTATION ~ Δ

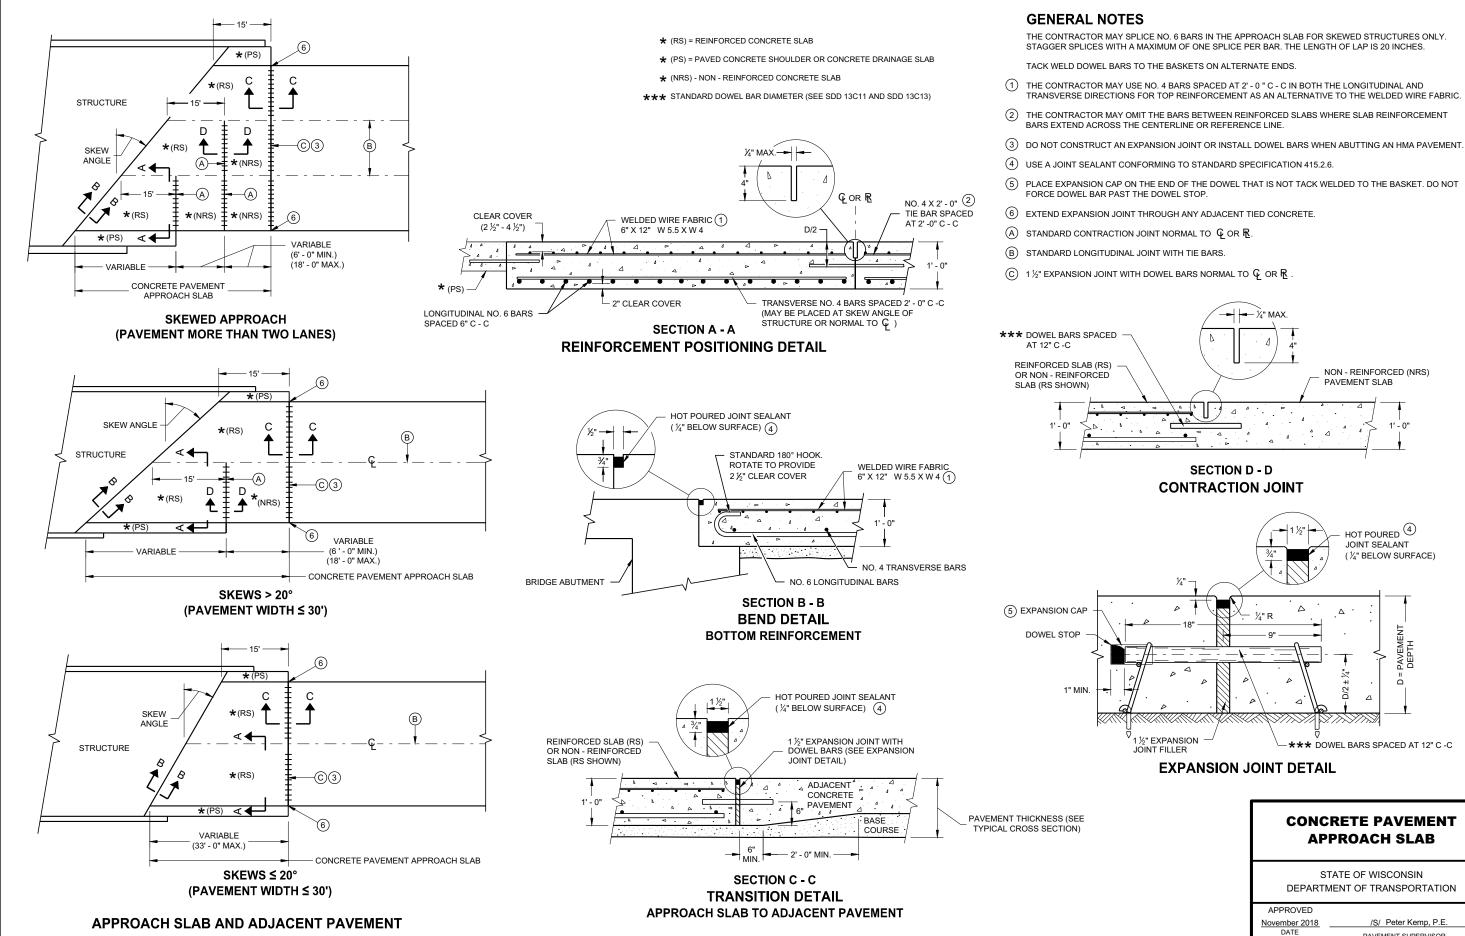PAVEMENT SUPERVISOR


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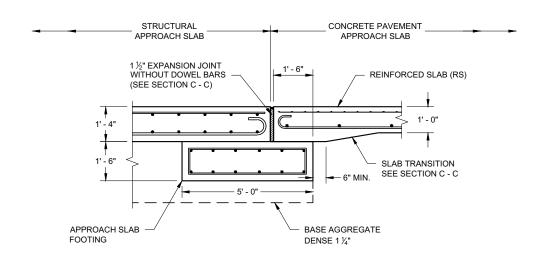
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#### (1) SEE BRIDGE PLAN.

- (2) CONFORM TO SDD 13B02 SHEET A FOR CONCRETE PAVEMENT APPROACH SLAB DETAILS  $(\mathfrak{Z})$  do not construct an expansion joint or install dowel bars when abutting an HMA pavement.
- (4) EXTEND EXPANSION JOINT THROUGH ANY ADJACENT TIED CONCRETE.
- $\bigcirc$  1 ½" EXPANSION JOINT WITH DOWEL BARS NORMAL TO  $\bigcirc$  OR  $\mathbb{R}$ .
- (D) 1 ½" EXPANSION JOINT (NO DOWELS)



### **BRIDGE APPROACHES**

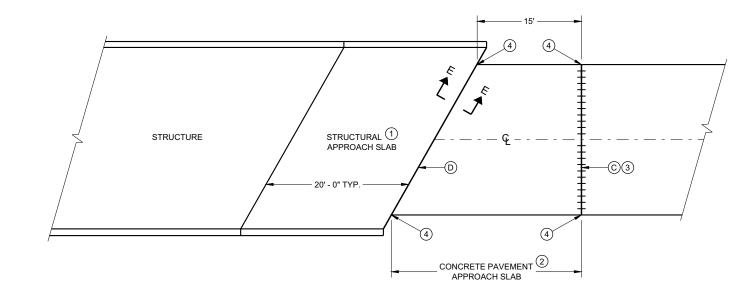

#### **SECTION E - E FOOTING DETAIL** STRUCTURAL APPROACH SLAB TO CONCRETE BRIDGE APPROACH

ALL PROJECTS THAT INVOLVE A STRUCTURAL APPROACH SLAB WILL ALSO HAVE A CONCRETE PAVEMENT APPROACH SLAB.

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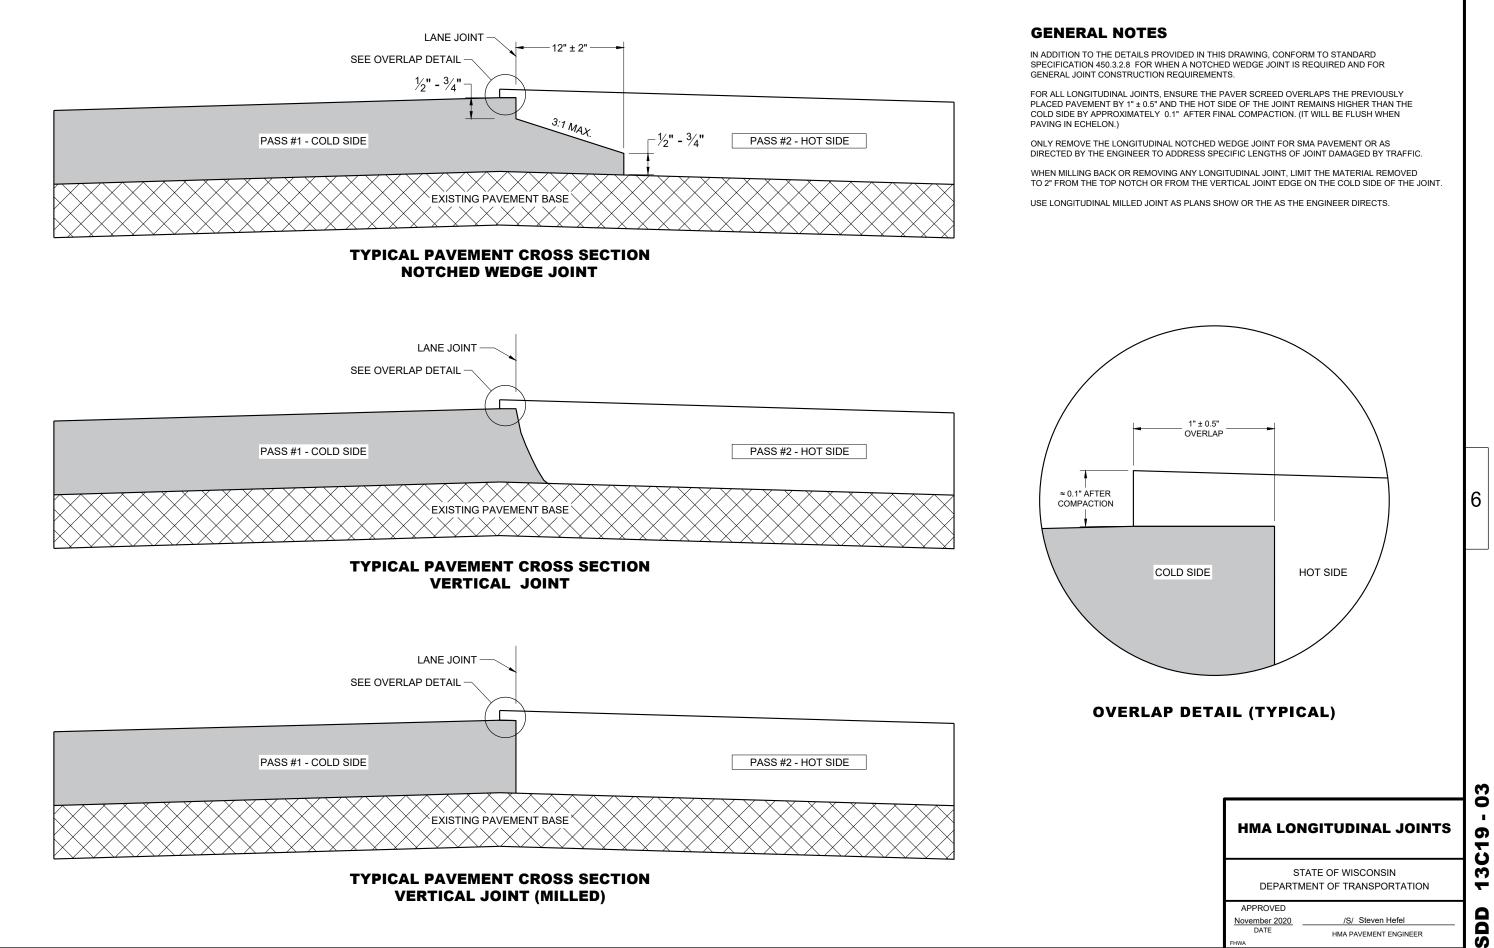
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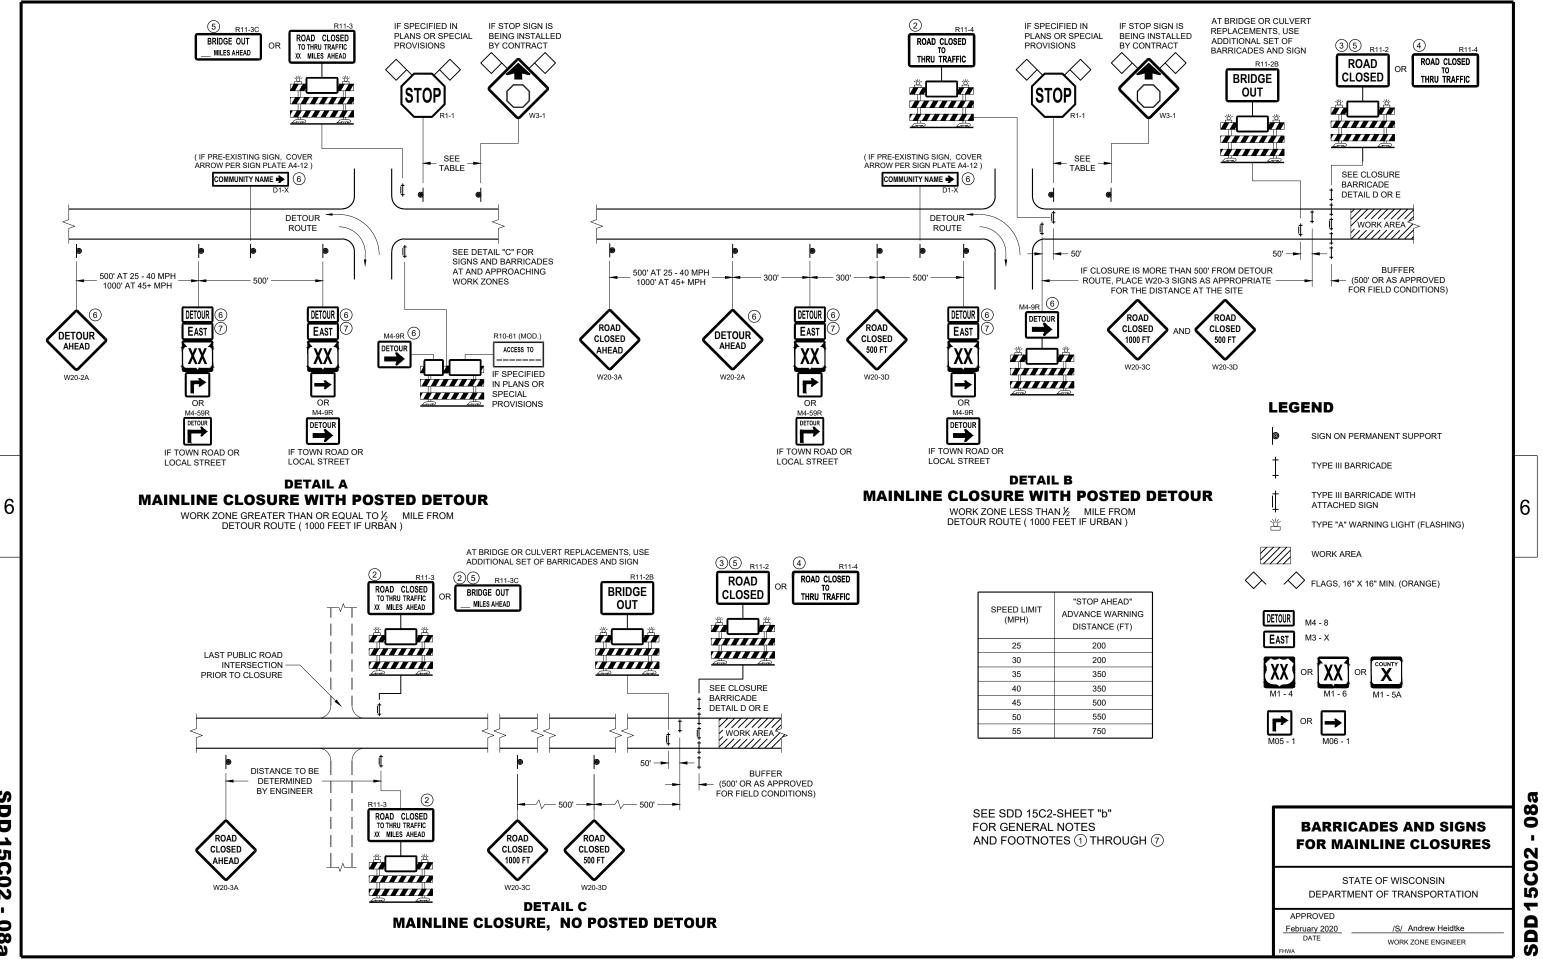
### STRUCTURAL APPROACH SLAB AND CONCRETE PAVEMENT **APPROACH SLAB**


STATE OF WISCONSIN DEPARTMENT OF TRANSPORTATION

APPROVED November 2018 DATE

/S/ Peter Kemp P.E. PAVEMENT SUPERVISOR





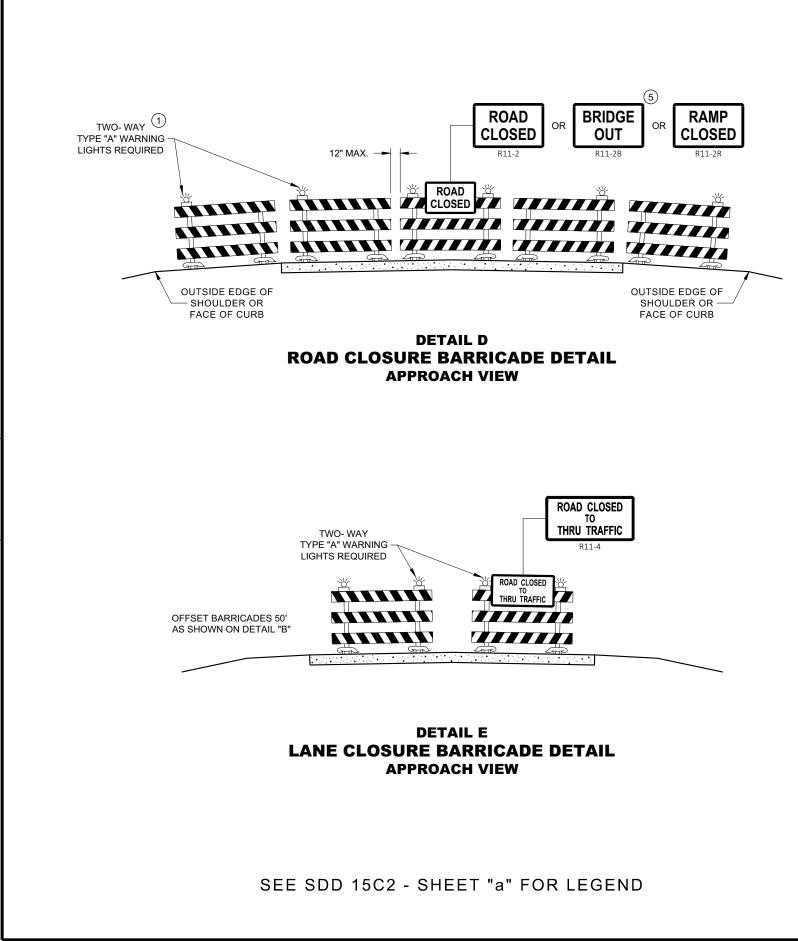

FIELD CONDITIONS AS APPROVED BY THE ENGINEER.

OR COVERED AS NEEDED AND AS APPROVED BY THE ENGINEER.

SUPPORTS.

FULL ROAD CLOSURES.


THAN THE TOP RAIL. THE SIGNS SHALL NOT COVER ANY PORTION OF THE MIDDLE RAIL OR BOTTOM RAILS.

"WO" AND "MO" SIGNS ARE THE SAME AS "W" AND "M" SIGNS EXCEPT THE BACKGROUND IS ORANGE.


- ALL SIGNS SHALL BE 48" X 48" UNLESS OTHERWISE NOTED BELOW: R11 - 2 SHALL BE 48" X 30"
  - R11 3 SHALL, R11 4 AND R10 61 SHALL BE 60 " X 30" M4 - 9 SHALL BE 30" X 24"
  - M3 X SHALL BE 24" X 12" (36" X 18" IF NEEDED TO MATCH EXISTING SIGNS)
  - M4 8 SHALL BE 24" X 12" (36" X 18" IF NEEDED TO MATCH EXISTING SIGNS)

  - D1 X SHALL BE AS SHOWN ON SPECIFIC PROJECT SIGNING DETAIL SHEETS.
  - R1 1 SHALL BE 36" X 36"
- (1)TWO WARNING LIGHTS SHALL BE PROVIDED ON THE CENTER BARRICADE AND A MINIMUM OF ONE WARNING THE WARNING LIGHTS SHALL BE UNIFORM TO THE EDGE OF ROADWAY AS SHOWN (APPROX. 8 FOOT LIGHT SPACING
- (2) THESE SIGNS AND BARRICADES ARE NOT REQUIRED IF ROAD CLOSURE BEGINS AT AN INTERSECTION.
- (3) FOR ROAD CLOSURE WITHOUT LOCAL ACCESS TO PROJECT, SEE ROAD CLOSURE BARRICADE DETAIL "D".
- (4) FOR ROAD CLOSURE WITH LOCAL ACCESS TO PROJECT, SEE ROAD CLOSURE BARRICADE DETAIL "E".
- (5) FOR BRIDGE OR CULVERT REPLACEMENTS, SUBSTITUTE "BRIDGE OUT" INSTEAD OF "ROAD CLOSED" ON R11 - 2 AND R11 - 3 SIGNS.
- (6) INSTALL DETOUR AND COMMUNITY GUIDE SIGNS AND ARROWS ONLY IF SPECIFIED IN THE CONTRACT. IF THERE SIGNS AS SHOWN.
- (7)"EAST" CARDINAL DIRECTION MARKERS AND RIGHT TURN ARROWS ARE SHOWN. USE OTHER CARDINAL DIRECTIONS AND ARROWS AS APPROPRIATE.

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**SDD 15C02** 0 80

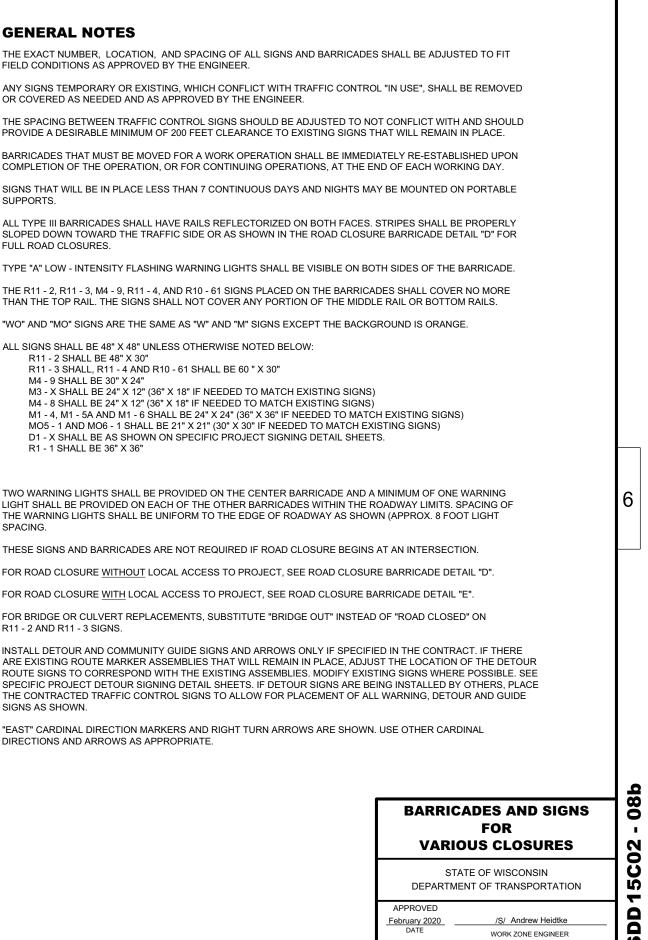
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February 2020 DATE

WORK ZONE ENGINEER
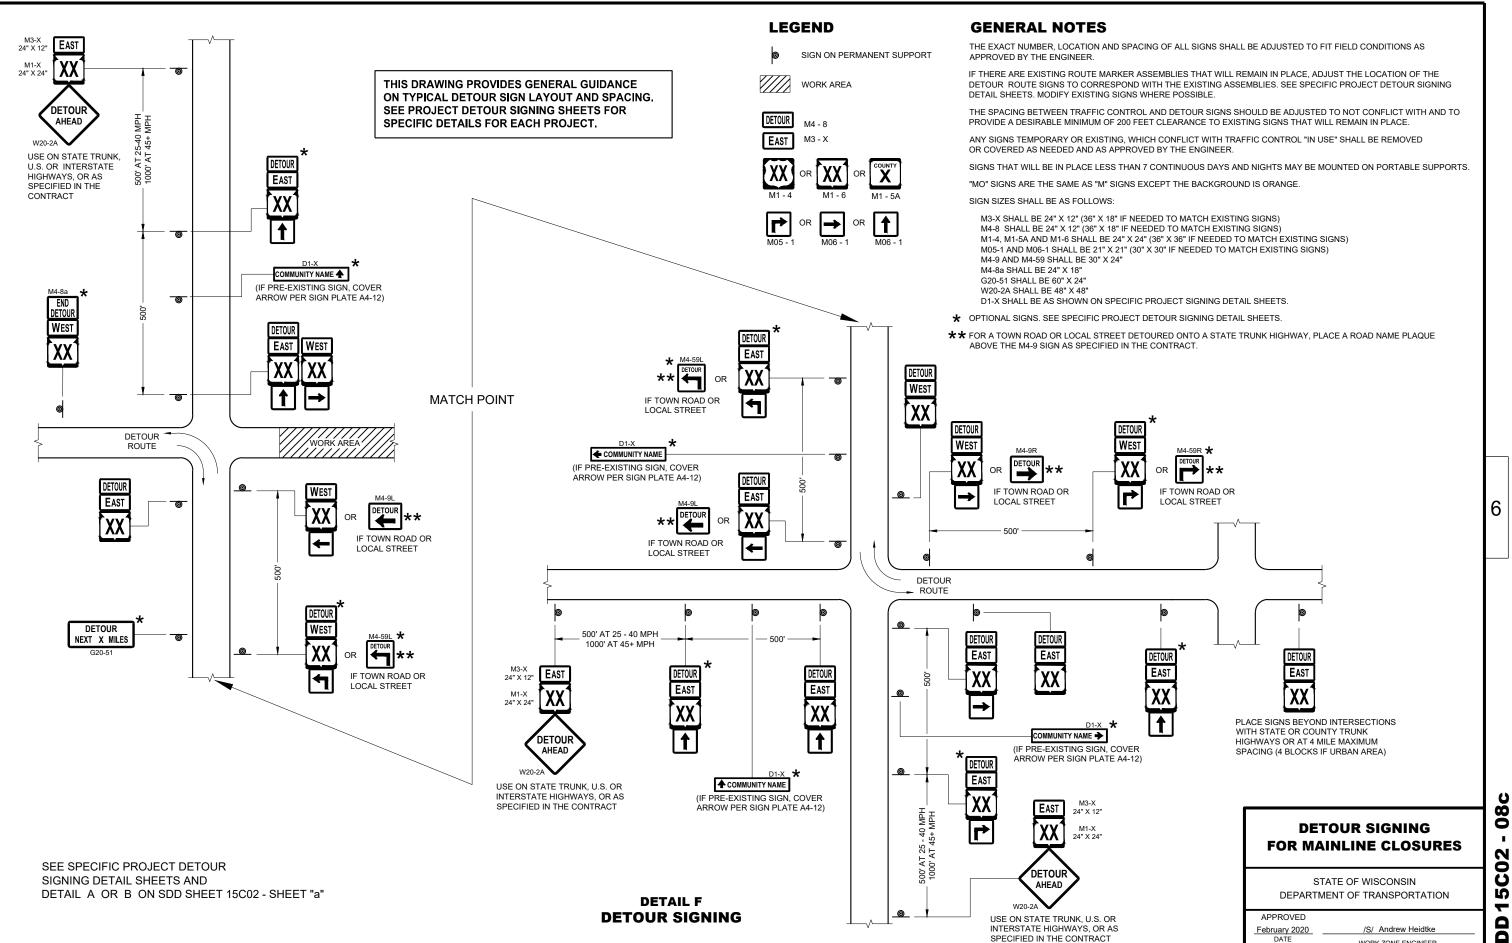
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AS APPROVED BY THE ENGINEER.

NEEDED AND AS APPROVED BY THE ENGINEER.

SIGN REMOVAL, OR A FLAGGER SHALL BE PROVIDED UNTIL THE SIGN IS REESTABLISHED.

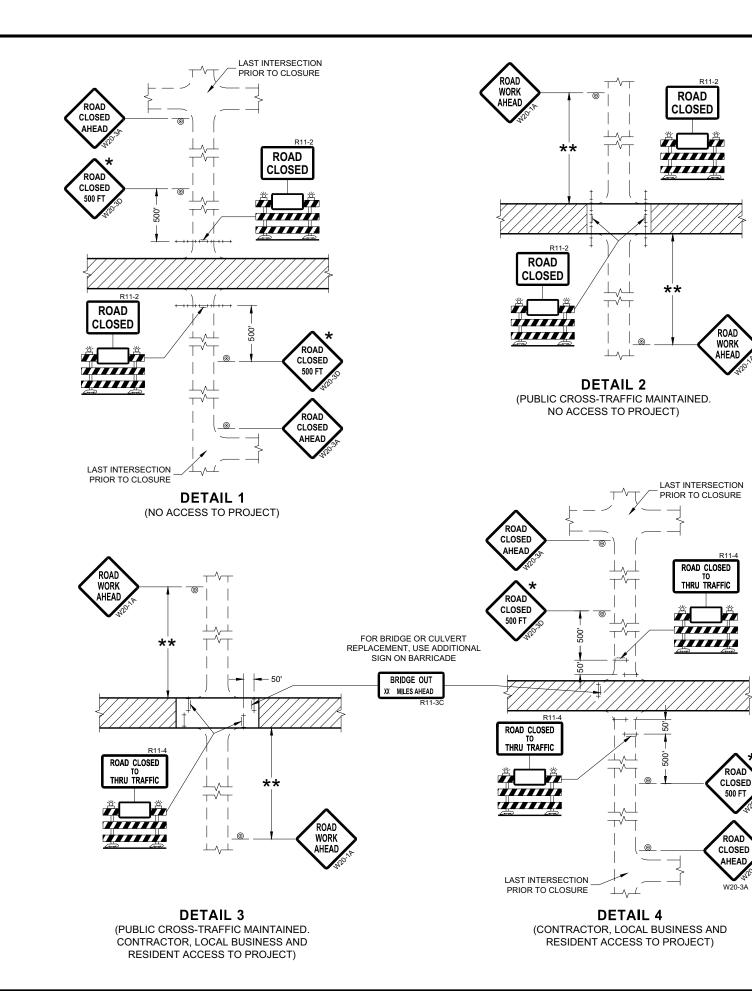THE OPERATION OR FOR CONTINUING OPERATIONS, AT THE END OF EACH WORKING DAY.


NOT COVER ANY PORTION OF THE MIDDLE OR BOTTOM RAILS.

ALL SIGNS SHALL BE 48" X 48" UNLESS OTHERWISE NOTED BELOW: R11-2 SHALL BE 48" X 30". R11-4 AND R11-3 SHALL BE 60" X 30".

★★ 500' MAX. OR AT LAST INTERSECTION, WHICHEVER IS CLOSEST.

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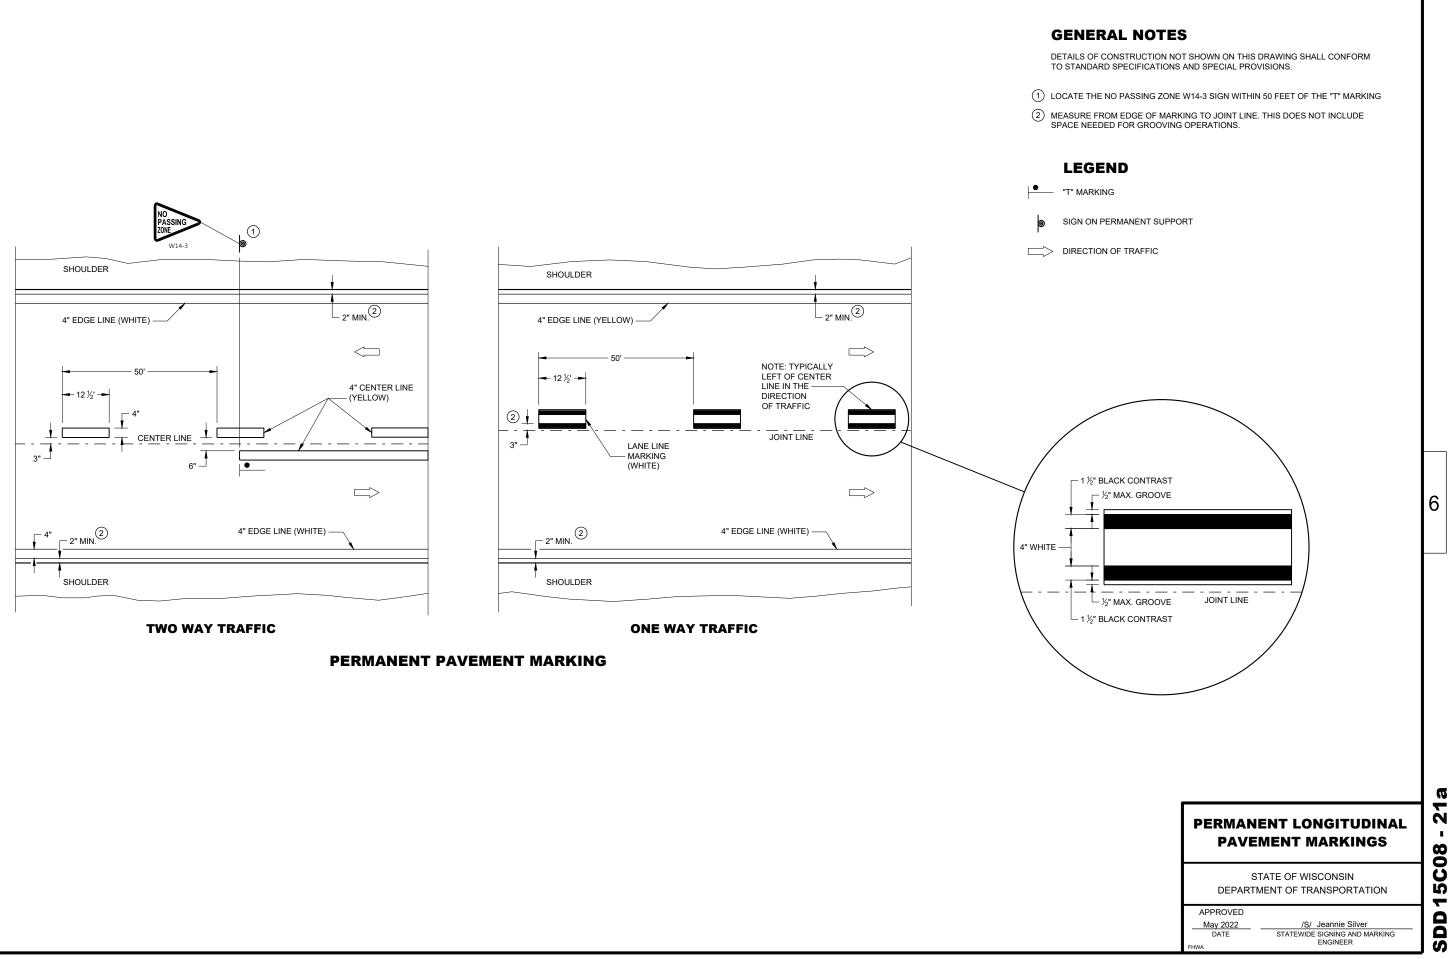


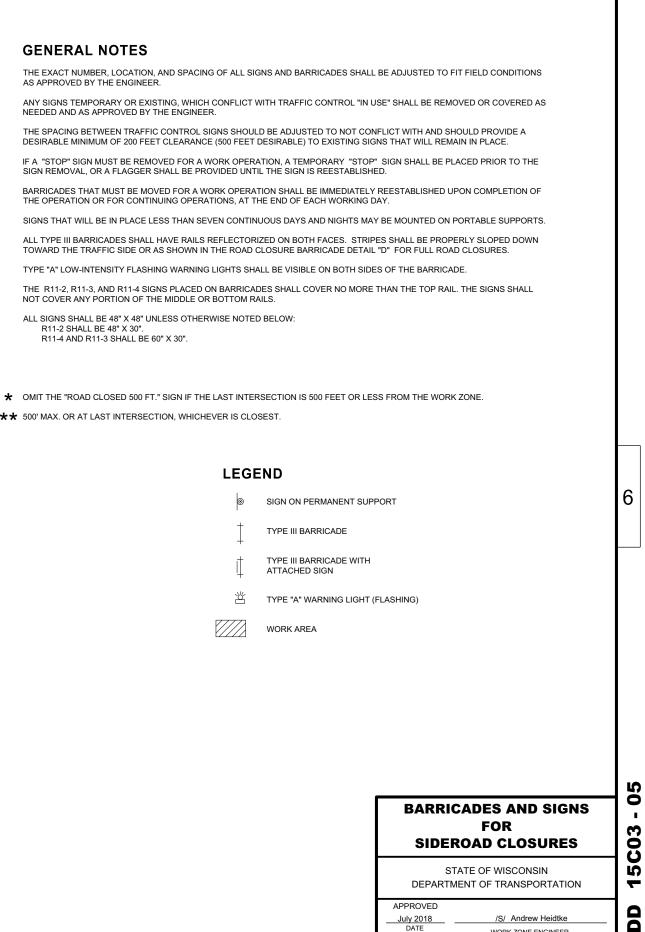

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WORK ZONE ENGINEER


July 2018 DATE









- (2) LOCATION OF WARNING LIGHTS WHEN SHOWN ON THE PLAN.

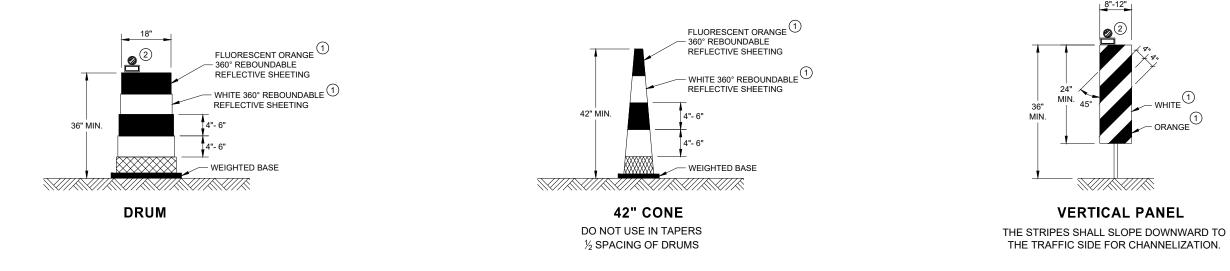

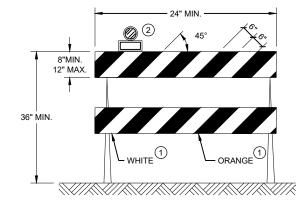

**TYPE II BARRICADE** 

FOR RAILS LESS THAN 36" LONG, 4" WIDE STRIPES MAY BE USED. ALL STRIPES SHALL SLOPE DOWNWARD TO THE TRAFFIC SIDE FOR CHANNELIZATION.

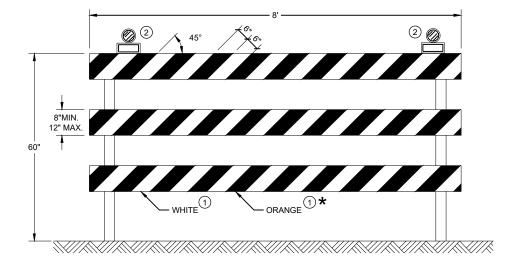

#### **TYPE III BARRICADE**

IF SIGN MOUNTED, DO NOT COVER MORE THAN 50% OF THE TOP TWO RAILS OR 33% OF THE TOTAL AREA OF THE THREE RAILS.

★ IF USED FOR A PERMANENT APPLICATION USE RED SHEETING.

(1) REFLECTIVE SHEETING SHALL FOLLOW THE REQUIREMENTS IN THE APPROVED PRODUCTS LISTING FOR SIGN SHEETING.


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### **CHANNELIZING DEVICES DRUMS, CONES, BARRICADES** AND VERTICAL PANELS


STATE OF WISCONSIN DEPARTMENT OF TRANSPORTATION

APPROVED May 2021 DATE

/S/ Andrew Heidtke WORK ZONE ENGINEER

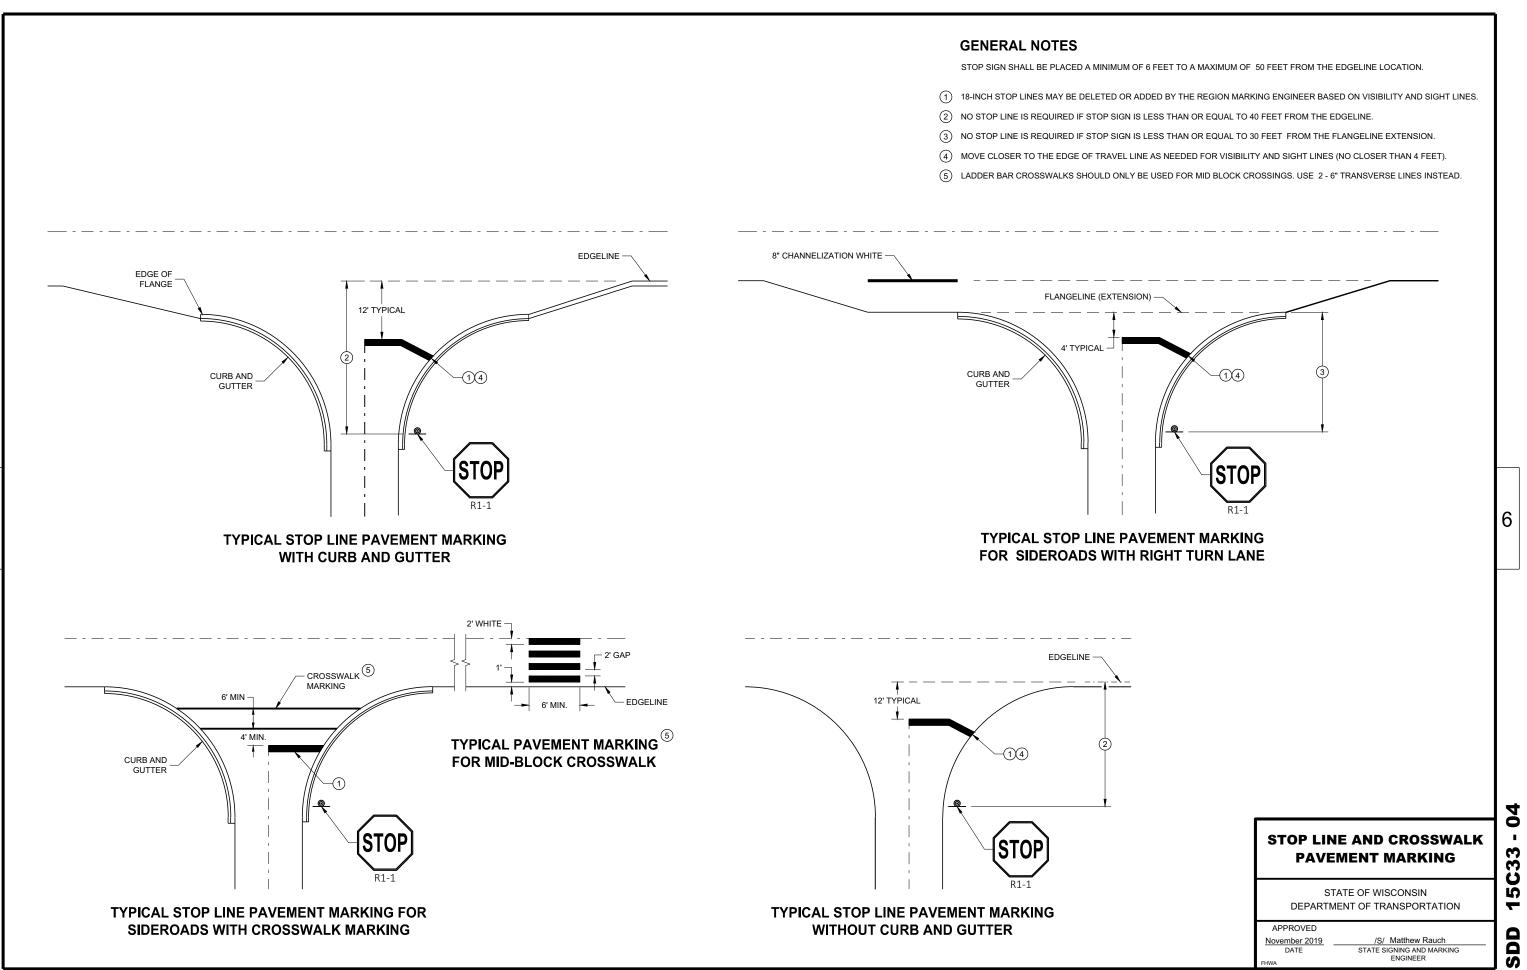

SDD 15C33 - 04

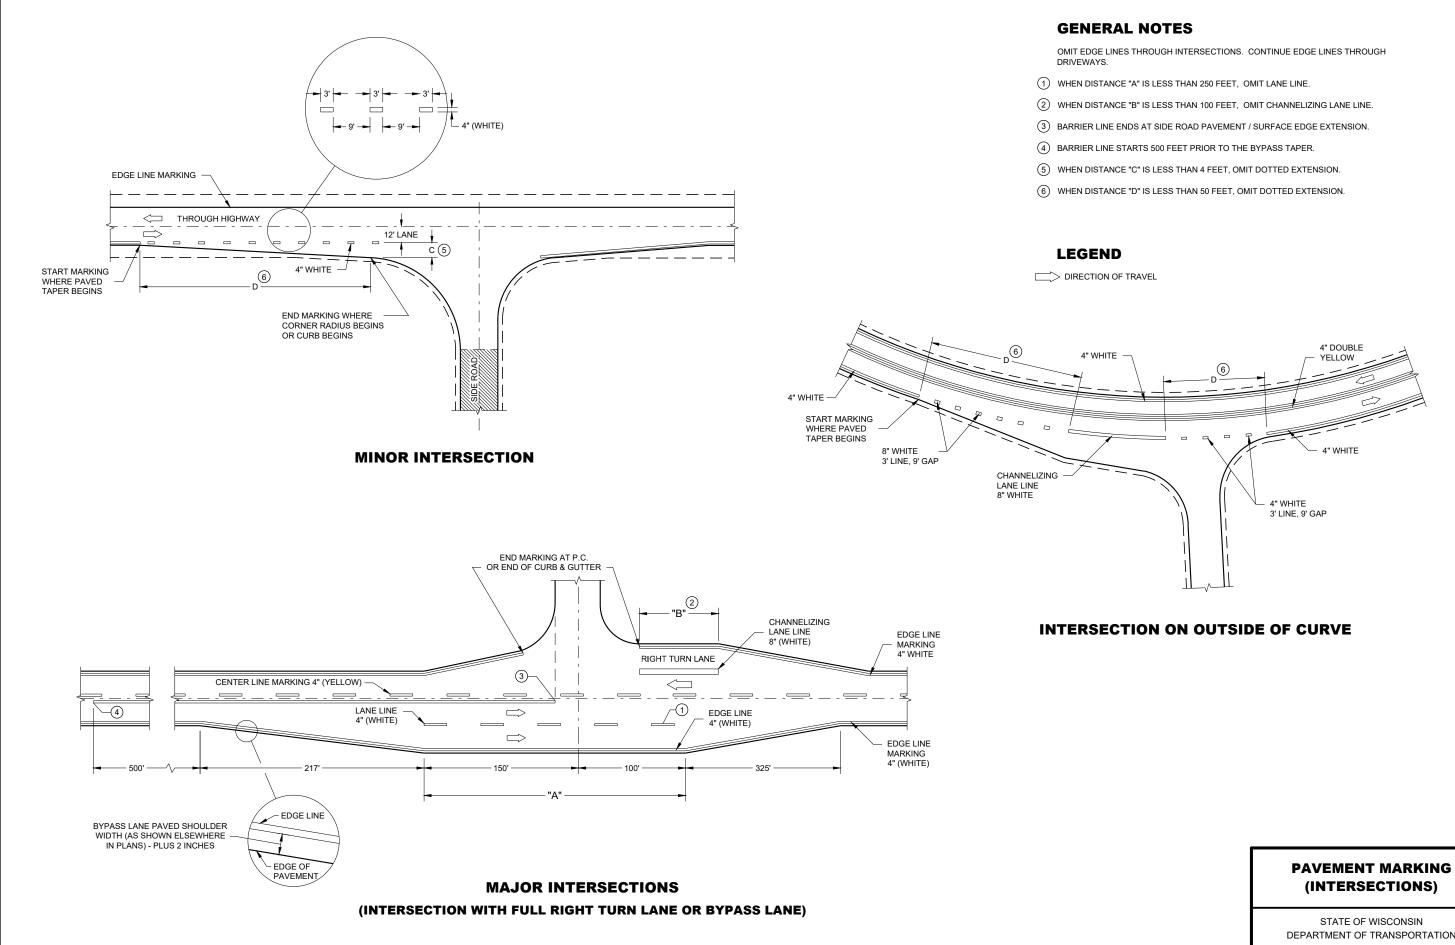


# 6 02 . ŋ **SDD15C3**

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# (INTERSECTIONS)

STATE OF WISCONSIN DEPARTMENT OF TRANSPORTATION

- 2. Color:
  - Background Green
  - Message White
- 3. Message Series E

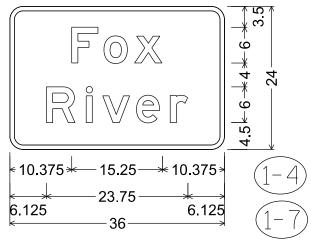

I3-1; 2.250" Radius, 0.750" Border

PROJECT NO: 3834-00-72	HWY: JEFFERSON STREET	COUNTY: RACINE	PERMANENT SIGNING	
FILE NAME : C:\CAEfiles\Projects\tr_d2_2514a722.DGN		PLOT DATE : 26-JUL 2022 10	:10 PLOT BY : mscj9h	PLOT NAME :

7


## NOTES

1. Sign is Type II- Type H Reflective

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SHEET NO:


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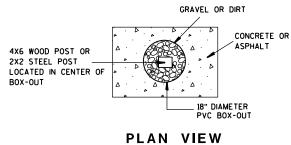


PROJECT NO:	HWY:	COUNTY:			
			DI AT DITE : 47 HUN 0000 4 0	DI OT DY IN IO	DLOT NAME -

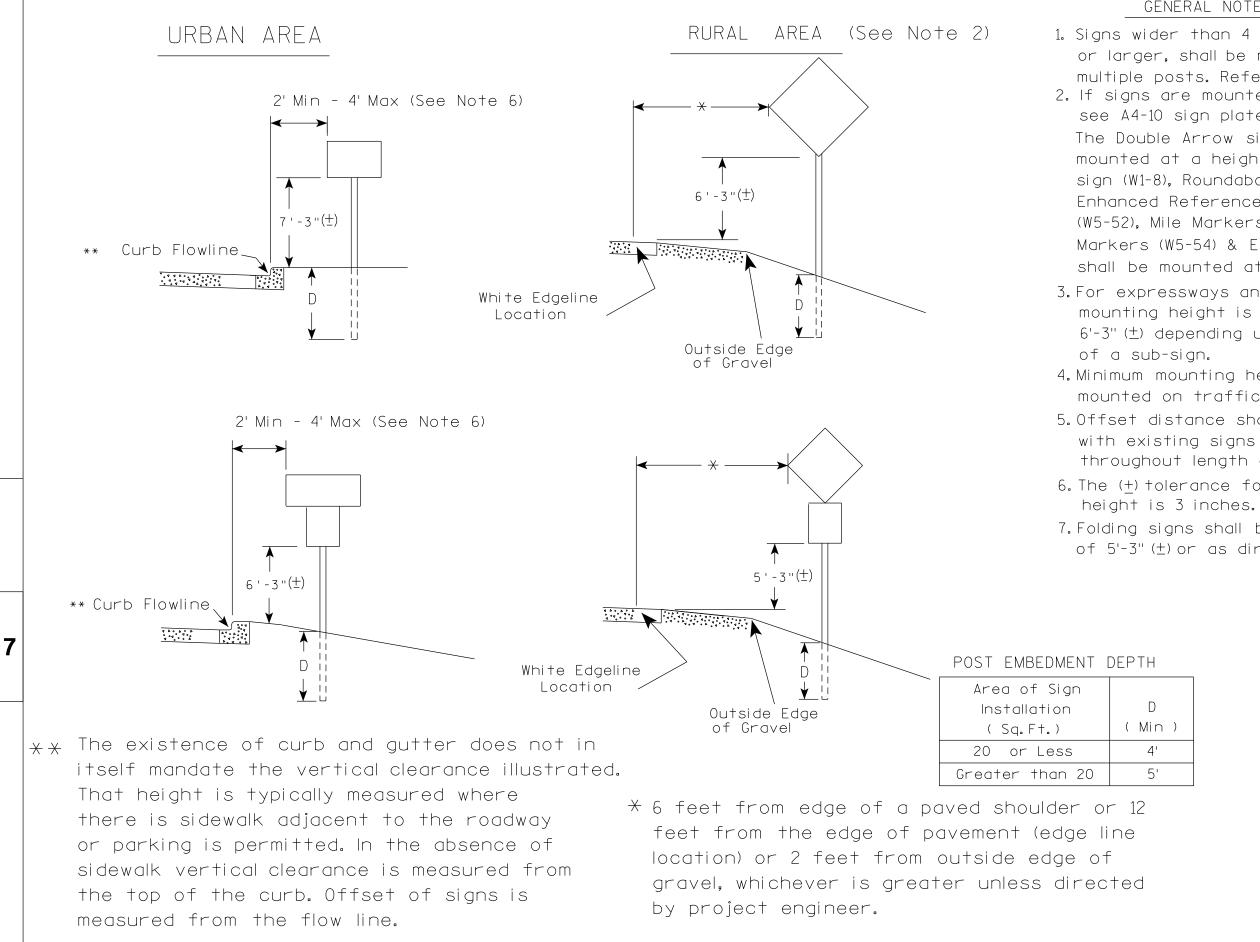1. Signs wider than 4 feet or 20 sq.ft or larger, shall be mounted on multiple posts. Refer to plate A4-4. 2. If signs are mounted on or behind barrier wall. see A4-10 sian plate. The Double Arrow sign (W12-1D) shall be mounted at a height of  $2'-3''(\pm)$ . The Chevron sign (W1-8), Roundabout Chevron panel (R6-4B), Enhanced Reference Markers, Clearance Markers (W5-52). Mile Markers (D10 series). In Road Object Markers (W5-54) & End of Road Markers (W5-56) shall be mounted at a height of 4'-3'' (+). 3. For expressways and freeways, mounting height is 7'- 3" ( $\pm$ ) or  $6'-3''(\pm)$  depending upon existence 4. Minimum mounting height for signs mounted on traffic signal poles is 5' - 3'' (+). 5. Offset distance shall be consistent with existing signs or consistent throughout length of project. 6. The (+) tolerance for mounting 7. Folding signs shall be mounted at a height of 5'-3"  $(\pm)$  or as directd by the Engineer.

)	
	TYPICAL INSTALLATION
	OF PERMANENT TYPE II
	SIGNS ON SINGLE POSTS
	WISCONSIN DEPT OF TRANSPORTATION
	APPROVED Matthew & Rauch For state Traffic Engineer
	DATE <u>5/13/202</u> 0 PLATE NO. <u>44-3.22</u>
	SHEET NO: E
PLOT SCALE : \$\$	WISDOT/CADDS SHEET 42



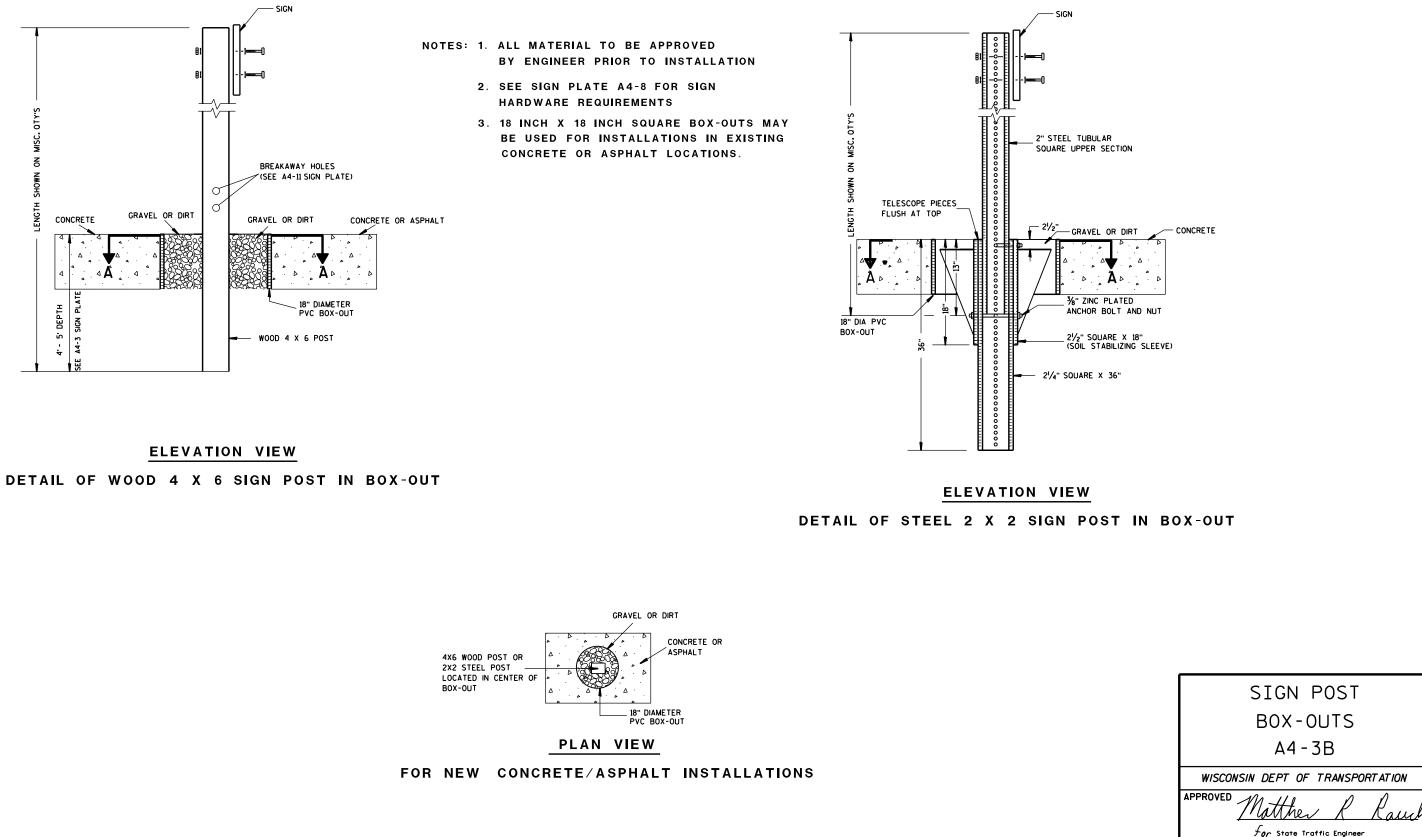


PROJECT NO:	HWY:	COUNTY:				
FILE NAME : C:\CAEFiles\Projects\tr_stdplate\A43B.DGN			PLOT DATE : 27-JAN-2014 09:4	8	PLOT BY : mscsja	PLOT NAME :

DATE <u>1/27/14</u>

SHEET NO:

PLATE NO. <u>A4-3B.1</u>

Ε

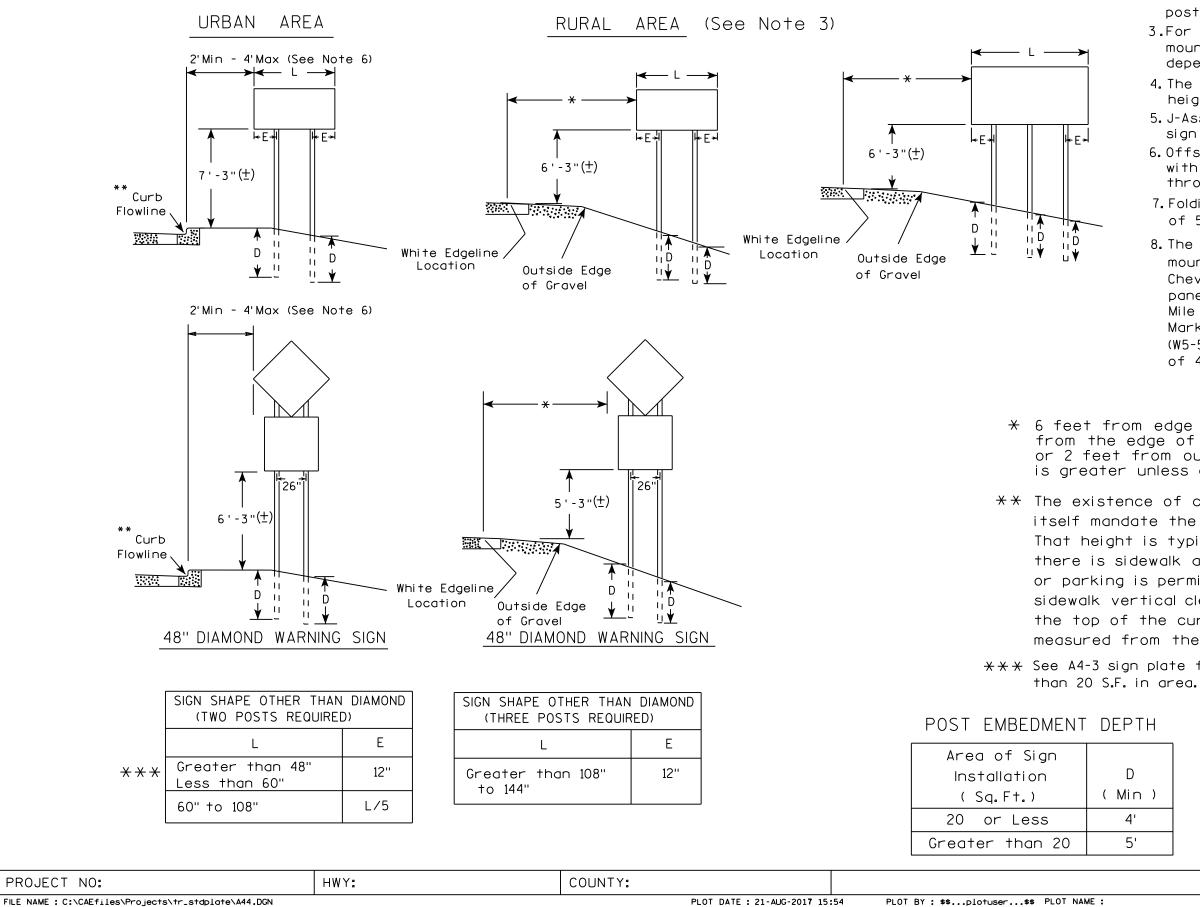

FILE NAME : C:\CAEfiles\Projects\tr_stdplate\A44.DGN

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GENERAL NOTES

- 1. For 3 or 4 post installations, individual post spacing shall be greater than 3'-6".
- 2. See tables below for required number of posts.
- 3.For expressways and freeways, mounting height is  $7'-3''(\pm)$  or  $6'-3''(\pm)$ depending upon existence of sub-sign.
- 4. The (±) tolerance for mounting height is 3 inches.
- 5. J-Assemblies are considered to be one sign for mounting height.
- 6. Offset distance shall be consistent with existing signs or consistent throughout length of project.
- 7. Folding signs shall be mounted at a height of 5'-3"  $(\pm)$  or as directed by the engineer.
- 8. The Double Arrow sign (W12-1) shall be mounted at a height of 2'-3'' (±). The Chevron sign (W1-8), Roundabout Chevron panel (R6-4B), Clearance Markers (W5-52), Mile Markers (D10 series), In Road Object Markers (W5-54) & End of Road Markers (W5-56) shall be mounted at a height of 4"-3" (±).

* 6 feet from edge of a paved shoulder or 12 feet from the edge of pavement (edge line location) or 2 feet from outside edge of gravel, whichever is greater unless directed by project engineer.


** The existence of curb and gutter does not in itself mandate the vertical clearance illustrated. That height is typically measured where there is sidewalk adjacent to the roadway or parking is permitted. In the absence of sidewalk vertical clearance is measured from the top of the curb. Offset of signs is measured from the flow line.

 $\times$   $\times$  See A4-3 sign plate for signs 4' or less in width and less

H	TYPICAL INSTALLATION OF TYPE II SIGNS ON MULTIPLE POSTS			
)	WISCONSIN DEPT OF TRANSPORTATION			
,	APPROVED Matther & Rauch			
	For State Traffic Engineer			
	DATE 8/21/17 PLATE NO. 44-4.15			
SHEET NO: E				

PLOT SCALE : 108.188297:1.000000

WISDOT/CADDS SHEET 42

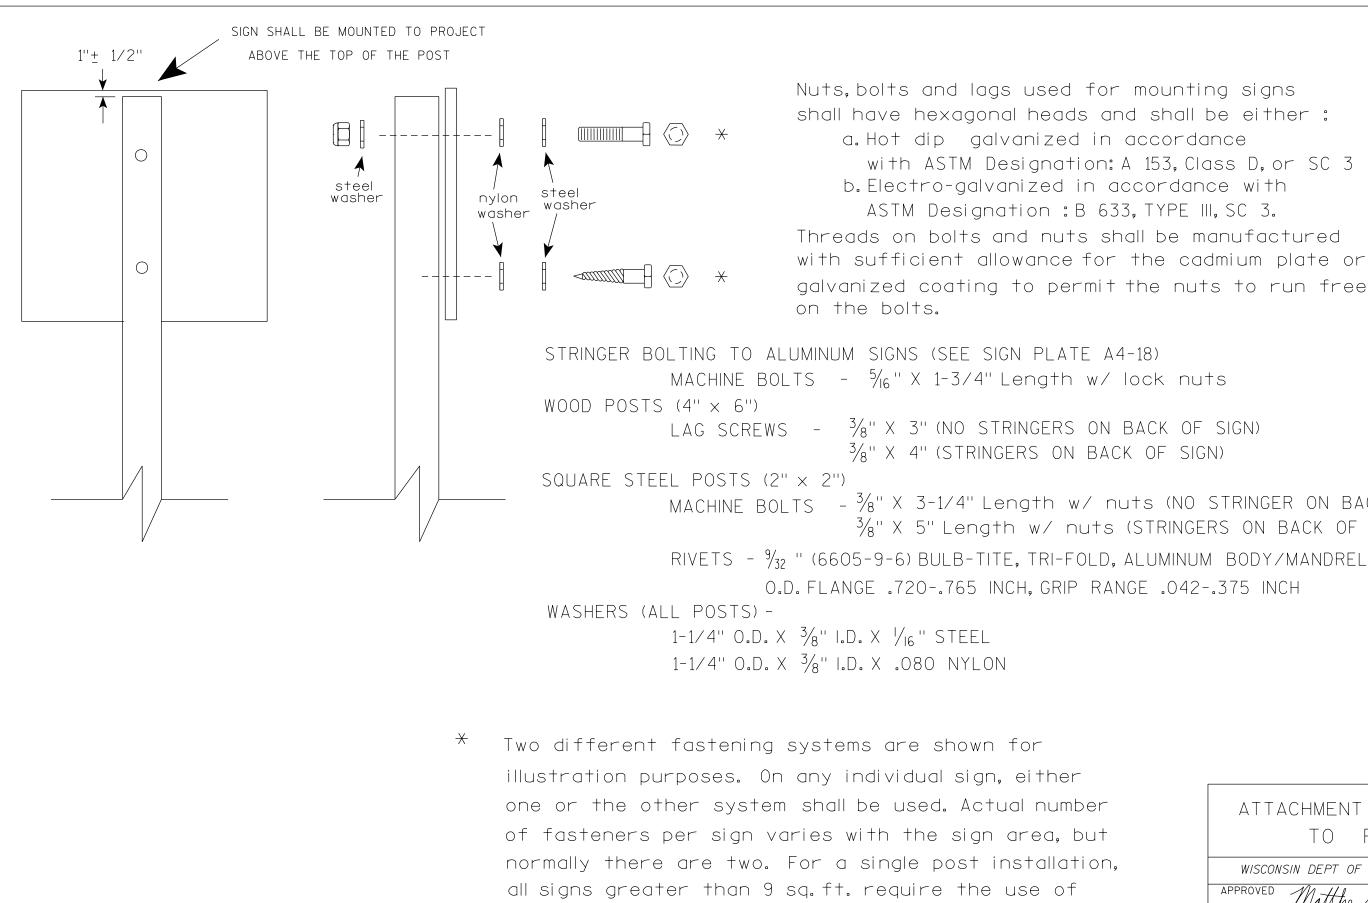


3 fasteners.


Nuts, bolts and lags used for mounting signs shall have hexagonal heads and shall be either : a. Hot dip galvanized in accordance with ASTM Designation: A 153. Class D. or SC 3 b. Electro-galvanized in accordance with ASTM Designation : B 633, TYPE III, SC 3. Threads on bolts and nuts shall be manufactured with sufficient allowance for the cadmium plate or galvanized coating to permit the nuts to run freely

 $\frac{3}{8}$ " X 4" (STRINGERS ON BACK OF SIGN)

MACHINE BOLTS - ³/₈" X 3-1/4" Length w/ nuts (NO STRINGER ON BACK OF SIGN) 3/8" X 5" Length w/ nuts (STRINGERS ON BACK OF SIGN)

ATTACHMENT OF SIGNS TO POSTS
WISCONSIN DEPT OF TRANSPORTATION
APPROVED Matthew R Rauch
∽°r State Traffic Engineer
DATE <u>4/1/202</u> 0 PLATE NO. <u>A4-8.9</u>
SHEET NO: E

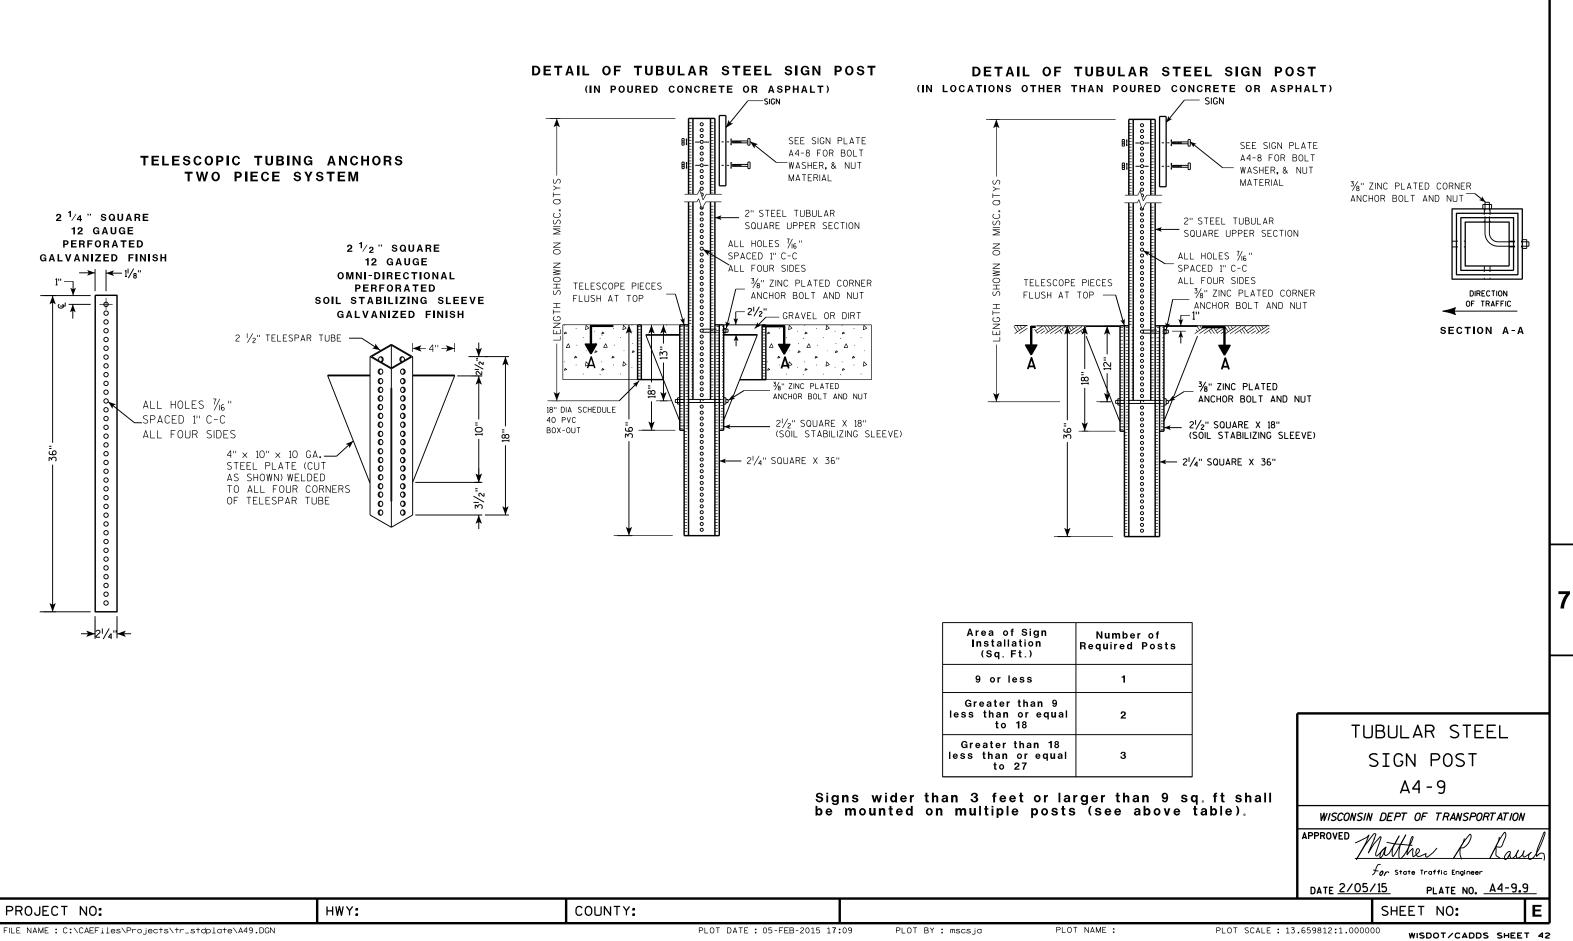

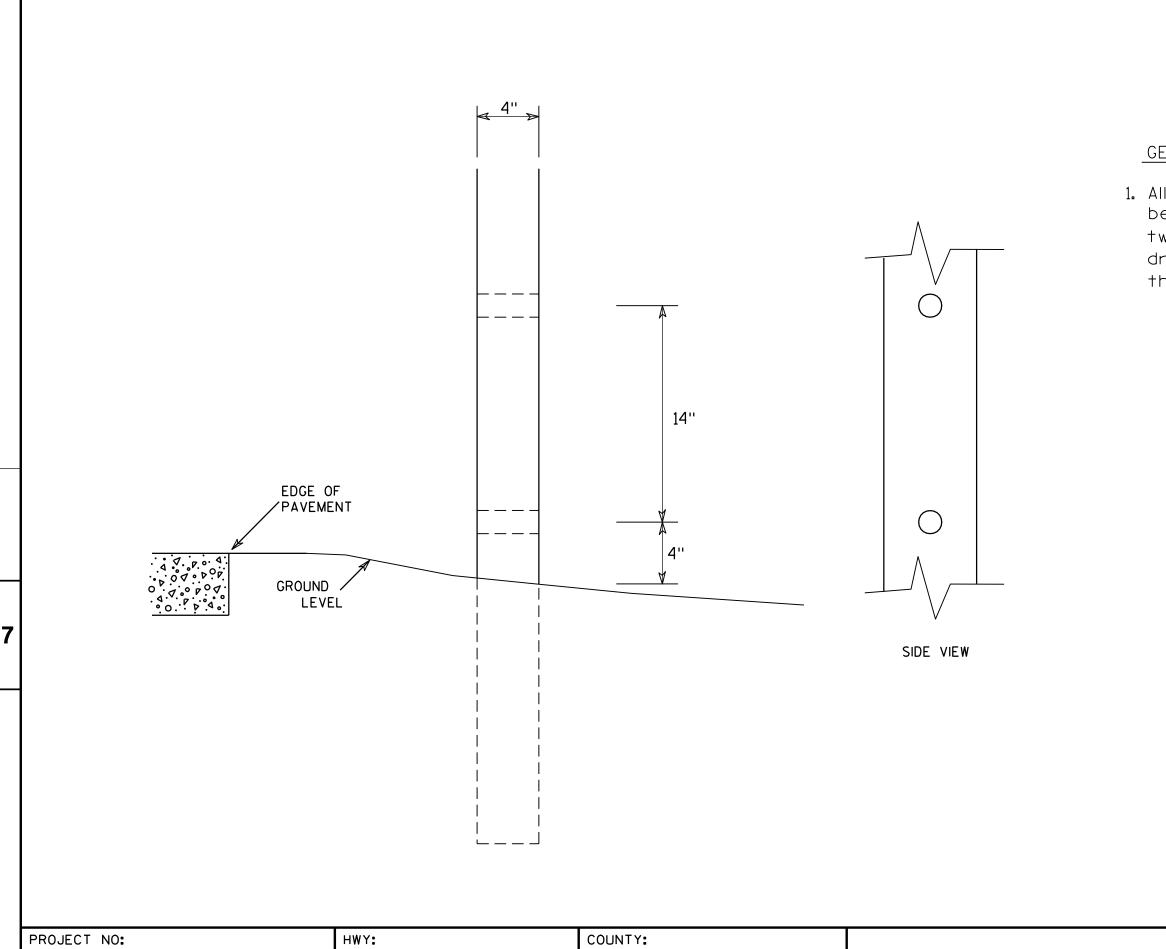


FILE NAME : C:\Users\Projects\tr_stdplate\A411.DGN

## GENERAL NOTES

1. All 4 x 6 Wood Posts shall be modified by having two  $1\frac{1}{2}$ " diameter holes drilled perpendicular to the roadway centerline.

	4	Х	ô	WOO	DF	POST	
		MOD	IF	FICA	TI	SNC	
	WISC	onsin l	DEF	PT OF T	RANSI	PORTATION	'
	APPROVE	D		hester .	Γέ	Spang	
			tor	State Tr	affic Er	ngineer	
	DATE 3	/27/9	<u>17</u>	PLA	TE NO	<u>A4-11.2</u>	2
			9	SHEET	N0:		Ε
OT SCALE	E:6.20 <b>7</b> 33	8:1.0000	000	WISD	от/с	ADDS SHEE	т 42

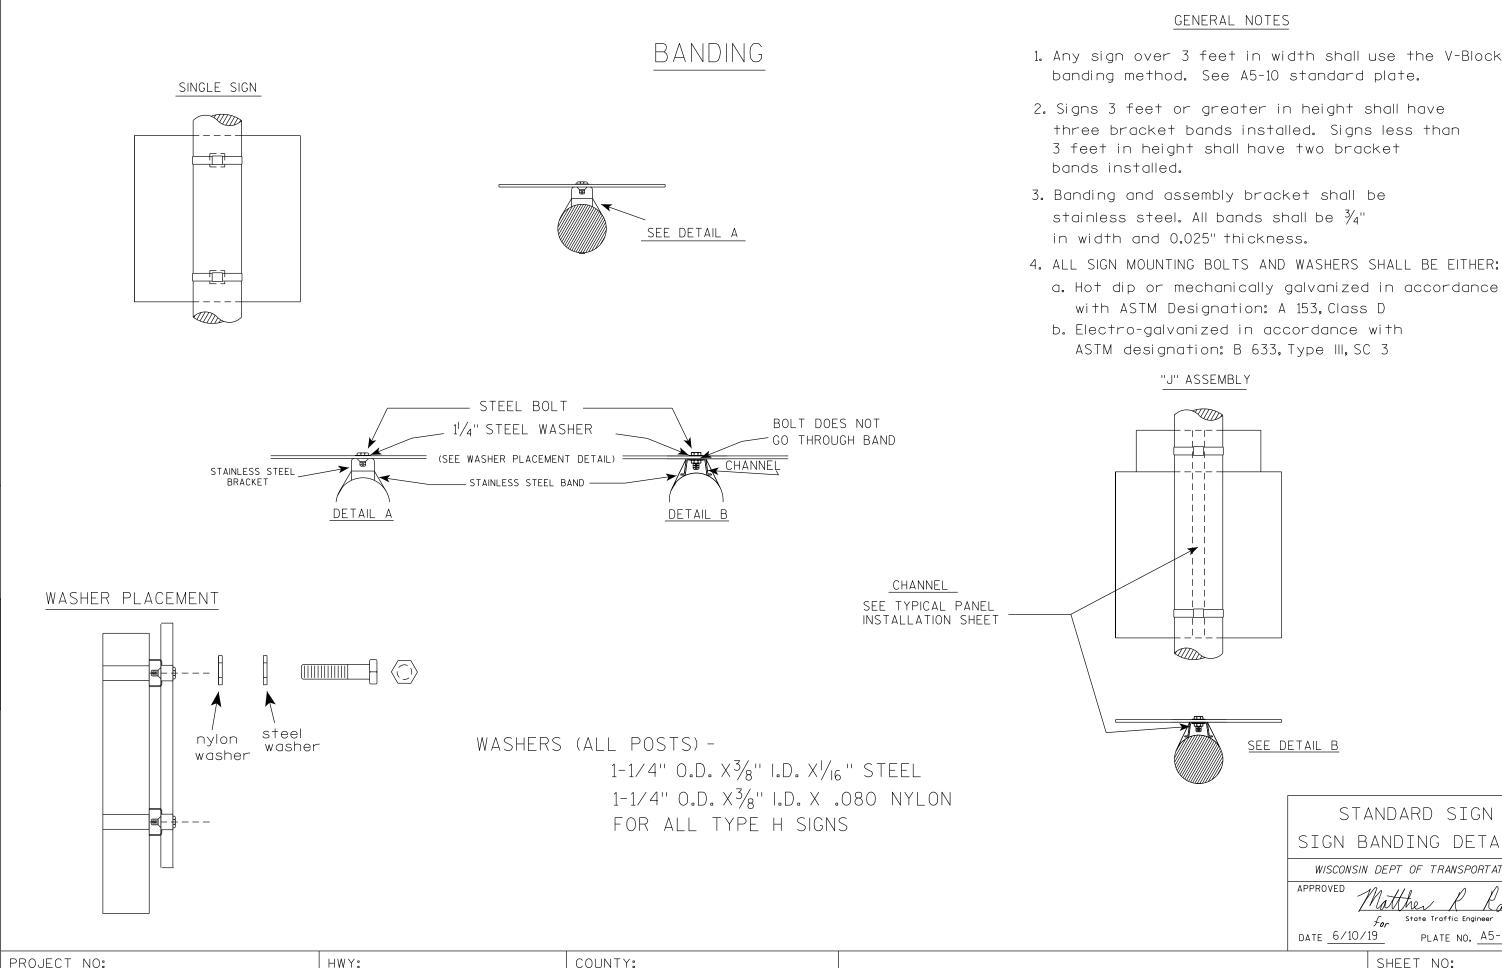

FILE NAME : C:\CAEfiles\Projects\tr_stdplate\A59.dgn

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PLOT DATE : 10-JUN 2019 4:10 PLOT BY : mscj9h PLOT NAME :


### GENERAL NOTES

1. Any sign over 3 feet in width shall use the V-Block banding method. See A5-10 standard plate.

three bracket bands installed. Signs less than 3 feet in height shall have two bracket

a. Hot dip or mechanically galvanized in accordance with ASTM Designation: A 153, Class D b. Electro-galvanized in accordance with ASTM designation: B 633, Type III, SC 3

	<u>SEE DETAIL B</u>
	STANDARD SIGN
	SIGN BANDING DETAILS
	WISCONSIN DEPT OF TRANSPORTATION
	APPROVED Matthe Rauch
	DATE 6/10/19 PLATE NO. 45-9.4
	SHEET NO: E
PLOT S	CALE : \$\$plotscale\$\$ WISDOT/CADDS SHEET 42

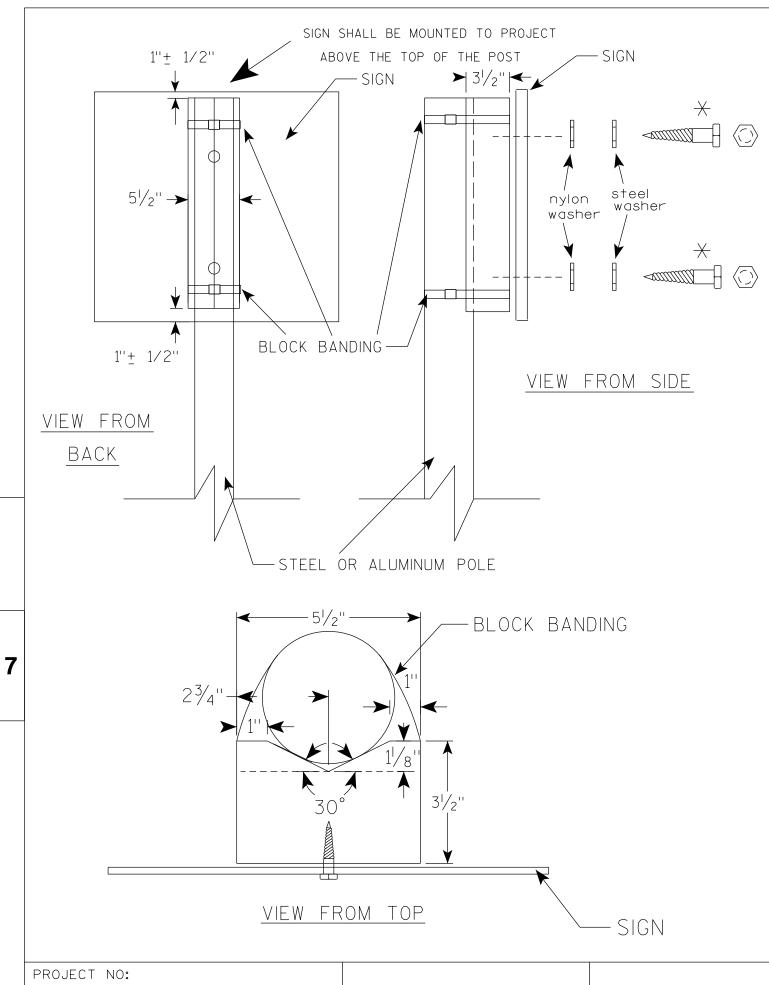

- WISDOT STANDARD SPECIFICATIONS
- AND 0.025" THICKNESS
- 9 S.F. 3 FASTENERS SHALL BE USED.
- with ASTM Designation: A 153, Class D
  - b. Electro-galvanized in accordance with ASTM Designation : B 633, TYPE III, SC 3
- 6. ALL BOLTS SHALL HAVE HEXAGONAL HEADS.
- 7. STEEL WASHERS SHALL BE  $1^{1}/_{4}$ " O.D. X  $\frac{3}{8}$ " I.D. X  $\frac{1}{16}$ "
- OR TYPE E EACE SIGN

 $\times$  LAG BOLTS SHALL BE  $\frac{3}{8}$ " X 2 $\frac{1}{2}$ "

FILE NAME : C:\CAEfiles\Projects\tr_stdplate\A510.dgr

1. WOOD 4"X6" POST MATERIAL SHALL CONFORM TO 507.2.2 OF THE


2. BLOCK BANDING AND CLIPS SHALL BE STAINLESS STEEL,  $\frac{3}{4}$ " WIDTH

3. SIGNS 3' OR GREATER IN HEIGHT SHALL UTILIZE 3 BLOCK BANDS. SIGNS UNDER 3' IN HEIGHT SHALL UTILIZE 2 BLOCK BANDS 4. ACTUAL NUMBER OF FASTENERS PER SIGN VARIES WITH THE SIGN AREA, BUT NORNALLY THERE ARE TWO. FOR SIGNS GREATER THAN 5. ALL SIGN MOUNTING BOLTS AND WASHERS SHALL BE EITHER: a. Hot dip or mechanically galvanized in accordance


8. NYLON WASHERS SHALL BE  $1^{1}/_{4}$ " O.D. X  $\frac{3}{8}$ " I.D. X .080 FOR TYPE H


BLOCK BANDING DETAIL ( V-BLOCK OPTION )		
WISCONSIN DEPT OF TRANSPORTATION		
APPROVED Matthew R Rauch		
<i>for</i> State Traffic Engineer		
DATE <u>4/19/2022</u> plate no. <u>45-10.3</u>		
SHEET NO:		
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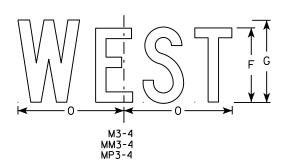
WISDOT/CADDS SHEET 42



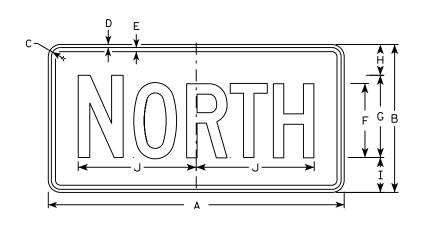



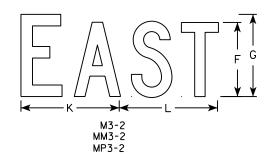

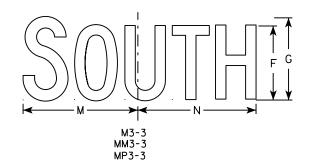

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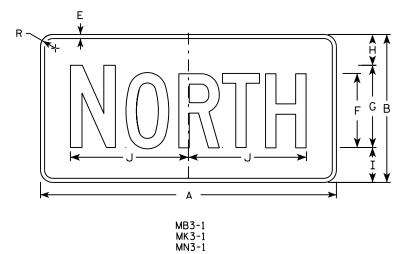
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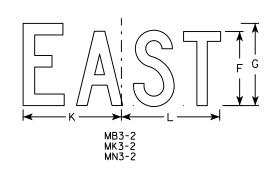
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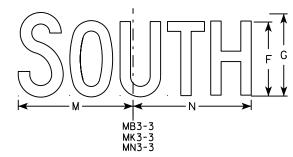
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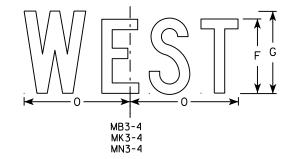
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- All Signs Type I
   Color:
  - Background -Message - Se
- 3. Message Series
- 4. Corners may be material is plyw as shown. When corners and bo
- 5. M3-1 thru M3-4

MB3-1 thru MB3.

- MK3-1 thru MK3-
- MM3-1 thru MM3-
- MN3-1 thru MN3-
- MP3-1 thru MP3
- 6. Note the first than the remai

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PROJECT NO:

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PLAT DATE . AL-DEC-2015 17.54 PLAT RY . \$\$ Diatuser \$\$ PLAT NAME :


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<u>TES</u> II - Type H
See note 5 See note 5 s - C e square or rounded when base wood but borders shall be rounded n base material is metal, the orders shall be rounded.
Background - White Message - Black -4 Background - Blue Message - White
-4 Background - Green
Message - White -4 Background - White
Message - Green -4 Background - Brown
Message - White -4 Background - White
Message – Blue t letter of each direction is larger inder of the message.

		STANDARD SIGNS
Z	Area sq. ft.	M3-1thur M3-4
		SERIES
	2.00	WISCONSIN DEPT OF TRANSPORTATION
	4.5	APPROVED Matthew P Fried
	4.5	for State Traffic Engineer
	4.5	DATE 10/15/15 PLATE NO. M3-1.14
		SHEET NO: E


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1. Sign is Type II - Type F Reflective - reference WIS DOT Standard Specification for HIGHWAY and STRUCTURE CONSTRUCTION latest edition.

4. Corners may be square or rounded when base material is plywood but borders shall be rounded as shown. When base material is metal, the corners and borders shall be rounded.

Z Areo sq. ft.	STANDARD SIGN					
∠ sq. tt.	M4 - 8					
2.0	WISCONSIN DEPT OF TRANSPORTATION					
4.5	APPROVED Matthew & Rauch					
	PLATE NO. M4-8.2					
	SHEET NO: E					
PLOT SCALE : 4.7	67233:1.000000 WISDOT/CADDS SHEET 4					

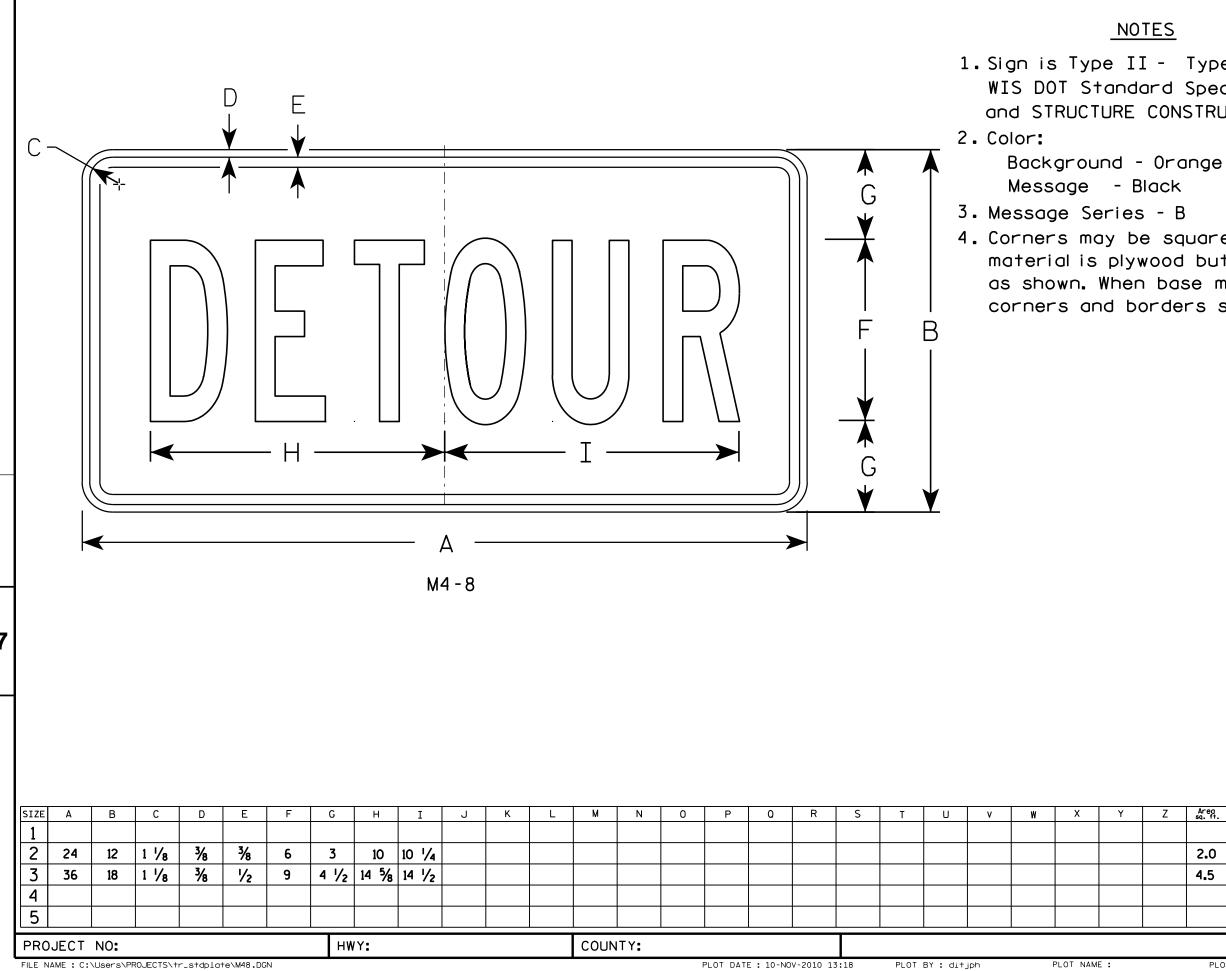


FILE NAME . C.\CAEfiles\Projects\tr_stdplate\M51 DGN

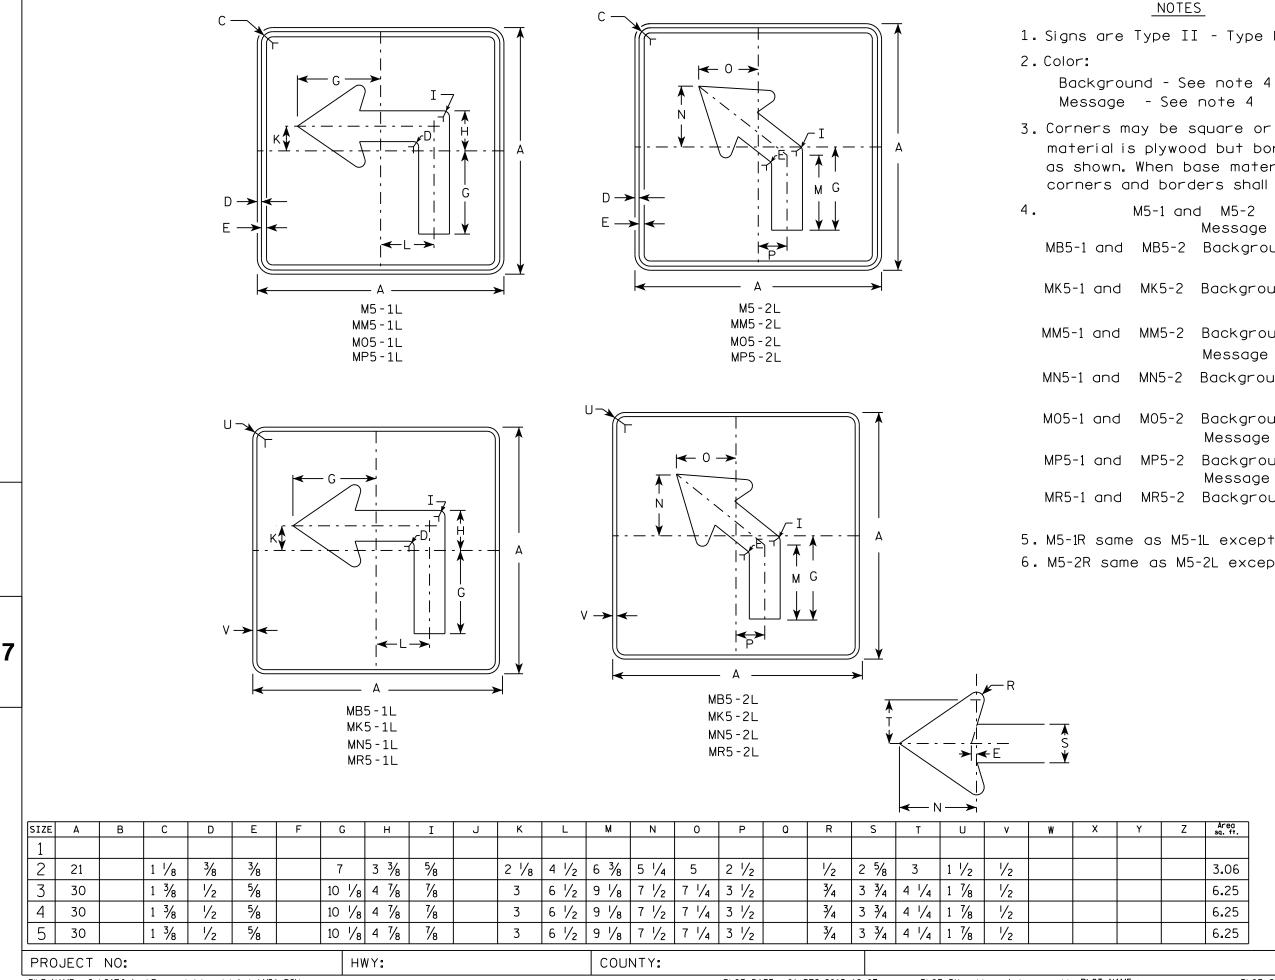PLOT DATE . 01-DEC-2015 18.07

PLOT BY . \$\$ DIOTUSER \$\$ PLOT NAME :

```
NOTES
1. Signs are Type II - Type H reflective except as shown
3. Corners may be square or rounded when base
 material is plywood but borders shall be rounded
 as shown. When base material is metal, the
 corners and borders shall be rounded.
 M5-1 and M5-2
 Background - White
 Message - Black
 MB5-1 and MB5-2 Background - Blue
 Message - White
 MK5-1 and MK5-2 Background - Green
 Message - White
 MM5-1 and MM5-2 Background - White
 Message - Green
 MN5-1 and MN5-2 Background - Brown
 Message - White
 M05-1 and M05-2 Background - Orange - Type F Reflective
 Message - Black
 MP5-1 and MP5-2 Background - White - Type H Reflective
 Message - Blue
 MR5-1 and MR5-2 Background - Brown
 Message - Yellow
5. M5-1R same as M5-1L except arrow points right.
6. M5-2R same as M5-2L except arrow tilts right.
```

	Aree	STA		RD SIGN	1	
Z	Area sq. ft.	М	5-1 8	& M5-2		
	3.06	WISCONSIN	DEPT OF	TRANSPORT	ATION	
	6.25	APPROVED	Matthe	v R Ra		1
	6.25			State Traffic Engineer		
	6.25	DATE <u>10/15</u> /		PLATE NO. ME	5-1.13	
			SHEET	NO:		Ε

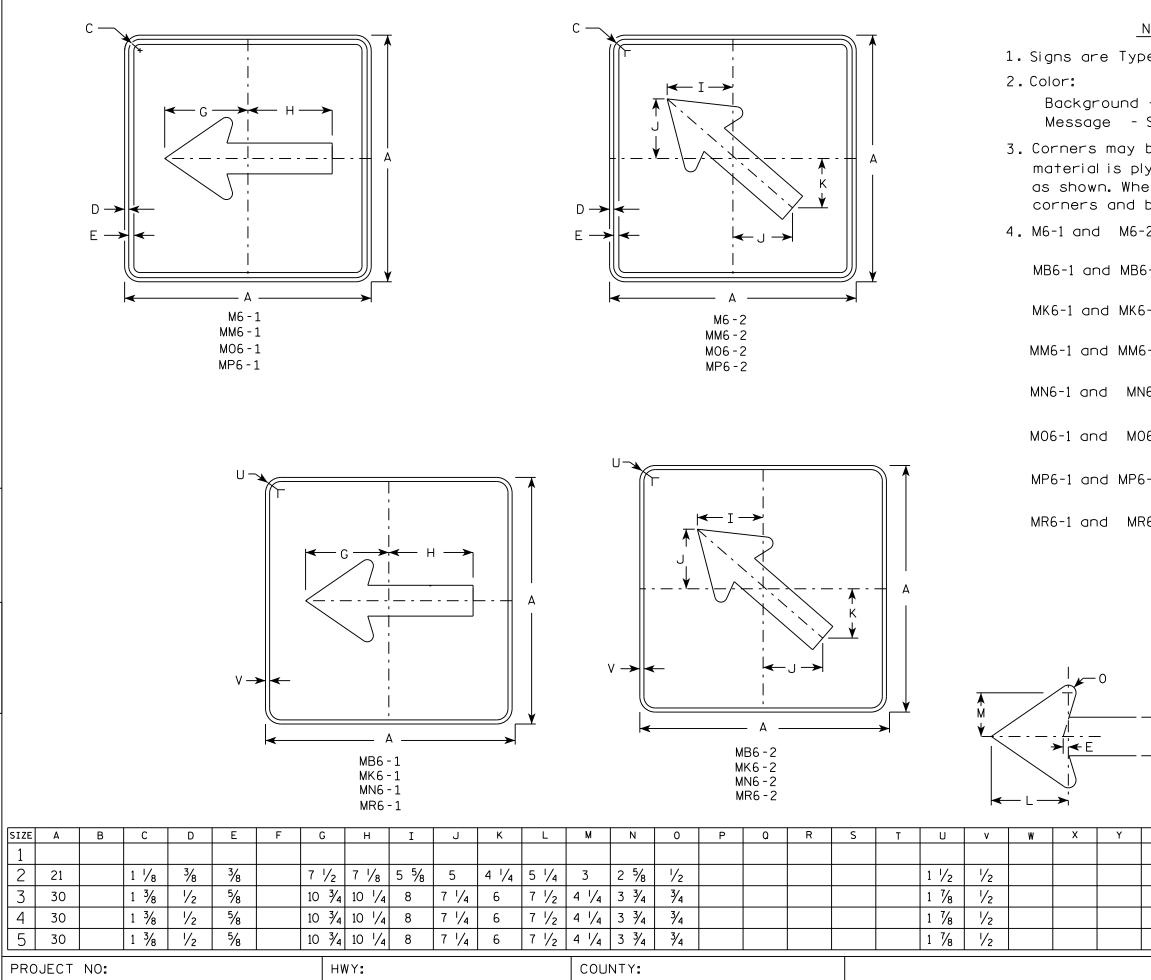

FILE NAME · C·\CAEfiles\Projects\tr_stdplate\M61_DCN

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PINT DATE . 01-DEC-2015 17.57 PINT RY . \$\$ 010

PLOT BY . \$\$ DIOTUSER \$\$ PLOT NAME :

NOTES
e II - Type H except as Shown
- See note 4 See note 4
be square or rounded when base ywood but borders shall be rounded en base material is metal, the borders shall be rounded.
2 Background – White Message – Black
5-2 Background - Blue Message - White
-2 Background - Green Message - White
-2 Background - White Message - Green
6-2 Background - Brown Message - White
6-2 Background - Orange - Type F Reflective Message - Black
-2 Background - White Message - Blue
6-2 Background – Brown Message – Yellow

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Z	Årea sq. ft.		5-1 8	RD SIGN & M6-2 RIES	N	
	3.06	WISCONSIN	DEPT OF	TRANSPORT	ATION	
	6.25	APPROVED	Matthe	, P P		1
	6.25			Traffic Engineer	ww	ሥ
	6.25	DATE <u>10/15</u>	/15	PLATE NO	16-1.1	5
			SHEET	NO:		Ε

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- 2. Color: Background - White
- 3. Message Series C
- reflectorized red.

R1-2
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SIZE	Α	В	С	D	E	F	G	н	I	J	к	L	M	N	0	Р	0	R	S	Т	U	v	W	x	Y
1	30	26	1 1/2	5⁄8	4	2 1/2	6 3/8	7⁄8	4	3 5/8															
25	36	31	2	3⁄4	5	3	7 3⁄4	1 1/4	4 3/4	4 3/8															
2M	48	42	3	1	6	4	9 3⁄4	2	6 1/4	5 7/8															
3	48	42	3	1	6	4	9 3⁄4	2	6 1/4	5 7/8															
4	48	42	3	1	6	4	9 3/4	2	6 1/4	5 7/8															
5	60	52	3	1 1/2	8	5	13	2 1/2	7 7/8	7 1⁄4															
6																									
7	18	15 1/2	1	3∕8	2 1/2	1 1/2	3 7/8	5%	2 3/8	2 1/4															
PR0.	PROJECT NO:							Y:					COUNTY:												

FILE NAME : C:\CAEFiles\Projects\tr_stdplate\R12.DGN

7

PLOT DATE : 13-0CT-2014 15:12

PLOT NAME : PLOT BY : mscsja


### NOTES

1. Sign is Type II - Type H Reflective - reference WIS DOT Standard Specification for HIGHWAY and STRUCTURE CONSTRUCTION latest edition.

Message - See note 5 4. Corners may be square or rounded when base material is plywood but borders shall be rounded as shown. When base material is metal, the corners and borders shall be rounded. 5. The border strip and word message are

Z	Ared sq. ft.	
	2.71	
	3.88	STANDARD SIGN
	7.00	R1-2
	7.00	
	7.00	WISCONSIN DEPT OF TRANSPORTATION
	10.83	APPROVED Matthew & Rauch
		For State Traffic Engineer
	0.97	DATE 10/13/14 PLATE NO. R1-2.12
		SHEET NO: E

WISDOT/CADDS SHEET 42

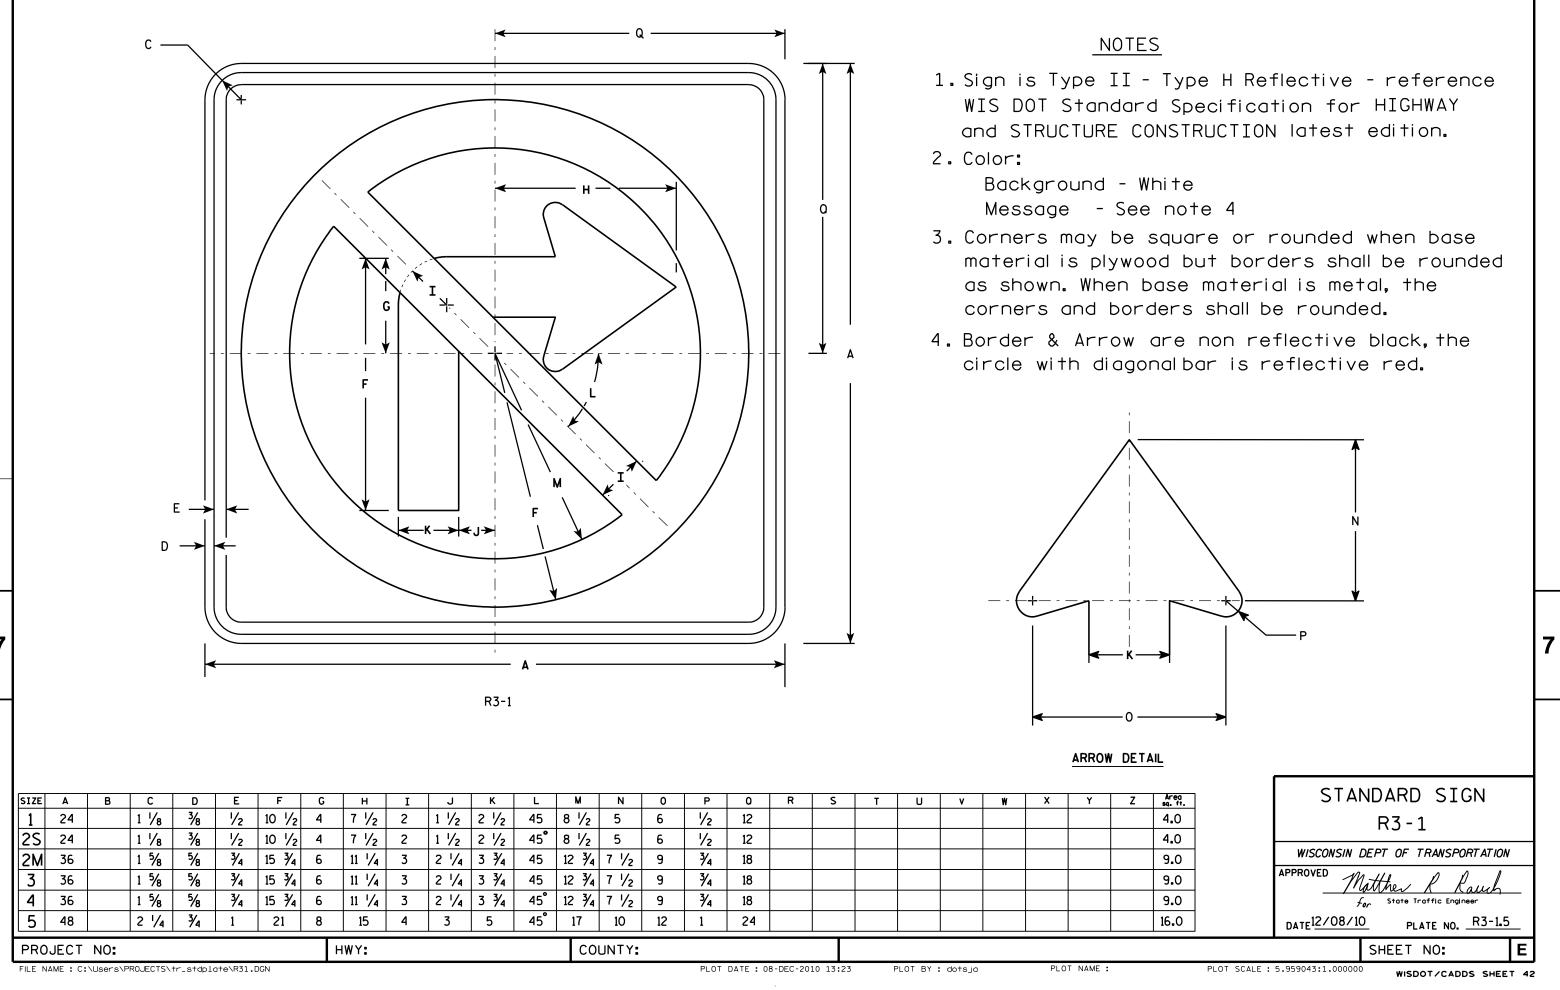


7		<ol> <li>Sign is Typ WIS DOT St and STRUCTI</li> <li>Color: Backgroun Message</li> <li>Corners ma material is as shown. N corners an</li> <li>Border &amp; A circle with</li> </ol>
	$ \begin{array}{c ccccccccccccccccccccccccccccccccccc$	X         Y         Z         Areg. sq. fr.           4.0         4.0         4.0           9.0         9.0         9.0           9.0         9.0         16.0
	4       36       1 \$\frac{5}{8}\$       \$\frac{3}{4}\$       15 \$\frac{3}{4}\$       6       11 \$\frac{1}{4}\$       3       2 \$\frac{1}{4}\$       3 \$\frac{3}{4}\$       45°       12 \$\frac{3}{4}\$       7 \$\frac{1}{2}\$       9       \$\frac{3}{4}\$       10       10       10       10       10	9

### NOTES

ype II - Type H Reflective - reference Standard Specification for HIGHWAY TURE CONSTRUCTION latest edition.

ound - White - See note 4 may be square or rounded when base s plywood but borders shall be rounded When base material is metal, the and borders shall be rounded. Arrow are non reflective black, the h diagonal bar is reflective red.

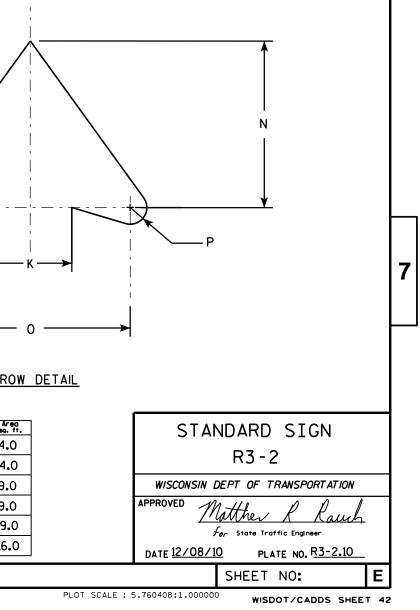


		ONLY (B)	(C)	>	<u>NOTES</u> 1. Sigs are Type II - Ty 2. Color: Background - White Message - Black 3. Message Series - D 4. Use appropriate Lette Each letter added mal 5. Square footage of si 1 Letter = 3.75 sq
		(E)	(F)	(G)	6.0 sq 10.0 sq 2 Letters = 7.5 sq 12.0 sq 20.0 sq 3 Letters = 11.25 sq 18.0 sq 30.0 sq 4 Letters = 15.0 sq
7		D NLY (L)			24.0 sq 40.0 sq 5 Letters = 18.75 sq 30.0 sq 50.0 sq 6 Letters = 22.5 sq 36.0 sq 60.0 sq 6. When letters C,D, Right end of the
	PROJECT NO:				Add the amounts these letters ar 1.25 sq ft for Si 1.5 sq ft for Si 2.0 sq ft for Si

FILE NAME : C:\CAEfiles\Projects\stdplate_R38.dgn

PLOT NAME :

Type H Reflective


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ter for Sign Code
akes sign wider. Example R3-8EAR
sign varies by letters
sq ft for Size 2
ft for Size 3
a ft for Size 4 or 5
ft for Size 2
g ft for Size 3
sq ft for Size 4 or 5
sq ft for Size 2
g ft for Size 3
sq ft for Size 4 or 5
g ft for Size 2
sa ft for Size 3
sq ft for Size 4 or 5
sq ft for Size 2
sq ft for Size 3
sq ft for Size 4 or 5
 7
a ft for Size 2
sa ft for Size 3
sq ft for Size 4 or 5
D.G.H are used on the Left or
he sign the Sq.Ft.changes.
s when
 STANDARD SIGN
re used:
 R3-8 Series
Size 2
 WISCONSIN DEPT OF TRANSPORTATION
Size 3
 APPROVED Matther
Size 4 or 5
 alle
 For State Traffic Engineer
 DATE <u>5/21/19</u> PLATE NO. <u>R3-8.1</u>
 SHEET NO:
 Ε
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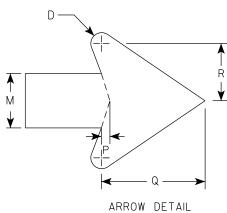

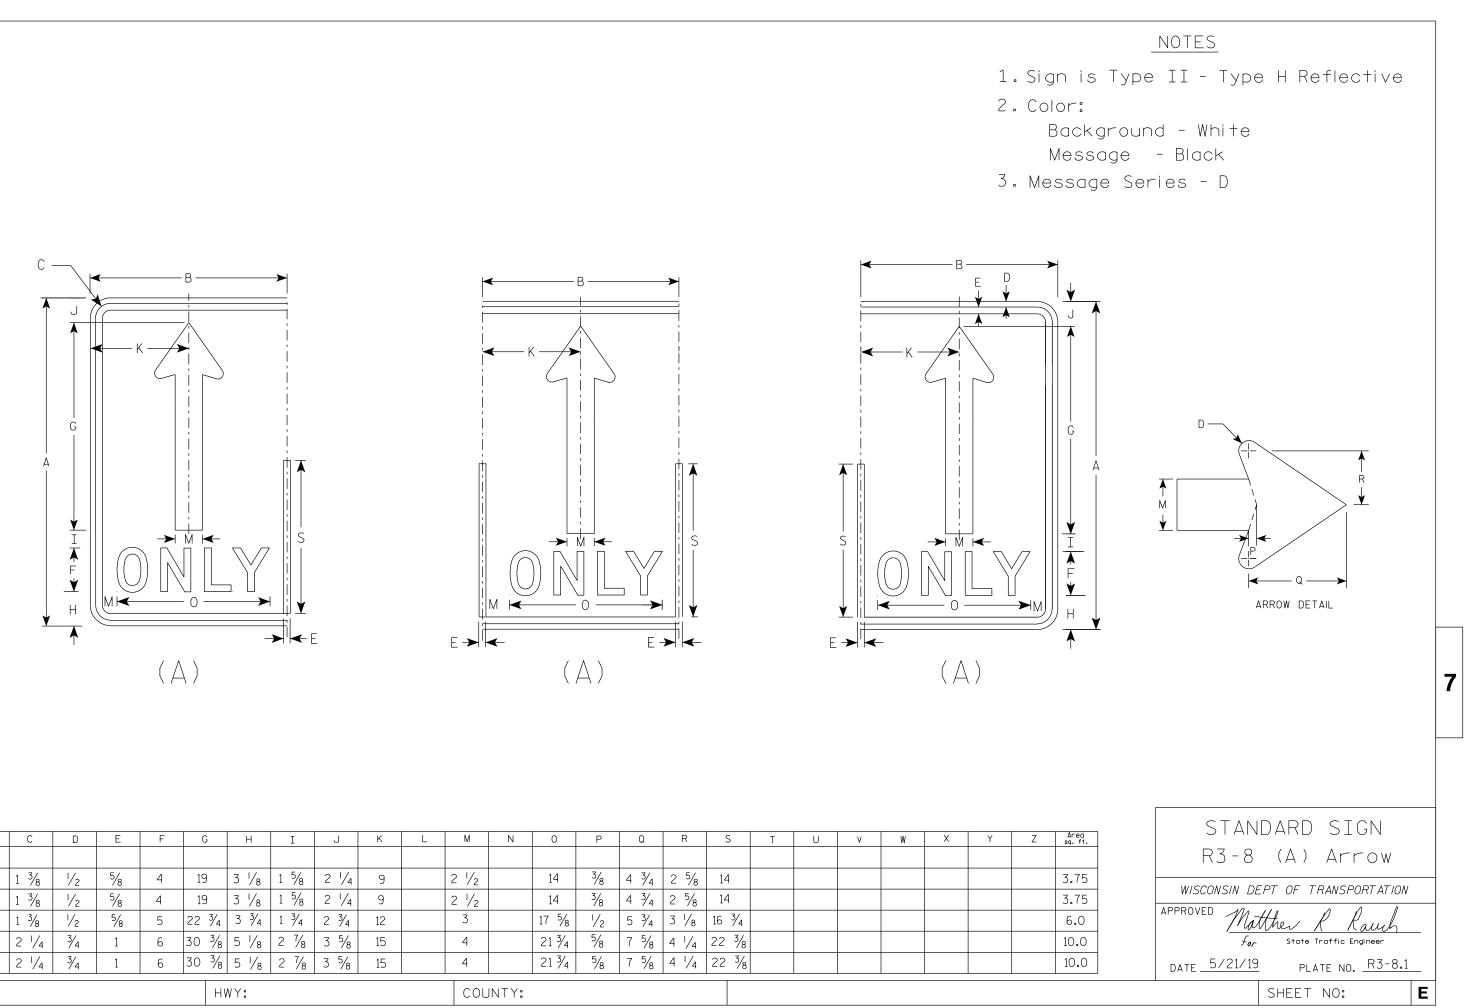
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SIZE	А	В	С	D	E	F	G	н	I	J	К	L	М	N	0	Р	Q	R	S	Т	U	V	W	X	Y	Z
1																										
2S	30	18	1 3⁄8	1/2	5⁄8	4	19	3 1/8	1 5⁄8	2 1/4	9		2 1/2		14	3⁄8	4 3/4	2 5/8	14							
2M	30	18	1 3/8	1/2	5⁄8	4	19	3 1/8	1 5⁄8	2 1/4	9		2 1/2		14	3⁄8	4 3/4	2 5/8	14							
3	36	24	1 3/8	1/2	5⁄8	5	22 3⁄4	3 3/4	1 3⁄4	2 3⁄4	12		3		17 5⁄8	1/2	5 3⁄4	3 1/8	16 3⁄4							
4	48	30	2 1/4	3⁄4	1	6	30 3/8	5  /8	2 7/8	3 5/8	15		4		21 3⁄4	5⁄8	7 5/8	4 1/4	22 3/8							
5	48	30	2 1/4	3⁄4	1	6	30 3/8	5  /8	2 7/8	3 5/8	15		4		21 3⁄4	5⁄8	7 5/8	4 1/4	22 3/8							
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FILE NA	AME : C:	\CAEfiles	s\Project	s\stdpla	te_R38.d	Ign										PLOT [	DATE : 21	-MAY 201	9 4:38	PL	_OT BY :	mscj9h		PLOT	NAME :	

2. Color:



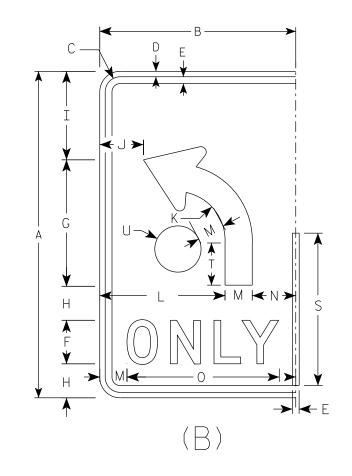

SIZE	А	В	С	D	E	F	G	н	I	J	K	L	М	Ν	0	P	Q	R	S	Т	U	V	W	X	Y	Z
1																										
2S	30	18	1 3/8	1/2	5⁄8	4	11 5⁄8	3 1/8	8  /8	4	4 1/2	11 1/2	2 1/2	4	14	3⁄8	4 3/4	2 5/8	14	3 7/8	2 1/8					
2M	30	18	1 3/8	1/2	5⁄8	4	11 5/8	3 1/8	8 1/8	4	4 ¹ / ₂	11 1/2	2 1/2	4	14	3/8	4 3/4	2 5/8	14	3 7/8	2 1/8					
3	36	24	1 3⁄8	1/2	5⁄8	5	14	3 1/2	9 3/4	6	5 3/8	15	3	6	17 5/8	1/2	5 3⁄4	3 1/8	16 3⁄4	4 5/8	2 1/2					
4	48	30	2 1/4	3⁄4	1	6	18 5/8	5 1/8	13 1/8	6  /8	7 1/4	18	4	8	21 3⁄4	5⁄8	7 5/8	4 1/4	22 3/8	6 1/4	3 3/8					
5	48	30	2 1/4	3⁄4	1	6	18	5  /8	13 1/8	6 1/8	7 1/4	18	4	8	21 3⁄4	5⁄8	7 5/8	4 ¹ / ₄	22 3⁄8	6 1/4	3 3/8					
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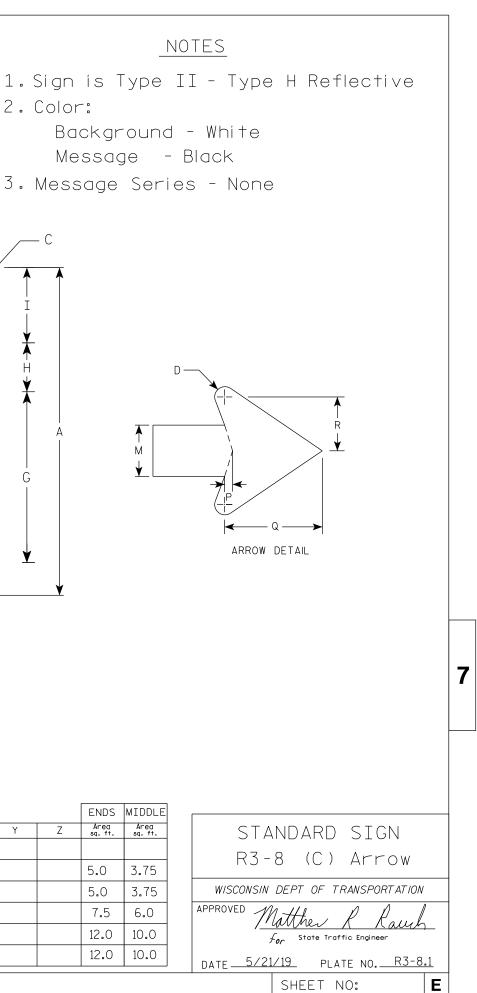
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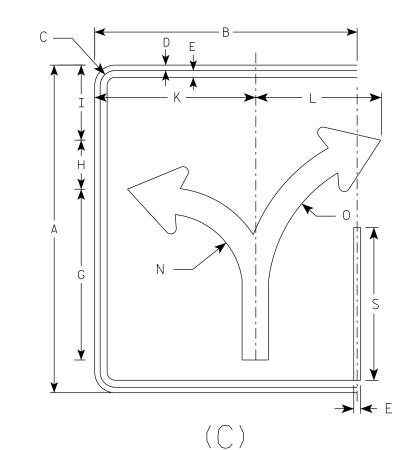
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NOTES
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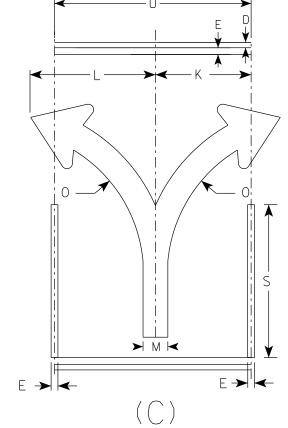
```
1. Sign is Type II - Type H Reflective
 Background - White
 Message – Black
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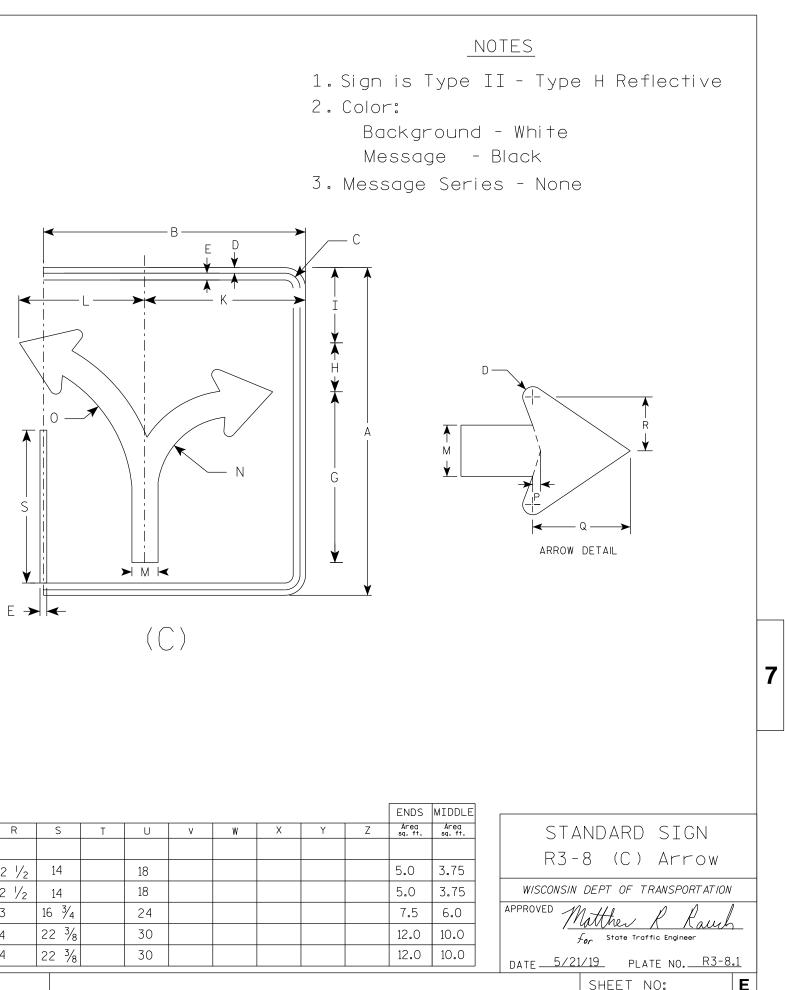
Message Series - D

Z	Area sq. ft.	STANDARD SIGN
		R3-8 (B) Arrow
	3.75	T(J O (D) ATTOW
	3.75	WISCONSIN DEPT OF TRANSPORTATION
	6.0	APPROVED Matthew & Rouch
	10.0	For State Traffic Engineer
	10.0	DATE <u>5/21/19</u> PLATE NO. <u>R3-8.1</u>
		SHEET NO: E










	SIZE A B C D E F G H T J K L M N O P Q R S T U V W X Y Z																									
SIZE	А	В	С	D	E	F	G	Н	I	C	К	L	М	N	0	Ρ	Q	R	S	Т	U	V	W	Х	Y	
1																										
2S	30	24	1 3/8	1/2	5⁄/8		15 5/8	4 ¹ / ₂	6 1/8		14 3⁄4	11 1/2	2 3/8	7	13 1/4	3⁄8	4 ¹ / ₂	2 1/2	14		18					
2M	30	24	1 3/8	1/2	5⁄8		15 5/8	4 1/2	6 7/8		14 3⁄4	11 1/2	2 3/8	7	13 1/4	3⁄8	4 1/2	2 1/2	14		18					
3	36	30	1 3/8	1/2	5⁄8		18 3⁄4	5 ½	8 ¹ /4		17 1/4	17 1/4	2 7/8	8 3/8	16	1/2	5 ½	3	16 3⁄4		24					
4	48	36	2 1/4	3⁄4	1		24 7/8	7 1/4	11		23 1/8	18	3 3/4	11 1/8	21 1/4	5⁄8	7 1/8	4	22 3/8		30					
5	48	36	2 1/4	3⁄4	1		24 7/8	7 1/4	11		23 1/8	18	3 3/4	11 1/8	21 1/4	5⁄8	7 1/8	4	22 3/8		30					
PRO	JECT	NO:					н	WY:					COU	NTY:												
FILE NA	NAME : C:\CAEfiles\Projects\stdplate_R38.dgn															PLOT DA	ATE : 21-M	MAY 2019	4:38	PLOT	ſBY:ms	scj9h		PLOT N	AME :	


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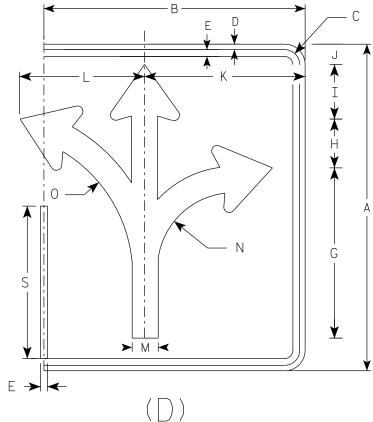
PLOT DATE : 21-MAY 2019 4:38

2. Color:





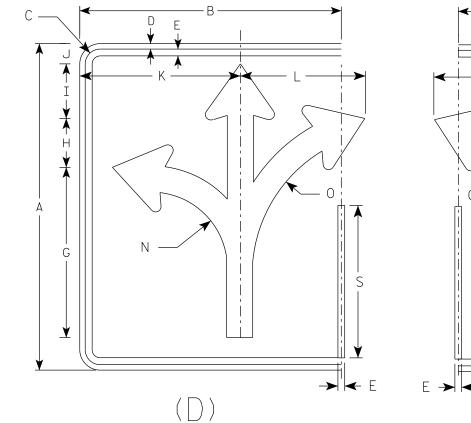

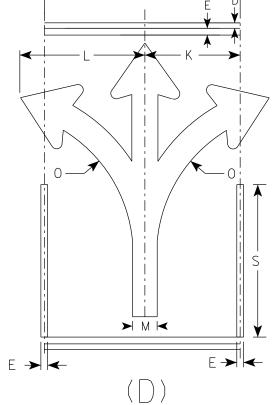


SIZE	Α	В	С	D	E	F	G	н	I	J	К	L	М	N	0	Р	Q	R	S	Т	U	v	W	X	Y	Z
1																										
2S	30	24	1 3/8	1/2	5⁄8		15 5/8	4 1/2	5	1 7/8	14 3/4	11 1/2	2 3/8	7	13 1/4	3⁄8	4 1/2	2 1/2	14		18					
2M	30	24	1 3/8	1/2	5⁄8		15 5/8	4 1/2	5	1 1/8	14 3/4	11 1/2	2 3/8	7	13 1/4	3⁄8	4 1/2	2 1/2	14		18					
3	36	30	1 3/8	1/2	5⁄8		18 3⁄4	5 1/2	6	2 1/4	17 1/4	17 1/4	2 7/8	8 3/8	16	1/2	5  / ₂	3	16 3⁄4		24					
4	48	36	2 1/4	3⁄4	1		24 7/8	7 1/4	7 7/8	3 1/8	23 1/8	18	3 3/4	11 1/8	21 1/4	5⁄8	7 1/8	4	22 3/8		30					
5	48	36	2 1/4	3⁄4	1		24 7/8	7 1/4	7 7⁄8	3 1/8	23 1/8	18	3 3⁄4	11 1/8	21 1/4	5⁄8	7 1/8	4	22 3/8		30					
PRC	JECT	NO:					Н	WY:					COU	NTY:												

FILE NAME : C:\CAEfiles\Projects\stdplate_R38.dgn

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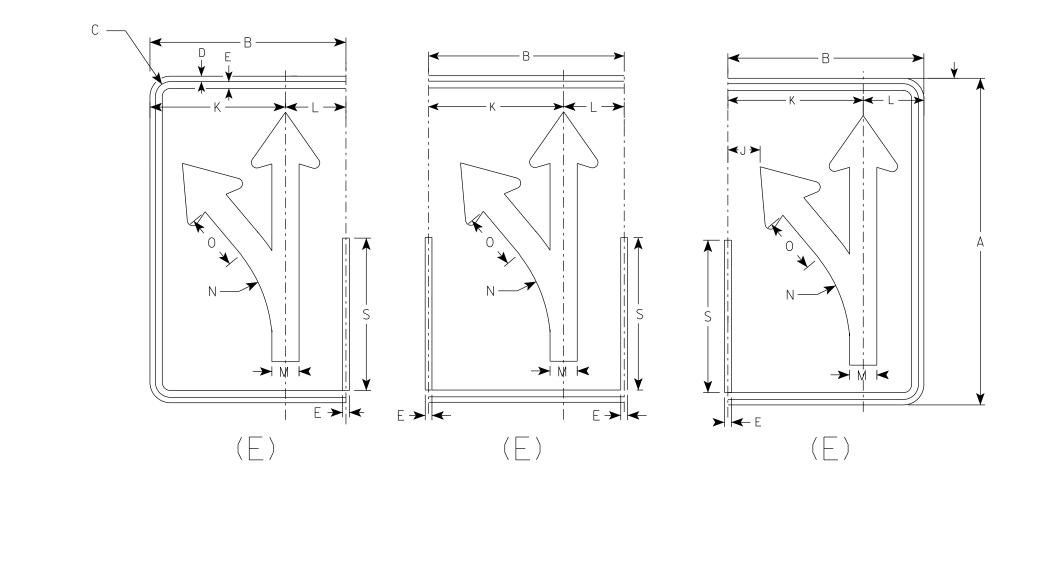
PLOT DATE : 21-MAY 2019 4:38 PLOT BY : mscj9h PLOT NAME :

```
NOTES
1. Sign is Type II - Type H Reflective
 Background - White
 Message – Black
3. Message Series - None
```

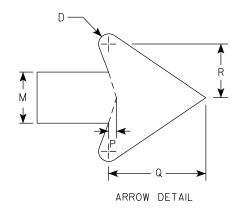


	ENDS	MIDDLE		
Ζ	Area sq. ft.	Area sq. ft.		STANDARD SIGN
				R3-8 (D) Arrow
	5.0	3.75		T(5 6 (D) ATTOW
	5.0	3.75		WISCONSIN DEPT OF TRANSPORTATION
	7.5	6.0		APPROVED Matthew & Rauch
	12.0	10.0		$f_{or}$ State Traffic Engineer
	12.0	10.0	]	DATE <u>5/21/19</u> PLATE NO. <u>R3-8.1</u>
				SHEET NO: E
	PI	LOT SCAL	E:\$	\$plotscale\$ WISDOT/CADDS SHEET 42

2. Color:




SIZE	А	В	С	D	E	F	G	Н	I	J	K	L	M	N	0	Р	Q	R	S	Т	U	V	W	Х	Y	Z
1																										
25	30	18	1 3/8	1/2	5⁄8		18 1/4	4 ³ ⁄4	3 1/4	3	12 1/2	$5 \frac{1}{2}$	2 1/2	13 1/4	5 1/8	3⁄8	4 ³ ⁄4	2	14							
2M	30	18	1 3/8	1/2	5⁄8		18 1/4	4 ³ ⁄4	3 1/4	3	12 1/2	5 1/2	2 1/2	13 1/4	5 1/8	3⁄8	4 3/4	2 5/8	14							
3	36	24	1 3/8	1/2	5⁄8		21 7⁄8	5 5/8	4	4 7/8	16 1⁄8	7 3⁄4	3	15 7/8	6  /8	1/2	5 3⁄4	3  /8	16 3⁄4							
4	48	30	2 1/4	3⁄4	1		29 1/8	7 1/2	5 1/4	5 3/8	20 1/2	9 1/ ₂	4	21 1/4	8 1/4	5⁄8	7 5/8	4 ¹ / ₄	22							
5	48	30	2 1/4	3⁄4	1		29 1/8	7 1/2	5 1/4	5 3/8	20 1/2	9 1/ ₂	4	21 1/4	8 1/4	5⁄8	7 5/8	4 1/4	22 <u></u> 3⁄8							
PRO	JECT	NO:					Н٧	NY:					COU	NTY:												
FILE N	AME : C:	\CAEfile	es\Projec	ts∖stdpla	te_R38.d	gn	·									PLOT DA	TE : 21-N	MAY 2019	4:38	PLO	T BY : ms	scj9h		PLOT N	AME :	

7

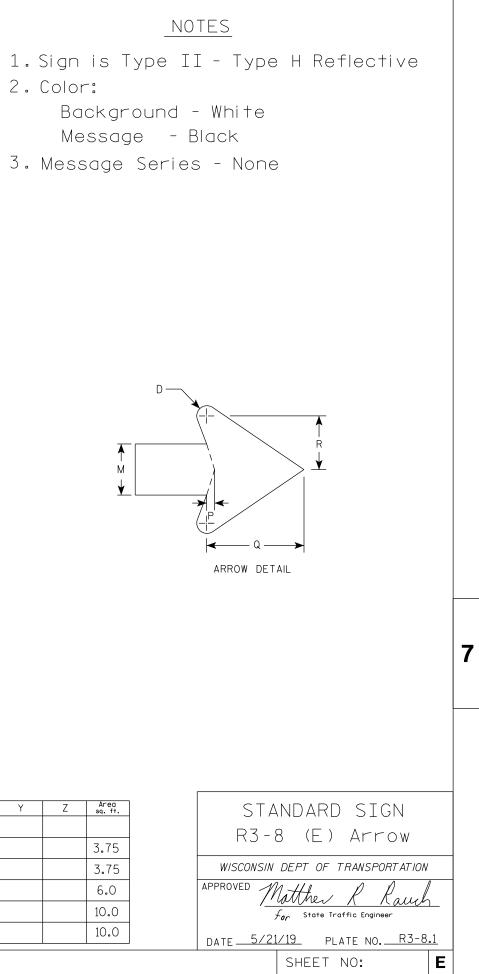

1. Sign is Type II - Type H Reflective 2. Color: Background - White Message - Black

3. Message Series - None

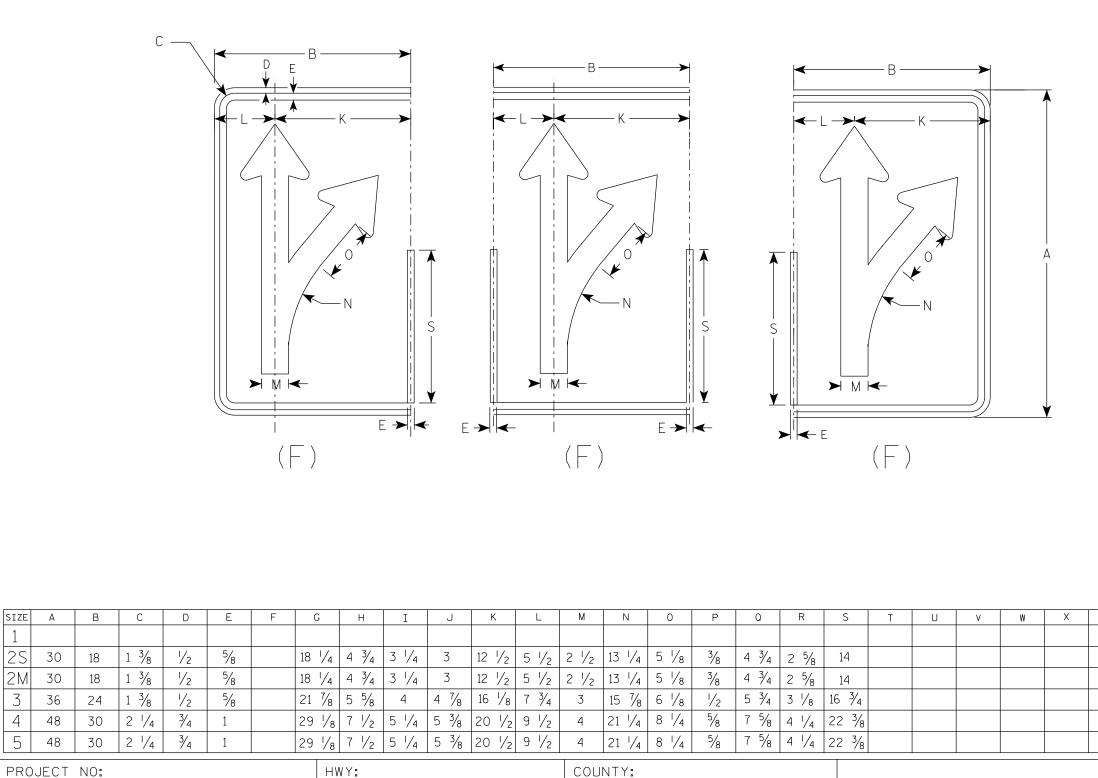

7

1

3


4

5

PLOT DATE : 21-MAY 2019 4:38 PLOT BY : mscj9h PLOT NAME :

Y


# NOTES

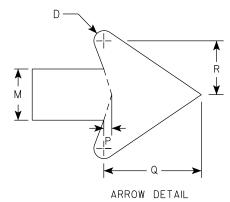


<u>Z</u>	Area sq. ft.		STANDARD SIGN
			R3-8 (F) Arrow
	3.75		113 0 117 ATTOW
	3.75		WISCONSIN DEPT OF TRANSPORTATION
	6.0		APPROVED Matthew & Rauch
	10.0		For State Traffic Engineer
	10.0		DATE <u>5/21/19</u> PLATE NO. <u>R3-8.1</u>
			SHEET NO: <b>E</b>
	Pl	_OT SCALE : \$	\$plotscale\$ WISDOT/CADDS SHEET 42

1. Sign is Type II - Type H Reflective

2. Color:

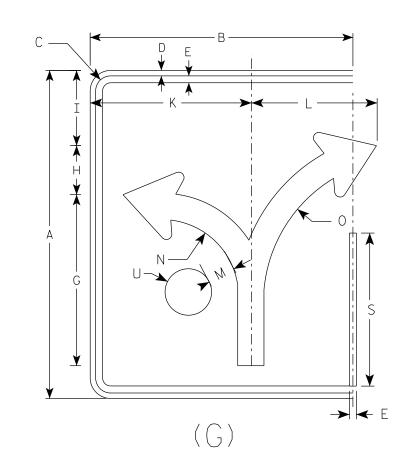

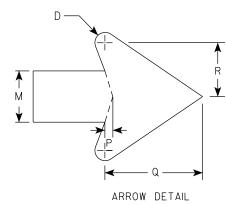

SIZE	А	В	С	D	E	F	G	н	I	J	К	L	М	N	0	P	Q	R	S	Т	U	V	w	Х	Y	
1																										
2S	30	24	1 3/8	1/2	5⁄8		15 5⁄8	4 1/2	6 7/8		14 3⁄4	11 ^I /2	2 3⁄8	7	13 1/4	3⁄8	4 1/2	2 1/2	14		2 1/8					
2M	30	24	1 3/8	1/2	5⁄8		15 ⁵ ⁄8	4 ¹ / ₂	6 1/8		14 3⁄4	11  /2	2 3⁄8	7	13 1/4	3⁄8	4 ¹ / ₂	2 1/2	14		2 1/8					
3	36	30	1 3/8	1/2	5⁄8		18 3⁄4	18 ³ / ₄ 5 ¹ / ₂ 8 ¹ / ₄ 17 ¹ / ₄ 17 ¹ / ₄ 2 ⁷ / ₈ 8 ³ / ₈									5 ½	3	16 3⁄4		2 1/2					
4	48	36	2 1/4	3⁄4	1		24 7/8	7 1/4	11		23 1/8	18	3 ¾	11 1/8	21 1/4	5⁄8	7 1/8	4	22 3/8		3 3/8					
5	48	36	2 1/4	3⁄4	1		24 7/8	7 1/4	11		23 1/8	18	3 3⁄4	11 1/8	21 1/4	5⁄8	7 1/8	4	22 3/8		3 3/8					
PRC	JECT	NO:					Н٧	WY:					COU	NTY:												
FILE N	AME : C:	\CAEfile	s\Projec	ts\stdplc	ate_R38.d	gn										PLOT DA	TE : 21-N	MAY 2019	4:38	PLO	T BY : ms	icj9h		PLOT NA	ME :	

7

# NOTES


Background - White


Message – Black

3. Message Series - None

Z	Area sq. ft.				RD SIG		
	5.0		K3-4	8 (6	) Arro	S W	
	5.0		WISCONSIN	DEPT OF	- TRANSPOR	TATION	
	7.5		APPROVED	atthe.	, R K	Juch	
	12.0		// /	<u> </u>	Traffic Engineer	000-01	-
	12.0		DATE <u>5/21</u>	/19_	PLATE NO	R3-8.1	<u> </u>
			1	SHEE			Ε
	Pl	_OT SCALE : \$	\$plotscale.	••••** _{WIS}	SDOT/CADDS	SHEET	42

1. Sign is Type II - Type H Reflective 2. Color: Background - White Message – Black 3. Message Series - None

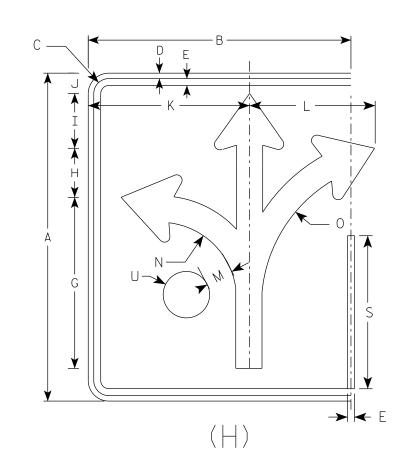

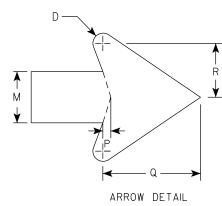

SIZE	А	В	С	D	E	F	G	н	I	J	K	L	М	N	0	Р	Q	R	S	Т	U	V	W	X	Y	
1																										
25	30	24	1 3/8	1/2	5⁄8		15 5/8	4 1/2	5	1 7/8	14 3⁄4	11  /2	2 3/8	7	13 1/4	3⁄8	4 1/2	2 1/2	14		2 1/8					
2M	30	24	1 3/8	1/2	5⁄8		15 5/8	4 1/2	5	1 7/8	14 3⁄4	11 ^I / ₂	2 3/8	7	13 1/4	3⁄8	4 1/2	2 1/2	14		2 1/8					
3	36	30	1 3/8	1/2	5⁄8		18 3⁄4	5 1/2	6	3 1/8	17 1/4	17 1/4	2 7/8	8 3/8	16	1/2	5 1/2	3	16 3⁄4		2 1/2					
4	48	36	2 1/4	3⁄4	1		24 7/8	7 1/4	7 7/8	3 1/8	23 1/8	18	3 3/4	11 1/8	21 1/4	5⁄8	7 1/8	4	22 3/8		3 3/8					
5	48	36												11 1/8	21 1/4	5⁄8	7 1/8	4	22 3/8		3 3/8					
PRC	PROJECT NO: HWY:												COU	NTY:												

FILE NAME : C:\CAEfiles\Projects\stdplate_R38.dgn

7

PLOT DATE : 21-MAY 2019 4:38 PLOT BY : mscj9h PLOT NAME :


# NOTES


Z	Area sq. ft.	STANDARD SIGN	
		R3-8 (H) Arrow	
	5.0		v
	5.0	WISCONSIN DEPT OF TRANSPORTA	TION
	7.5	APPROVED Matthew R Rad	ul
	12.0	$f_{or}$ State Traffic Engineer	
	12.0	DATE <u>5/21/19</u> PLATE NO. <u>R</u>	3-8.1
		SHEET NO:	E
	DI		

PLOT SCALE : \$\$.....plotscale.....\$\$ WISDOT/CADDS SHEET 42

2. Color:

3. Message Series - None

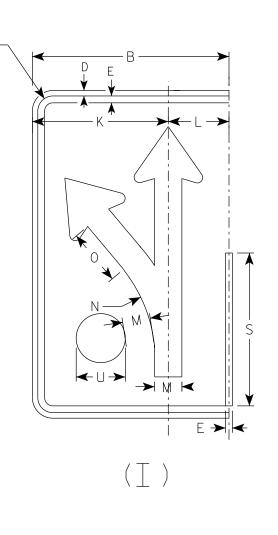

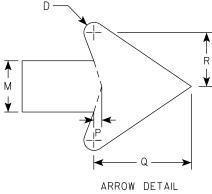

SIZE	А	В	С	D	E	F	G	Н	I	J	K	L	М	N	0	Р	Q	R	S	Т	U	V	W	Х	Y	
1																										
25	30	18	1 3/8	1/2	5⁄8		18 1/4	4 ³ ⁄4	3 1/4	3	12 1/2	5 1/2	2 1/2	13 1/4	5 1/8	3⁄8	4 3/4	2	14		2 1/8					
2M	30	18	1 3/8	1/2	5⁄8		18 1/4	4 ³ ⁄4	3 1/4	3	12 1/2	5 ½	2 1/2	13 1/4	5  /8	3⁄8	4 3/4	2 5/8	14		2 1/8					
3	36	24	1 3/8	1/2	5⁄8		21 7/8	5 5/8	4	4 7/8	16 1/8	7 3/4	3	15 7/8	6 1/8	1/2	5 3⁄4	3 1/8	16 3⁄4		2 1/2					
4	48	30	2 1/4	3⁄4	1		29 1/8	7 1/ ₂	5 1/4												3 3/8					
5	48	30	2 1/4	3⁄4	1	$\begin{array}{ c c c c c c c c c c c c c c c c c c c$											7 5/8	4 1/4	22 3/8		3 3/8					
PRC	ROJECT NO:     HWY:     COUNTY:																									
FILE N	ILE NAME : C:\CAEfiles\Projects\stdplate_R38.dgn															PLOT DA	TE : 21-N	MAY 2019	4:38	PL0	T BY : ms	cj9h		PLOT NA	AME :	

С

7


PLOT DATE : 21-MAY 2019 4:38

# NOTES

1. Sign is Type II - Type H Reflective Background - White Message – Black

Z	Area sq. ft.	STANDARD SIGN	
	3.75	R3-8 (I) Arrow	
	3.75	WISCONSIN DEPT OF TRANSPORTATION	
	6.0	APPROVED Matther R Rauch	
	10.0	$f_{or}$ State Traffic Engineer	,
	10.0	DATE <u>5/21/19</u> PLATE NO. <u>R3-8.1</u>	
			Ε
	-		

2. Color:

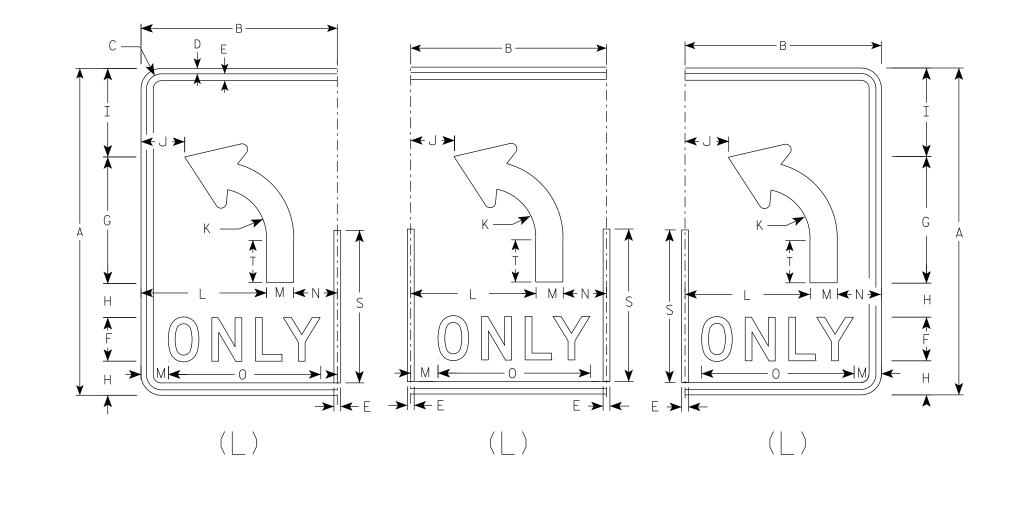


SIZE	А	В	С	D	E	F	G	н	I	J	К	L	М	N	0	Р	Q	R	S	Т	U	V	W	Х	Y	
1																										
2S	30	18	1 3/8	1/2	5⁄/8	4	11 5/8	3 1/8	8 ¹ /8	4	4 ¹ / ₂	11 1/2	2 1/2	4	14	3⁄8	4 3⁄4	2	14	3 7/8						
2M	30	18	1 3/8	1/2	5⁄8	4	11 5/8	3 1/8	8  /8	4	4 1/2	11 1/2	2 1/2	4	14	3⁄8	4 3/4	2 5/8	14	3 7/8						
3	36	24	1 3⁄8	1/2	5⁄8	5	14	3 1/2	9 3⁄4		5 3/8	15	3	6	17 5/8	1/2	5 3⁄4	3 1/8	16 3⁄4	4 5⁄8						
4	48	30	2 1/4	3⁄4	1	6	18 5/8	5 1/8	13 1/8	6  /8	7 1/4	18	4	8	21 3⁄4	5⁄8	7 5/8	4 ¹ / ₄	22 3/8	6  /4						
5	48	30	2 1/4	3⁄4	1	6	18 5⁄8	5 1/8	13 1/8	6  /8	7 1/4	18	4	8	21 3⁄4	5⁄8	7 5/8	4 ¹ / ₄	22 3/8	6  /4						
PRC	JECT	NO:																								
			s\Project	s\stdplc	1te_R38.d	lgn										PLOT D	ATE : 21-N	MAY 2019	4:38	PLOT	BY : ma	scj9h		PLOT N	AME :	



```
NOTES
1. Sign is Type II - Type H Reflective
 Background - White
 Message – Black
3. Message Series - D
 A
 M
 ARROW DETAIL
 7
 STANDARD SIGN
 Z Area sq. ft.
 R3-8 (L) Arrow
 3.75
 WISCONSIN DEPT OF TRANSPORTATION
 3.75
 APPROVED Matther
 6.0
 tauch
 10.0
 For State Traffic Engineer
 10.0
 DATE <u>5/21/19</u> PLATE NO. <u>R3-8.1</u>
 Ε
 SHEET NO:
```

- 2. Color:

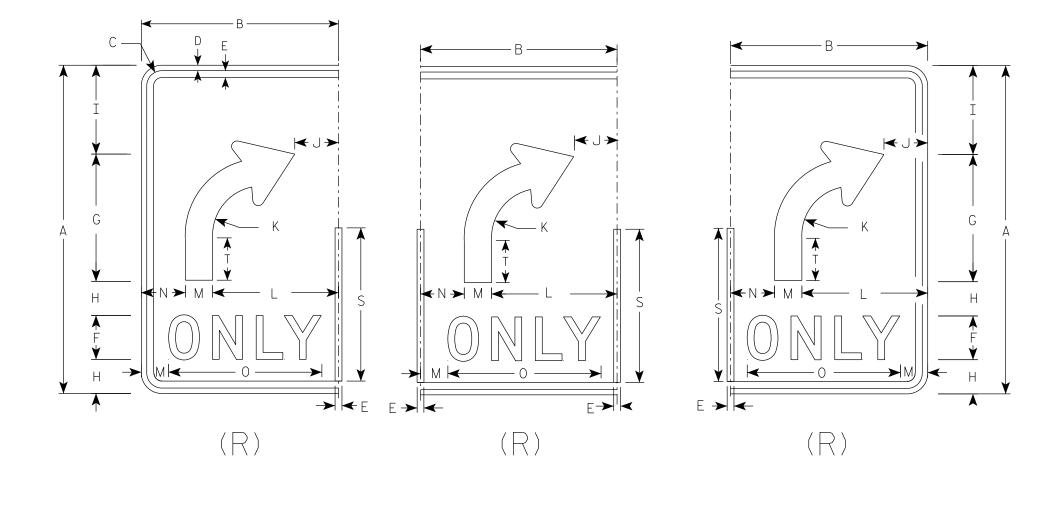


SIZE	А	В	С	D	E	F	G	Н	I	J	К	L	М	N	0	P	Q	R	S	Т	U	V	W	X	Y	
1																										
2S	30	18	1 3/8	1/2	5⁄8	4	11 5/8	3 1/8	8  / ₈	4	4 1/2	11 1/2	2 1/2	4	14	3⁄8	4 3/4	2 5/8	14	3 7/8						
2M	30	18	1 3/8	1/2	5⁄8	4	11 5⁄8	3 1/8	8 1/8	4	4 1/2	11 1/2	2 1/2	4	14	3⁄8	4 3/4	2 5/8	14	3 7/8						
3	36	24	1 3/8	1/2	5⁄8	5	14	3 1/2	9 3⁄4	6	5 3/8	15	З	6	17 5⁄8	1/2	5 3⁄4	3 1/8	16 3⁄4	4 5/8						
4	48	30	2 1/4	3⁄4	1	6	18 5⁄8	5 1/8	13 1/8	6 1/8	7 1/4	18	4	8	21 3⁄4	5⁄8	7 5/8	4 ¹ / ₄	22 3/8	6 1/4						
5	48	30	2 1/4	3⁄4	1	6	18 5⁄8	5  /8	13 1/8	6 1/8	7 1/4	18	4	8	21 3⁄4	5⁄8	7 5/8	4 1/4	22 3/8	6 1/4						
PRO	JECT	NO:																								

FILE NAME : C:\CAEfiles\Projects\stdplate_R38.dgn

7

PLOT NAME :

NOTES 1. Sign is Type II - Type H Reflective Background - White Message – Black 3. Message Series - D

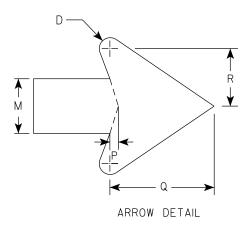



Z	Area sq. ft.	STANDARD SIGN	
		R3-8 (R) Arrow	
	3.75		
	3.75	WISCONSIN DEPT OF TRANSPORTATION	
	6.0	APPROVED Matthew R Rauch	
	10.0	For State Traffic Engineer	-
	10.0	DATE <u>5/21/19</u> PLATE NO. <u>R3-8.1</u>	_
		SHEET NO:	Ε

1. Sign is Type II - Type H Reflective 2. Color:

Background - White

3. Message Series - None

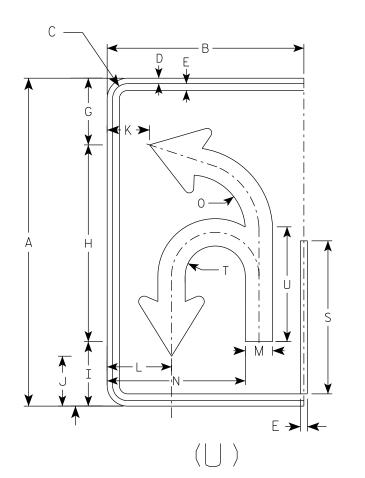

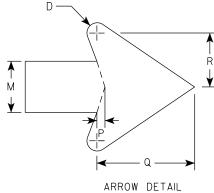


SIZE	А	В	С	D	E	F	G	н	I	J	K	L	М	N	0	Р	Q	R	S	Т	U	V	W	Х	Y	
1																										
2S	30	18	1 3⁄8	1/2	5⁄8		6  /8	18	5 7/8	4	3 7/8	5 7/8	2 1/2	12 5/8	5  /8	3⁄8	4 ³ ⁄4	2 5/8	14	2 3⁄4	10 1/2					
2M	30	18	1 3/8	1/2	5⁄8		6 ¹ / ₈	18	5 7/8	4 ⁵ / ₈	3 7/8	5 7/8	2 1/2	12 5/8	5 1/8	3⁄8	4 3/4	2 5/8	14	2 3⁄4	10 1/2					
3	36	24	1 3/8	1/2	5⁄8		21 7/8	21 5⁄8	7 1/8	5 1/2	5 7/8	8 1/4	3	16 3/8	6 1/8	1/2	5 3⁄4	3 1/8	16 3⁄4	3 1/4	12 5/8					
4	48	30	2 1/4	3⁄4	1		29 1/8	28 ³ ⁄4	9 3/8	7 1/4	6 1/8	10	4	20 7/8	8  / ₈	5⁄8	7 5/8	4 1/4	22 3/8	4 3/8	16 3⁄4					
5	48	30	2 1/4	3⁄4	1		29 1/8	28 3⁄4	9 3/8	7 1/4	6 7/8	10	4	20 7/8	8 1/8	5⁄8	7 5/8	4 1/4	22 3/8	4 3/8	16 3⁄4					
PRC	JECT	NO:	_				Н	WY:					COU	NTY:										_		
FILE N	AME : C:	\CAEfile	es\Project	ts\stdpla	te_R38.de	gn										PLOT DA	TE : 21-N	MAY 2019	4:38	PLO	T BY : ms	icj9h		PLOT N	AME :	

# NOTES

Message – Black

Ζ	Area sq. ft.		_		) SIGN							
	3.75		R3-8	3 (U)	Arrow							
	3.75		WISCONSIN	DEPT OF	TRANSPORTAT	ION						
	6.0		APPROVED	atthe.	R Rau	h						
	10.0		;	5	affic Engineer							
	10.0		DATE	. <u>/19</u> Pl	ATE NO. R3	<u>-8.1</u>						
	SHEET NO: E											
	PLOT SCALE : \$\$plotscale\$\$ WISDOT/CADDS SHEET 42											

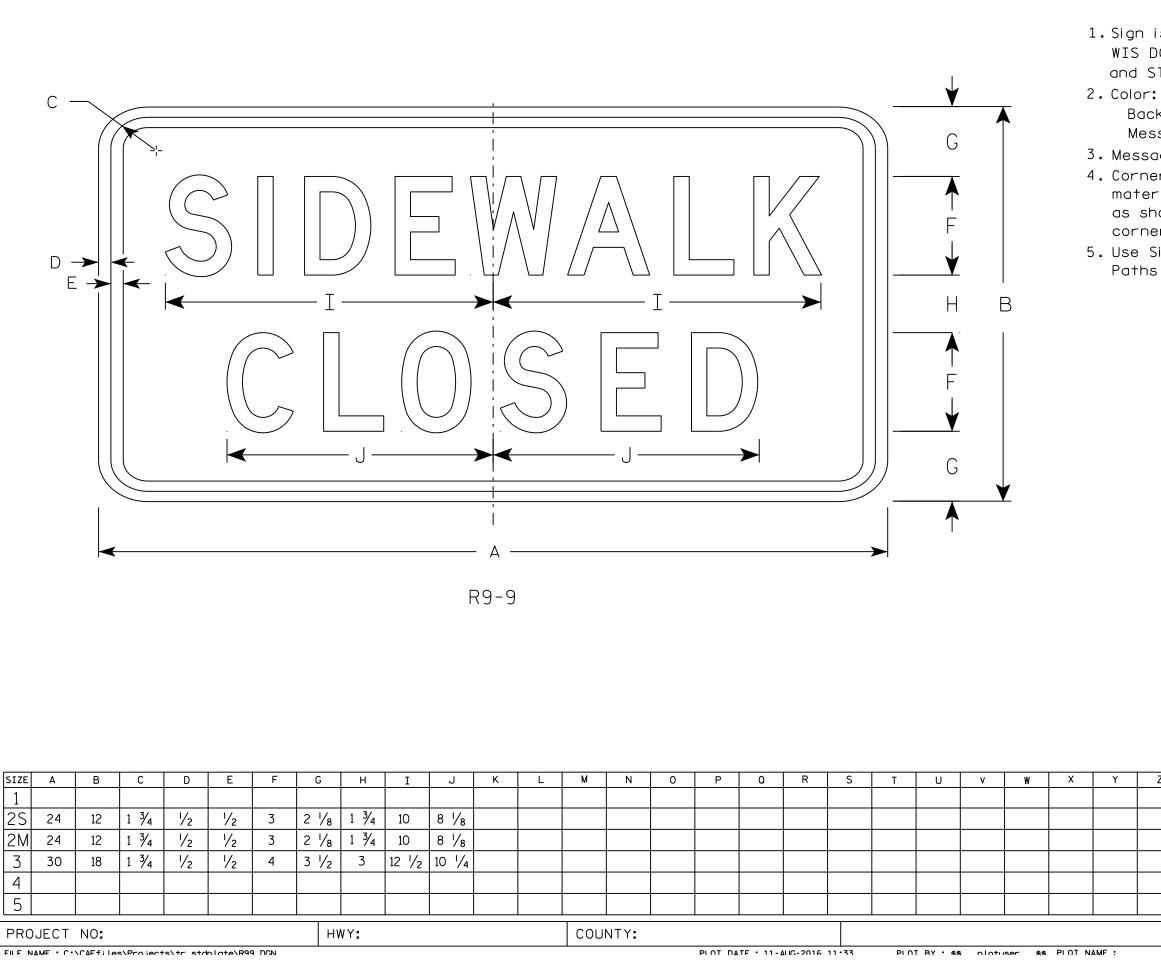


7

### NOTES

 Sign is Type II - Type H Reflective - reference WIS DOT Standard Specification for HIGHWAY and STRUCTURE CONSTRUCTION latest edition.
 Color: Background - White Message - Black
 Message Series - C
 Corners may be square or rounded when base material is plywood but borders shall be rounded as shown. When base material is metal, the corners and borders shall be rounded.
 Use Size 2 for Sidewalks. Use Size 3 for Paths and Trails.

Z	Area sq. ft.	STA		) SIGN	
			R9 -	9	
	2.0	WICCONCIN		TRANSPORTATIO	
	2.0		DEFIOR		//v
	3.75	APPROVED 2	Natther	R Rain	6
			for State Tr	affic Engineer	
		DATE <u>8/11/1</u>	<u>6</u> PL	ATE NO	9.6
			SHEET	NO:	E

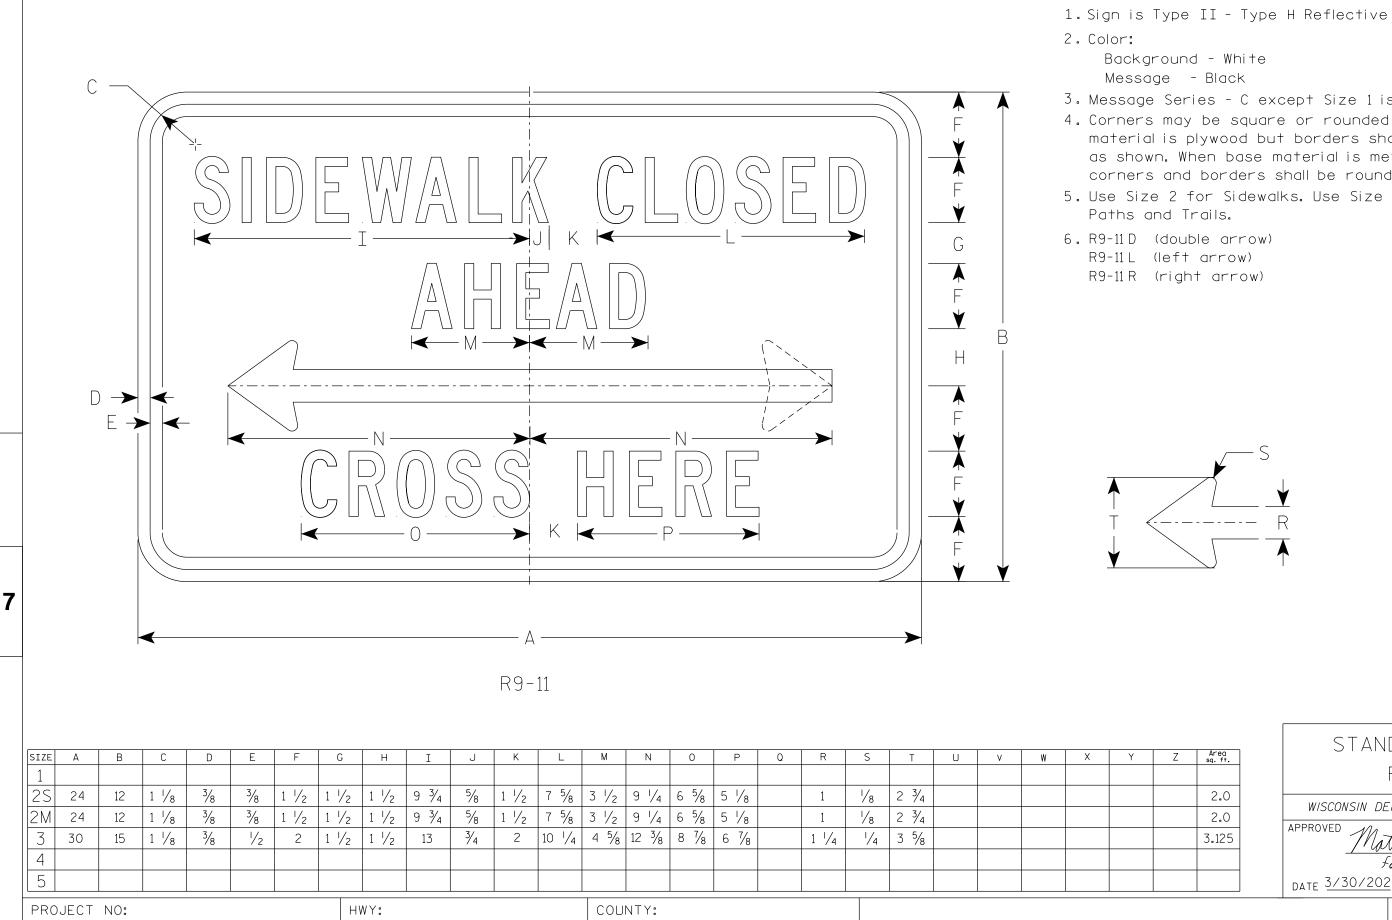

FILE NAME : C:\Users\PROJECTS\tr_stdplate\R911.dgn

PLOT DATE : 30-MAR 2021 1:40 PLOT BY : dotc4c PLOT NAME :

NOTES 3. Message Series - C except Size 1 is Series D 4. Corners may be square or rounded when base material is plywood but borders shall be rounded as shown. When base material is metal, the corners and borders shall be rounded. 5. Use Size 2 for Sidewalks. Use Size 3 for


Area sq. ft.	STANDARD SIGN R9-11
 2.0	WISCONSIN DEPT OF TRANSPORTATION
2.0	APPROVED ADA ILA DO
3.125	For State Traffic Engineer
	DATE <u>3/30/2021</u> PLATE NO. <u>R9-11.4</u>
	SHEET NO: E

							— K						K —		<b>&gt;</b>			G ¥								
		I								R11-2																— L —
7													0-		R11-	2 T		_0_			]					
	SIZE	А	В	С	D	E	F	G	н	I J	К	L	М	N	0	P	Q	R	S	Т	U	V	W	X	Y	Z Ar sq.
	1																									
	2S	48	30	1 3/8	1/2	5⁄8	8	5	4	13 1/4 13 1/	/2 19	14	15	13	15 5⁄8											10.
	2M	48	30	1 3/8	1/2	5⁄8	8	5	4	13 1/4 13 1/		14	15	13	15 5⁄8											10.
	3	48	30	1 3/8	1/2	5⁄8	8	5	4	13 1/4 13 1/	/2 19	14	15	13	15 5⁄8											10.
	4	48	30	1 3/8	1/2	5⁄8	8	5	4	13 1⁄4 13 1⁄4		14	15	13	15 5⁄8											10.
	5	48	30	1 3/8	1/2	5⁄8	8	5	4	13 1/4 13 1/	/2 19	14	15	13	15 5⁄8											10.
	PRC	JECT	NO:						HWY:				(	COUNT	Y:											
	FILE N	IAME : C	\Users\	PROJECTS	\tr_stdp.	late\R11:	2.dgn	I					I			PLC	DT DATE :	29-MAR	2021 8:1	5	PLOT E	3Y : doto	:4c	I	PLOT NAME	Ξ:


# G Ā $D \rightarrow \checkmark$ F E → V ≻≺ ΗB

С-

- 2. Color:
- 3. Message Series D

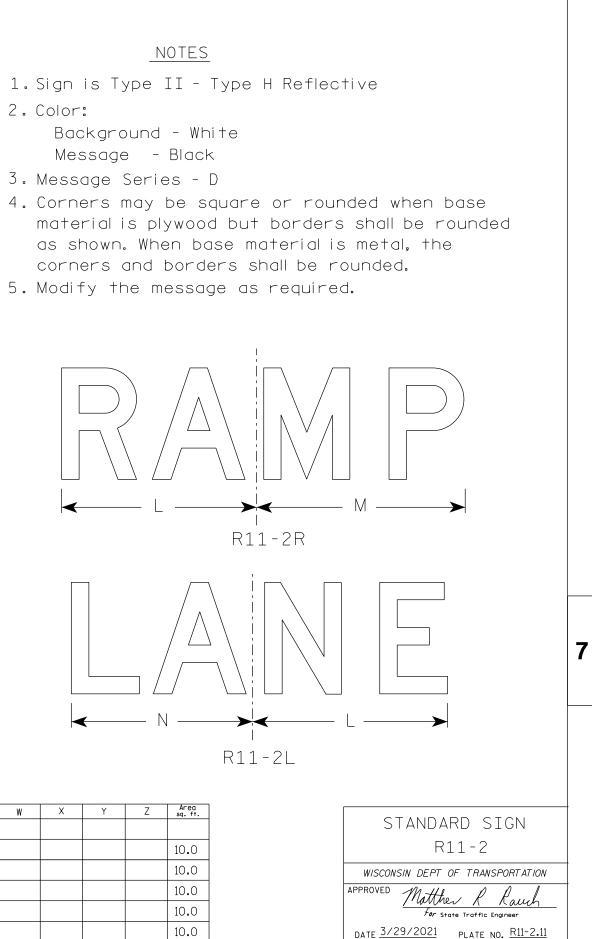

	For sta	ite Traffic Engir	heer	
DATE <u>3/</u>	29/2021	PLATE NO.	<u>R11-2.1</u>	<u>1</u>
	SHEET	NO:		Ε

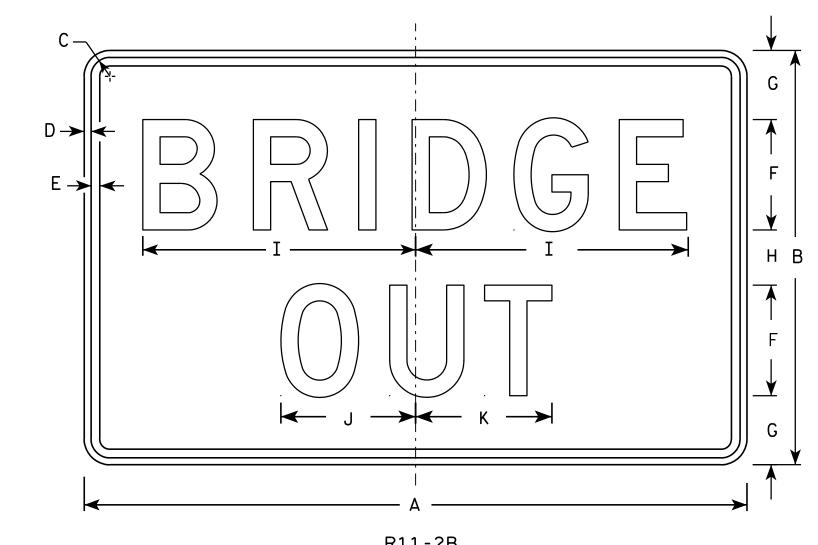

- 2. Color:
  - Background White Message - Black
- 3. Message Series D



SIZE	Α	В	С	D	E	F	G	н	I	J	к	L	M	N	0	Р	0	R	S	T	U	v	W	X	Y	Z	Τ
1																											T
<b>2</b> S	48	30	1 3/8	1/2	5%8	8	5	4	19 3⁄4	9 3⁄4	9 7/8																T
2M	48	30	1 3/8	1/2	5%8	8	5	4	19 3⁄4	9 3/4	9 7/8																T
3	48	30	1 3/8	1/2	5⁄8	8	5	4	19 3⁄4	9 3⁄4	9 7/8																T
4	48	30	1 3/8	1/2	5%8	8	5	4	19 3⁄4	9 3⁄4	9 7/8																T
5	48	30	1 3/8	1/2	5⁄8	8	5	4	19 3⁄4	9 3⁄4	9 7/8																Ī
PRO	JECT	NO:																									_
			PROJECTS	.tr_stdpl	ate\R112	B.DGN										PL0	T DATE :	01-APR-2	2011 14:2	23	PLOT B	í: mscj§	9h				-

## NOTES

1. Sign is Type II - Type H Reflective - reference WIS DOT Standard Specification for HIGHWAY and STRUCTURE CONSTRUCTION latest edition. 4. Corners may be square or rounded when base material is plywood but borders shall be rounded as shown. When base material is metal, the corners and borders shall be rounded.

Areo	
Areo sq. ft.	STANDARD SIGN
10.0	R11-2B
10.0	WISCONSIN DEPT OF TRANSPORTATION
10.0	APPROVED Matthew & Rauch
10.0	
10.0	DATE 4/1/11 PLATE NO. R11-2B.2
	SHEET NO: E


WISDOT/CADDS SHEET 42

# NOTES

- 2. Color:

Background - White Message - Black

- 3. Message Series C

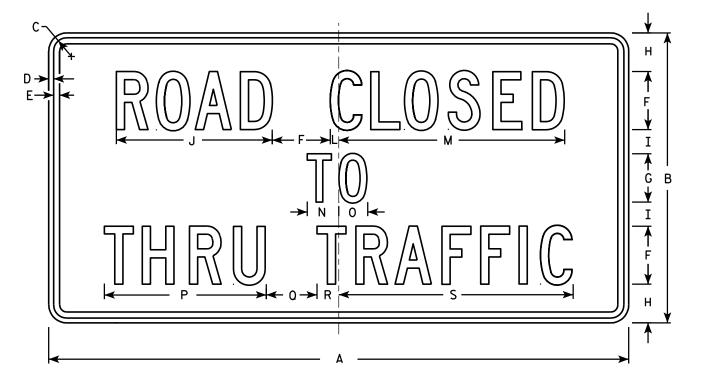

R11-4

SIZE	Α	В	С	D	E	F	G	н	I	J	к	L	M	N	0	P	0	R	S	Т	U	v	W	X	Y	
1																										
2S	60	30	1 3/8	1/2	5%	6	5	4	2 1/2	16 1⁄8		1⁄8	23 ¾	3 1/4	3	16 3⁄4	5 1⁄4	2 1/4	24 ¼							
2M	60	30	1 3/8	1/2	5⁄8	6	5	4	2 1/2	16 1⁄8		1⁄8	23 ¾	3 1⁄4	3	16 3⁄4	5 1⁄4	2 1/4	24 1/4							
3																										
4																										
5																										
PRO	JECT	NO:					н	WY:					COU	NTY:												
FILE N	AME : C:	\Users\P	ROJECTS\1	r_stdplc	te\R114.	DGN										PLOT DA	TE : 01-4	APR-2011	14:11	PLO	T BY : ms	scj9h		PLOT N	AME :	

1. Sign is Type II - Type H Reflective - reference WIS DOT Standard Specification for HIGHWAY and STRUCTURE CONSTRUCTION latest edition.

4. Corners may be square or rounded when base material is plywood but borders shall be rounded as shown. When base material is metal, the corners and borders shall be rounded.

	1	Area								
STANDARD SIGN		sq. ft.	Z							
R11 - 4		12.5								
WISCONSIN DEPT OF TRANSPORTATION	W	12.5								
APPROVED Matthew & Rauch	APPR									
DATE 4/1/11 PLATE NO. R11-4.3	DAT									
SHEET NO: E										
39:1.000000 WISDOT/CADDS SHEET 4	OT SCALE : 9.931739:1.	PLC								

1       24       1 1/8       3/8       1/2       9 3/4       7 7/8       2 7/8       5 1/8       Image: style				1. Sign i 2. Color: Back Mes
	$\begin{array}{c ccccccccccccccccccccccccccccccccccc$	Н I J К L M 7 ½ 2 ½ 5 ½ 9 ½ 3 ½ 6 ¾ 11 ½ 4 ¼ 7 ½	TUV WXY 	Z Arec. sq. ff. 4.0 6.25 9.0 9.0
	4 48 2 1/4 3/4 1 19 3/8 :	$\begin{array}{c ccccccccccccccccccccccccccccccccccc$		9.0


```
NOTES
```

```
is Type II – Type F Reflective
:
ckground – Yellow
```

```
ssage – Black
```



- 2. Color:

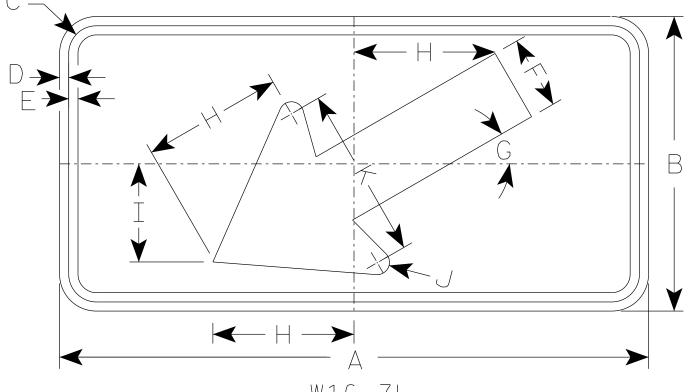

W16-7L

* For 36" x 36" Warning Signs, use 30" x 18" W16-7L signs.
* For 48" x 48" Warning Signs, use 48" x 24" W16-7L signs.

SIZE	А	В	С	D	E	F	G	Н	I	J	К	L	м	N	0	Р	0	R	S	Т	U	V	W	X	
1																									
2S	24	12	1 1/8	3⁄8	3⁄8	3	30°	5 3⁄4	4	1/2	7														
+2M	30	18	1 1/8	3⁄8	1/2	4 1/2	30°	8 ¹ / ₂	6	5⁄8	10 1/4														
<del>×</del> 3	30	18	1 1/8	3⁄8	1/2	4 1/2	30°	8 1/2	6	5⁄8	10 1/4														
* 4	48	24	1 3/8	1/2	5⁄8	6	30°	11 1/2	8	1	14														
5																									
PROJEC	T NO:					ł	⊣WY:					COL	INTY:												
FILE NAME :	C:\CAEfi	les\Proj	ects\tr_s	tdplate\	W16 <b>7.</b> dgn										PLOT DA	TE : 16-	MAR-2021	3:53	PLOT	T BY : do	tc4c		PLOT NA	ME :	

# NOTES


1. Sign is Type II - Type F Reflective

Background - Yellow Message – Black

3. W16-7R is the same as W16-7L

except the arrow is reversed along the vertical centerline.

Y Z Area sq. ft.	STANDARD SIGN
2.0	W16-7
3.75	WISCONSIN DEPT OF TRANSPORTATION
3.75	APPROVED Matther R Rauch
8.0	For State Traffic Engineer
	DATE <u>3/16/2021</u> PLATE NO. <u>W16-7.8</u>
	SHEET NO: E

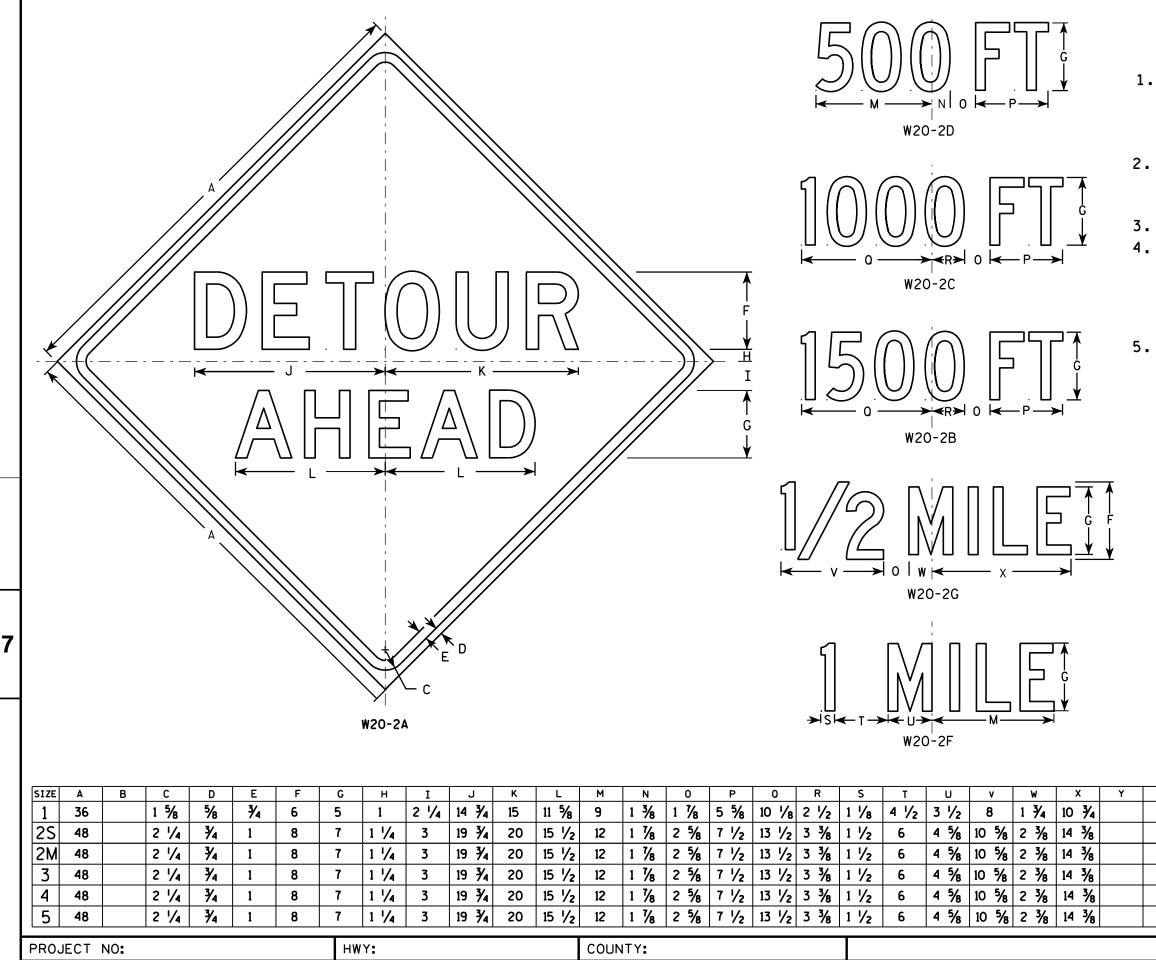

FILE NAME : C:\Users\PROJECTS\tr_stdplate\W202.DGN

PLOT DATE : 18-MAR-2011 10:00

PLOT NAME :

PLOT BY : mscj9h


### NOTES

 Sign is Type II - Type F Reflective reference WIS DOT Standard Specification for HIGHWAY and STRUCTURE CONSTRUCTION latest edition.
 Color: Background - Orange

Message – Black

 Message Series - See note 5
 Corners may be square or rounded when base material is plywood but borders shall be rounded as shown. When base material is metal, the corners and borders shall be rounded.
 Line 1 is Series D. Line 2 is Series D for AHEAD and Series C for all other distances.

7	Area	l				
Z	<u>sq. 11.</u> 9.0					
			5	IANDA	RD SIGN	
	16.0		W20	-2A.B.	C.D.F &	G
	16.0			•		
	16.0			NSIN DEPT	OF TRANSPORTATIO	W
	16.0		APPROVED	Math	er R Rau	L
	10.0			-		<u>~</u>
	16.0		DATE 3	/18/11	PLATE NO. <u>W20-2</u>	.6
						_
				SHEET	NO:	E
	PLO	DT SCALE : 9.93173	9:1.000000	) wisc	OT/CADDS SHEE	T 42

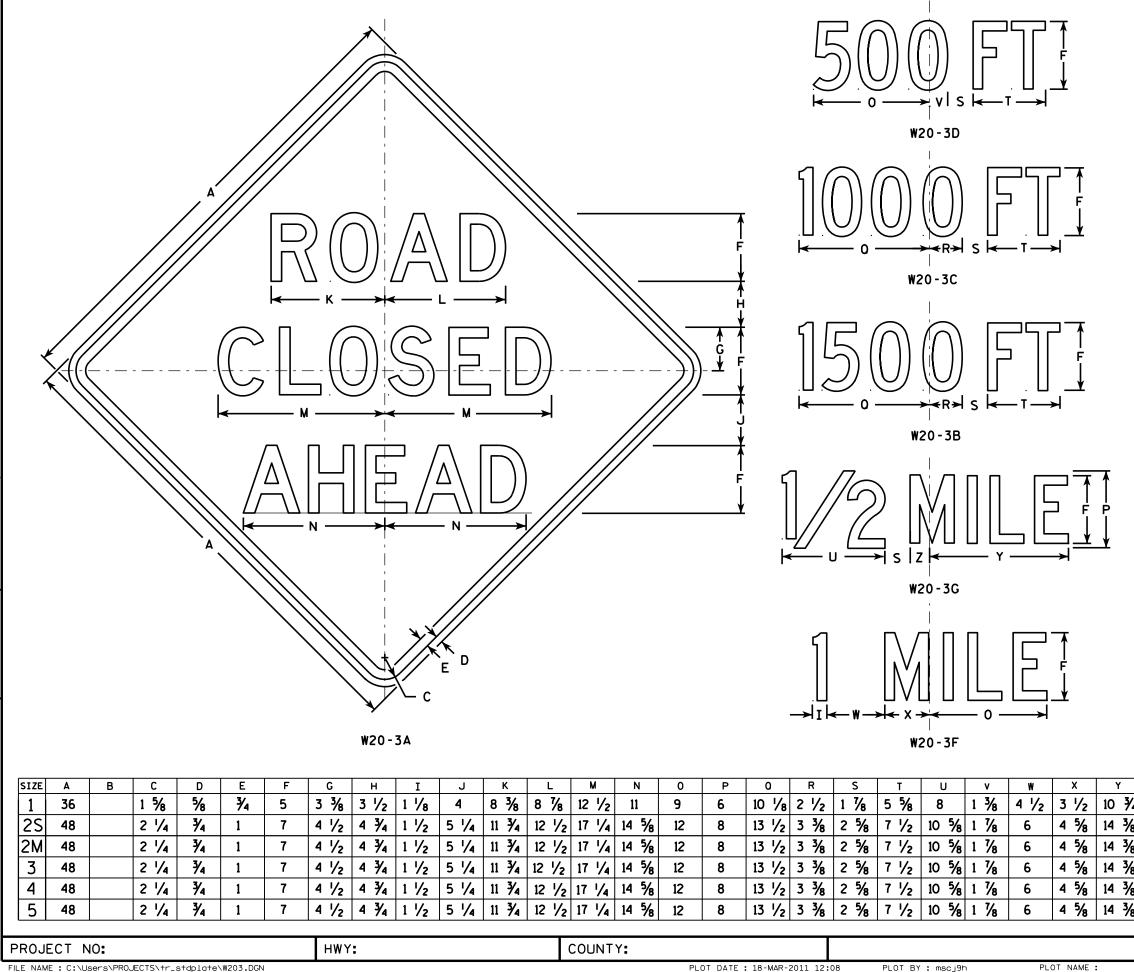

FILE NAME : C:\Users\PROJECTS\tr_stdplate\W203.DGN


7


PLOT DATE : 18-MAR-2011 12:08

#### NOTES

- 1. Sign is Type II Type F Reflective reference WIS DOT Standard Specification for HIGHWAY and STRUCTURE CONSTRUCTION latest edition.
- 2. Color: Background - Orange Message - Black
- 3. Message Series see note 5
- 4. Corners may be square or rounded when base material is plywood but borders shall be rounded as shown. When base material is metal, the corners and borders shall be rounded.
- 5. Lines 1 and 2 are Series D. Line 3 is Series D for AHEAD and Series C for all other distances.


	Z	Areo sq. ft.			
4	1 3⁄4	9.0		<u>ر</u>	TANDARD SIGN
3	2 3/8	16.0			
,	2 3/8	16.0		W20-	·3A, B, C, D, F & G
,	2 3/8	16.0			ISIN DEPT OF TRANSPORTATION
3	2 3/8	16.0		APPROVED	Matther R Rauch
3	2 3/8	16.0	]	DATE <u>3/1</u>	For State Traffic Engineer 8/11 PLATE NO. <u>W20-3.7</u>
					SHEET NO: E
		PLOT S	SCALE : 9.931739	9:1.000000	WISDOT/CADDS SHEET 42

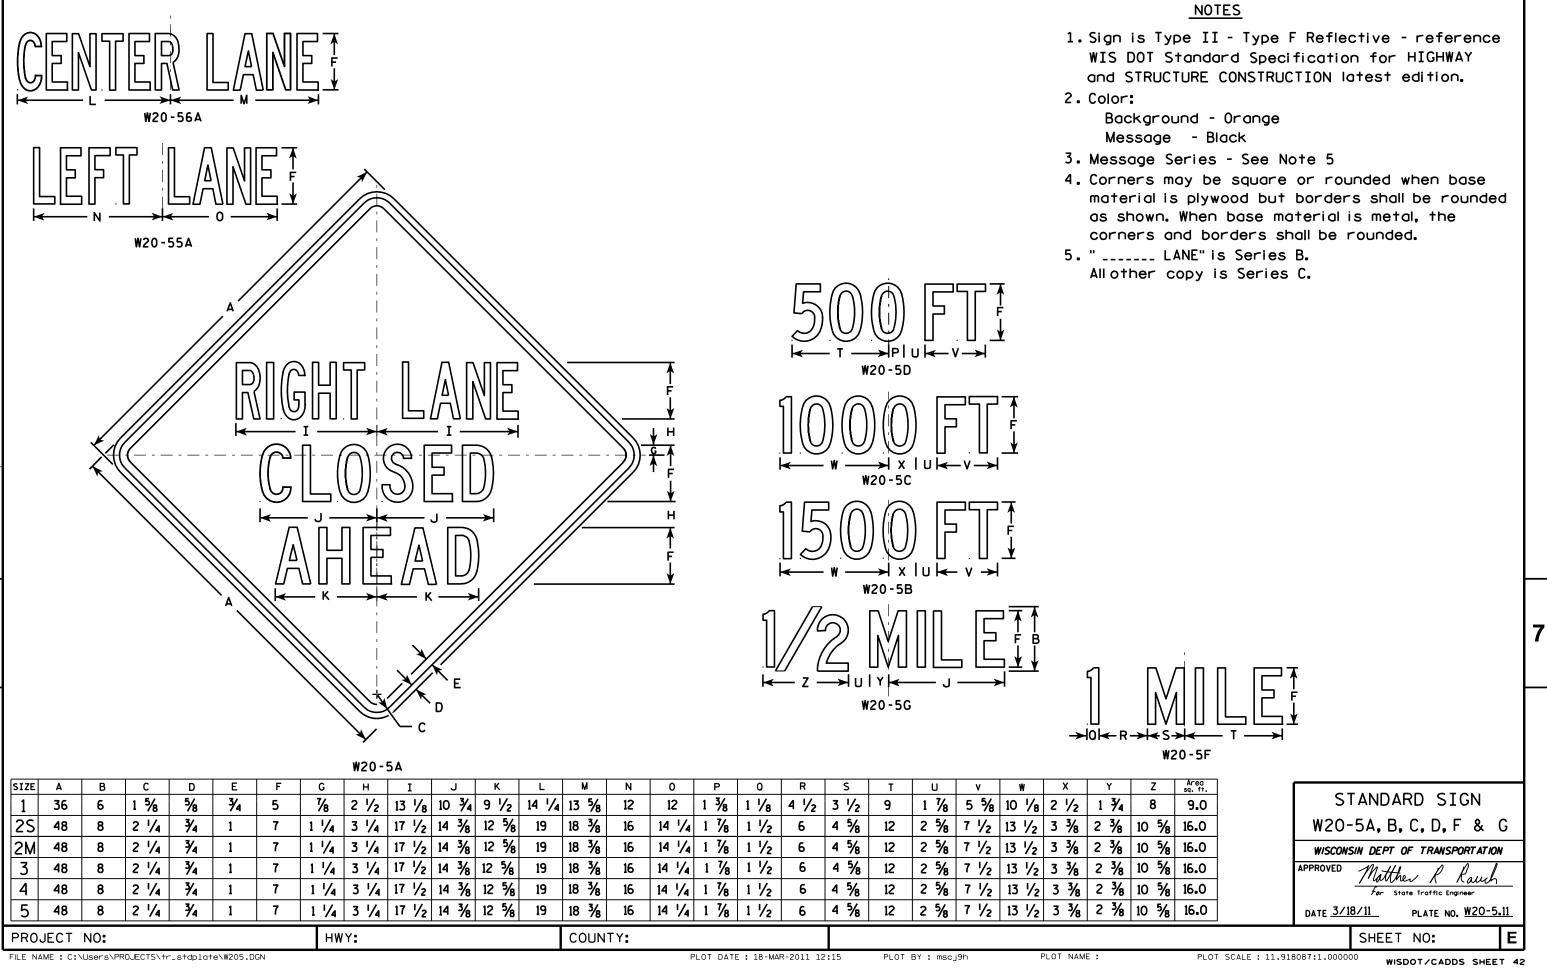

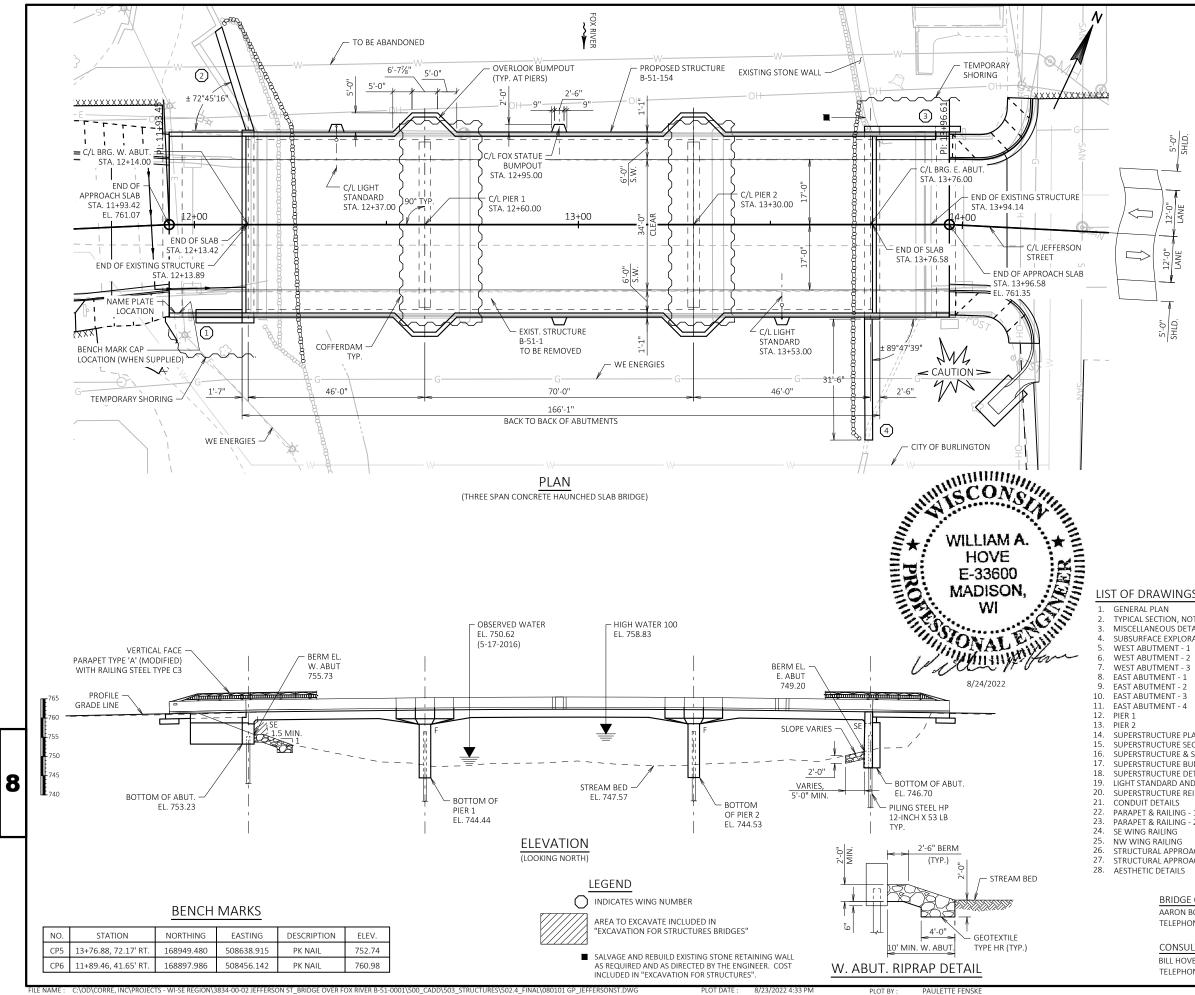

3834-00-72

1
3
3
BY
22
ву 22
22
22
22
22
22
22
22
22

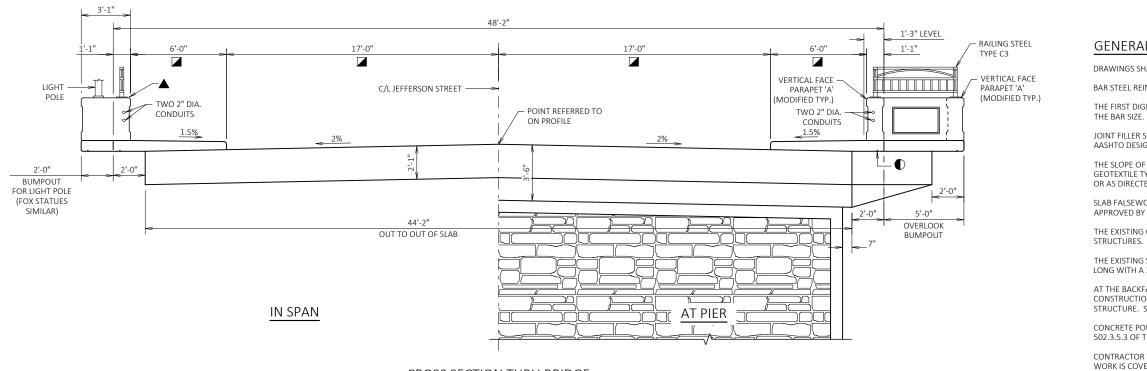

#### CROSS SECTION THRU BRIDGE (LOOKING EAST)

#### TOTAL ESTIMATED QUANTITIES

BID NUMBER	BID ITEM	UNIT	WEST APPR. SLAB	WEST ABUT.	PIER 1	PIER 2	EAST ABUT.	EAST APPR. SLAB	SUPER	TOTALS
203.0260	REMOVING STRUCTURE OVER WATERWAY MINIMAL DEBRIS B-51-1	EACH								1
206.1001	EXCAVATION FOR STRUCTURES BRIDGES B-51-154	EACH								1
206.5001	COFFERDAMS B-51-154	EACH								2
210.1500	BACKFILL STRUCTURE TYPE A	TON		130			500			630
305.0120	BASE AGGREGATE DENSE 1 1/4-INCH	TON	155					155		310
502.0100	CONCRETE MASONRY BRIDGES	CY	71.2	61.6	65.5	65.5	146.4	71.2	746.6	1,228
502.3200	PROTECTIVE SURFACE TREATMENT	SY	100					100	810	1,010
502.3210	PIGMENTED SURFACE SEALER	SY	5					5	45	55
502.9000.S	UNDERWATER SUBSTRUCTURE INSPECTION B-51-154	EACH			1	1				2
505.0400	BAR STEEL REINFORCEMENT HS STRUCTURES	LB		3,300	2,620	2,620	6,270			14,810
505.0600	BAR STEEL REINFORCEMENT HS COATED STRUCTURES	LB	11,475	2,420	90	90	4,580	11,475	130,310	137,49
505.0800.S	BAR STEEL REINFORCEMENT HS STAINLESS STRUCTURES	LB	225					225		450
511.1200	TEMPORARY SHORING B-51-154	SF		150			450			600
513.7016	RAILING STEEL TYPE C3	LF	37					37	338	412
513.8016	RAILING STEEL PEDESTRIAN TYPE C3	LF					29			29
516.0500	RUBBERIZED MEMBRANE WATERPROOFING	SY		12			12			24
517.1010.S	CONCRETE STAINING B-51-154	SF	240	80	180	180	90	240	2,070	3,080
517.1015.S	CONCRETE STAINING MULTI-COLOR B-51-154	SF		290	840	840	1,080			3,050
517.1050.S	ARCHITECTURAL SURFACE TREATMENT B-51-154	SF		290	840	840	1,080			3,050
531.8990	ANCHOR ASSEMBLIES POLES ON STRUCTURES	EACH							2	2
550.0010	PREBORING UNCONSOLIDATED MATERIALS	LF		245	182	182	442			1,051
550.0020	PREBORING ROCK OR CONSOLIDATED MATERIALS	LF		105	65	65	130			365
550.1120	PILING STEEL HP 12-INCH X 53 LB	LF		420	390	390	780			1,980
606.0300	RIPRAP HEAVY	CY		80			40			120
612.0406	PIPE UNDERDRAIN WRAPPED 6-INCH	LF		125			125			250
645.0111	GEOTEXTILE TYPE DF SCHEDULE A	SY		85			95			180
645.0120	GEOTEXTILE TYPE HR	SY		160			100			260
652.0125	CONDUIT RIGID METALLIC 2-INCH	LF	5					5	40	50
652.0225	CONDUIT RIGID NON-METALLIC SCHEDULE 40 2-INCH	LF	100					100	670	870
653.0222	JUNCTION BOXES 18x12x6-INCH	EACH							2	2
SPV.0090.03	NW WINGWALL DECORATIVE RAILING	LF		27						27
	NON-BID ITEMS									
	FILLER	SIZE								1/2", 3/4", 1

C:\OD\CORRE, INC\PROJECTS - WI-SE REGION\3834-00-02 JEFFERSON ST BRIDGE OVER FOX RIVER B-51-0001\500 CADD\503 STRUCTURES\502.4 FINAL\080201 CS JEFFERSONST.DWG

JOINT FILLER SHALL CONFORM TO THE REQUIREMENTS OF AASHTO DESIGNATION M153 TYPE I, II OR III OR AASHTO DESIGNATION M213.

THE SLOPE OF THE FILL IN FRONT OF THE ABUTMENTS SHALL BE COVERED WITH RIPRAP HEAVY AND GEOTEXTILE TYPE HR TO THE EXTENT SHOWN ON THE GENERAL PLAN SHEET AND IN THE ABUTMENT DETAILS, OR AS DIRECTED BY THE ENGINEER.

SLAB FALSEWORK SHALL BE SUPPORTED ON PILES OR THE SUBSTRUCTURE UNLESS AN ALTERNATE METHOD IS APPROVED BY THE ENGINEER.

THE EXISTING GROUND LINE OR THE STREAM BED SHALL BE THE UPPER LIMIT FOR EXCAVATION FOR STRUCTURES.

THE EXISTING STRUCTURE B-51-1, TO BE REMOVED, IS A THREE SPAN STEEL DECK GIRDER BRIDGE, 180.25 FT. LONG WITH A 34.0 FT. CLEAR ROADWAY WIDTH.

AT THE BACKFACE OF ABUTMENT ALL VOLUME WHICH CANNOT BE PLACED BEFORE ABUTMENT CONSTRUCTION AND IS NOT OCCUPIED BY THE NEW STRUCTURE SHALL BE BACKFILLED WITH BACKFILL STRUCTURE. SEE MISCELLANEOUS DETAILS SHEET FOR ADDITIONAL INFORMATION.

CONCRETE POURED UNDER WATER WILL BE ALLOWED AND SHALL BE DONE IN ACCORDANCE WITH SECTION 502.3.5.3 OF THE STANDARD SPECIFICATIONS.

CONTRACTOR TO REMOVE AND SALVAGE STREAM GAUGE STATION EQUIPMENT FOR THE CITY TO PICK-UP. WORK IS COVERED UNDER THE "REMOVING STRUCTURE OVER WATERWAY" BID ITEM.

#### LEGEND

8

PLOT DATE 8/23/2022 4:34 PN PLOT BY PAULETTE FENSKE STATE PROJECT NUMBER

3834-00-72

### **GENERAL NOTES**

DRAWINGS SHALL NOT BE SCALED.

BAR STEEL REINFORCEMENT SHALL BE EMBEDDED 2" CLEAR UNLESS SHOWN OR NOTED OTHERWISE.

THE FIRST DIGIT OF A THREE DIGIT BAR NO. AND THE FIRST TWO DIGITS OF A FOUR DIGIT BAR NO. SIGNIFIES

● 3/4" V-GROOVE. TERMINATE 6" FROM FRONT FACE OF ABUTMENTS.


COAT WITH "PROTECTIVE SURFACE TREATMENT" PER THE STANDARD SPECIFICATIONS.


COAT TOP OF PARAPETS WITH "PIGMENTED SURFACE SEALER" PER THE STANDARD SPECIFICATIONS. FRONT AND BACK OF PARAPETS TO BE STAINED.


 QUANTITY INCLUDES PREBORING THROUGH EXISTING FOUNDATION, THAT IS NOT IN
 CONFLICT WITH THE ABUTMENT LIMITS, BUT WHEN IN CONFLICT WITH PLACEMENT OF PROPOSED PILING. ALTERNATIVELY, CONTRACTOR MAY COMPLETELY REMOVE FOUNDATION. COST OF REMOVAL IS INCLUDED IN "REMOVING STRUCTURE" ITEM.

ITEM INCLUDES PARTIAL REMOVAL OF EXISTING RETAINING WALLS AS REQUIRED TO CONSTRUCT NEW STRUCTURE

							8
	NO.	DATE	RE	VISION		BY	
	STATE OF WISCONSIN DEPARTMENT OF TRANSPORTATION						
			STRUCTU	RE B-5:	1-154		1
			D	BY PKF	PLANS CK'D.	BH	
ORIGINAL PLAN PREPARED BY		ΤΥΡΙ	CAL SECTI	ON,	SHEET 2	OF 28	
	N	OTES	S & QUAN	<b>FITIES</b>			

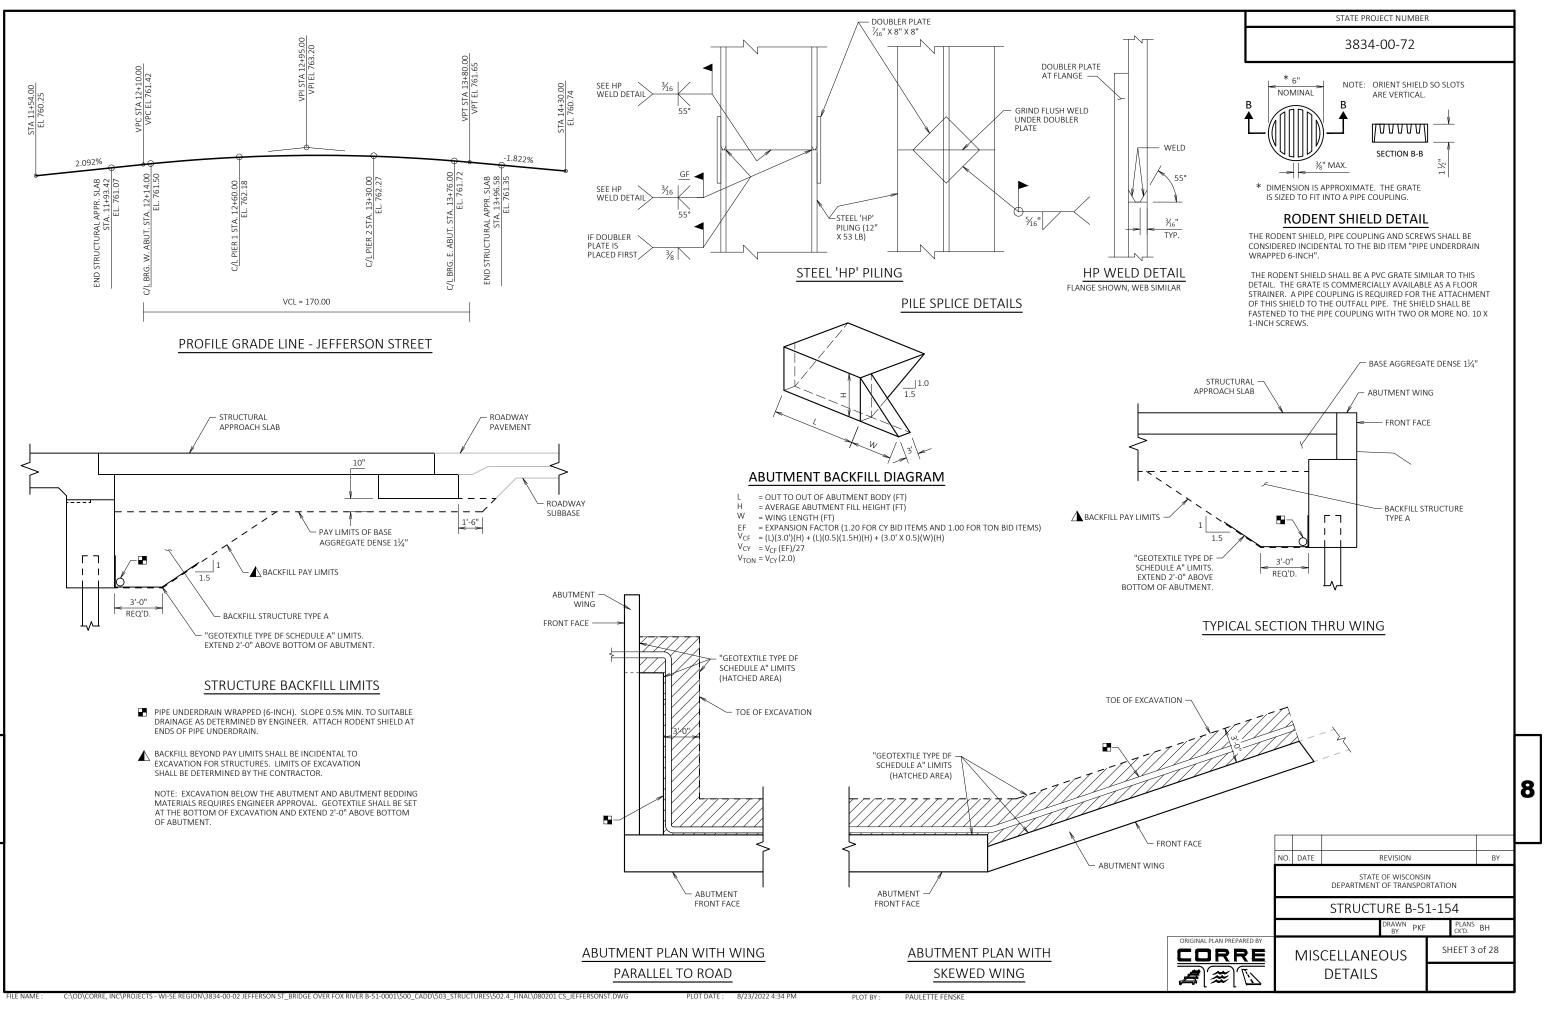


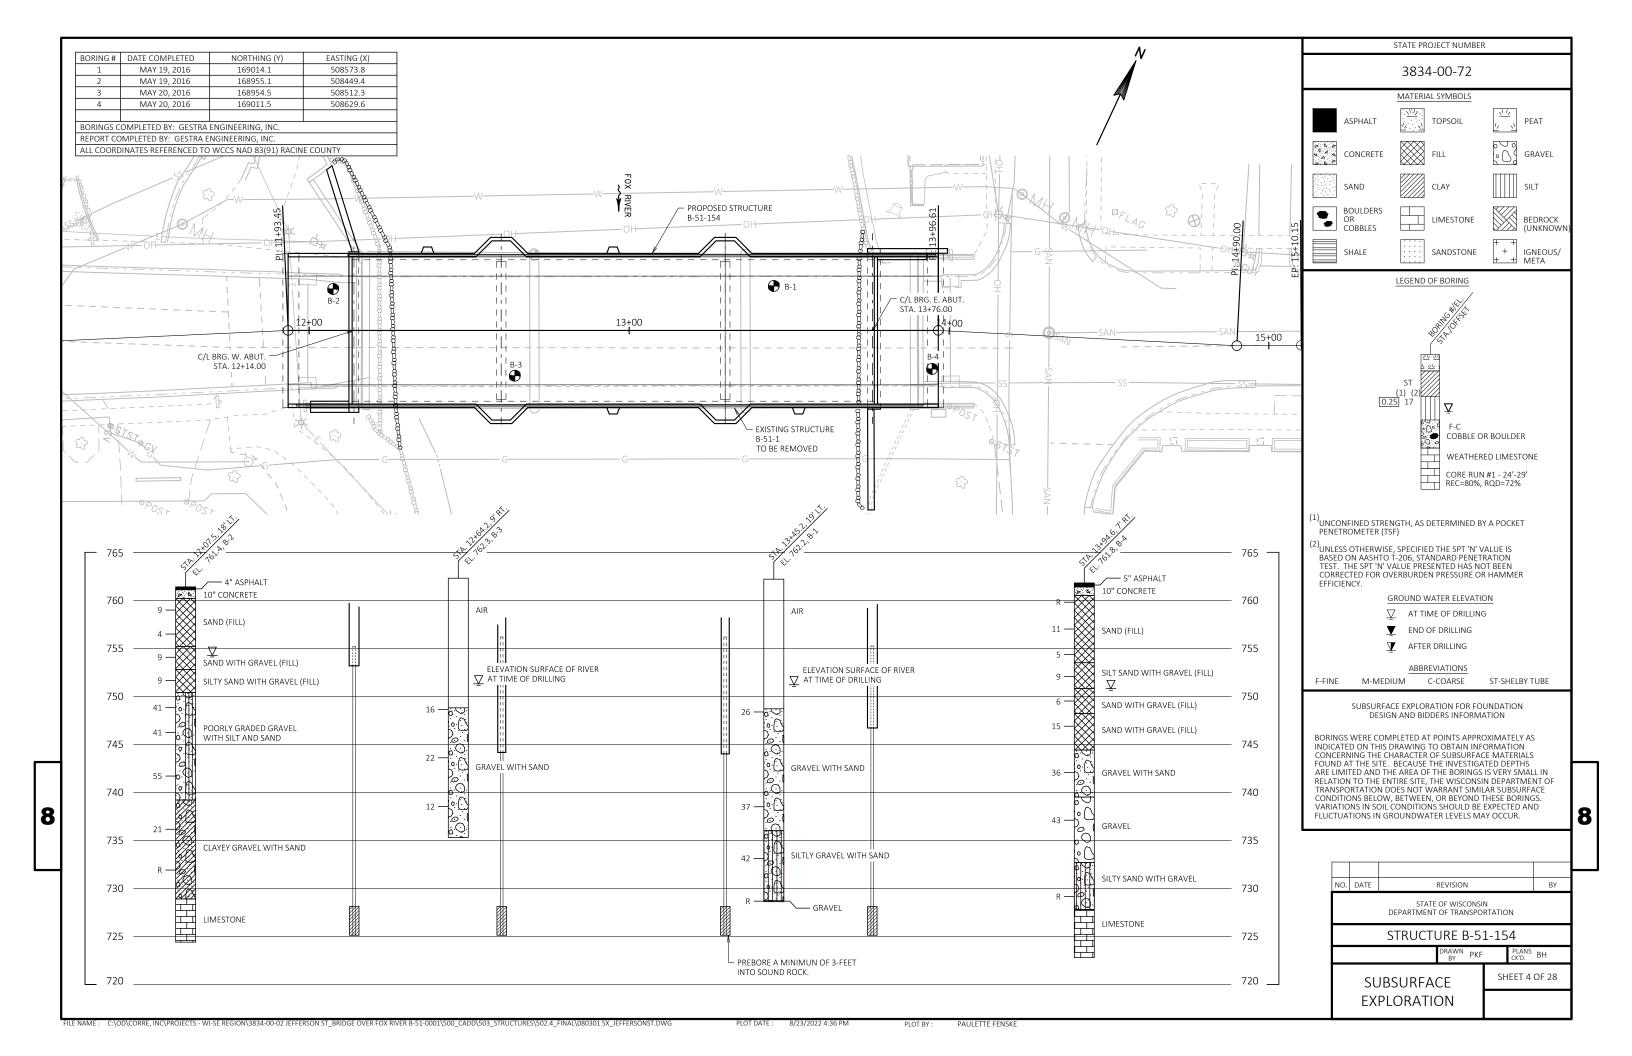


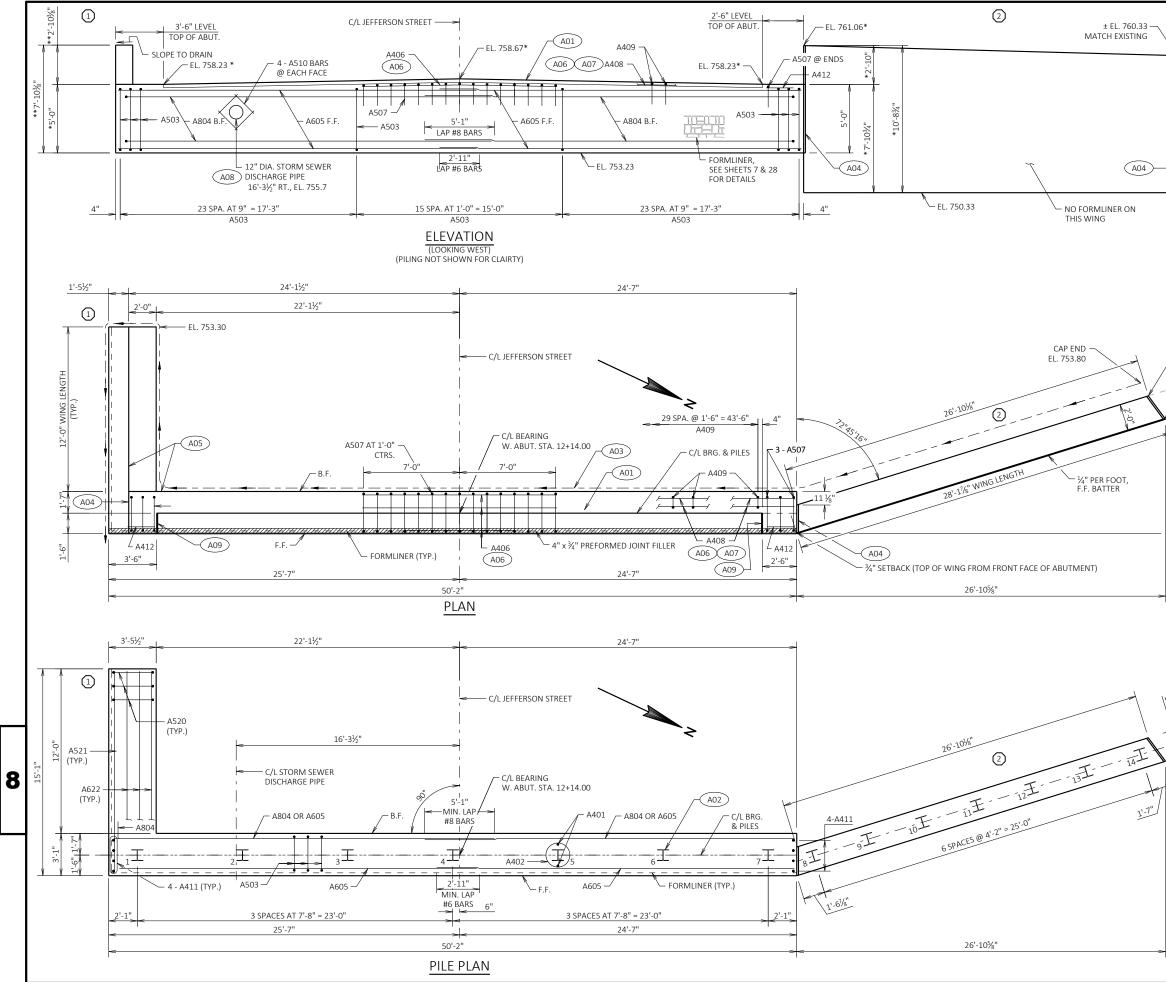

FILE NAME : C:\OD\CORRE, INC\PROJECTS - WI-SE REGION\3834-00-02 JEFFERSON ST_BRIDGE OVER FOX RIVER B-51-0001\500_CADD\503_STRUCTURES\502.4_FINAL\080402_ABTS_JEFFERSONST.DWG

	STATE PROJECT NUMBER
	3834-00-72
	LEGEND * THE ELEVATIONS OR DIMENSIONS ARE GIVEN AT THE TOP OF CONCRETE AT THE C/L OF BEARING.
± 10'-0"	** DIMENSIONS ARE GIVEN AT THE F.F. OF ABUTMENT AT THE BACK OF WING. FOR WING DETAILS AND ELEVATIONS SEE SHEET 6.
	O INDICATES WING NUMBER
	A01 STEEL TROWEL TOP SURFACE OF ABUTMENT. PLACE MULTIPLE LAYERS OF POLYETHYLENE SHEETS OVER ENTIRE ABUTMENT TOP BEFORE PLACING SUPERSTRUCTURE. TOTAL THICKNESS OF SHEETS SHALL BE AT LEAST 0.03".
	A02 SUPPORT ABUTMENT ON PILING STEEL HP 12-INCH x 53 LB, PREBORED A MINIMUM OF 3' INTO BEDROCK. ESTIMATED 30' LONG. PILES PLACED IN PREBORED HOLES BORED INTO ROCK DO NOT REQUIRE DRIVING. PILING SHALL BE FIRMLY SEATED AFTER PLACEMENT.
	(A03) PIPE UNDERDRAIN WRAPPED 6-INCH. SLOPE 0.5% MIN. TO SUITABLE DRAINAGE. ATTACH RODENT SCREEN AT ENDS OF PIPE UNDERDRAIN. RODENT SHIELD TO BE INCLUDED IN BID PRICE OF "PIPE UNDERDRAIN WRAPPED 6-INCH".
- A04 - ¾" SETBACK (TOP OF PROPOSED WALL FROM FACE OF EXIST	NON-BITUMINOUS JOINT SEALER. (1" DEEP AND HOLD
	(A05) 18" RUBBERIZED MEMBRANE WATERPROOFING. SEAL ALL HORIZONTAL AND VERTICAL JOINTS ON BACKFACE.
EXIST. WALL	A06 FIELD BEND TO FOLLOW SLOPE OF TOP OF ABUTMENT.
FRONT FACE OF EXISTING	A07 LAP BARS 1'-11" MIN., 2 LAPS PER ROW.
WALL (PARTIAL       F     REMOVAL OF WALL       REQUIRED)	A08 DISPLACE HORIZONTAL STEEL TO AVOID PIPE AS DIRECTED BY ENGINEER.
+I REQUIRED)	(A09) ¾" CORK FILLER ON VERTICAL FACES PARALLEL TO SLAB EDGE.
<u>↓</u>	B.F. DENOTES BACK FACE F.F. DENOTES FRONT FACE
	NOTES DO NOT PLACE FILL MORE THAN 3'-0' FROM BOTTOM OF ABUTMENT UNTIL SUPERSTRUCTURE IS IN PLACE.
· 	-
C/L PILES	
	NO. DATE REVISION BY STATE OF WISCONSIN DEPARTMENT OF TRANSPORTATION
	STRUCTURE B-51-154
	DRAWN PKF PLANS BH CK/D. BH
ORIGINAL PLAN PREPARED BY	WEST SHEET 5 OF 28
	ABUTMENT - 1

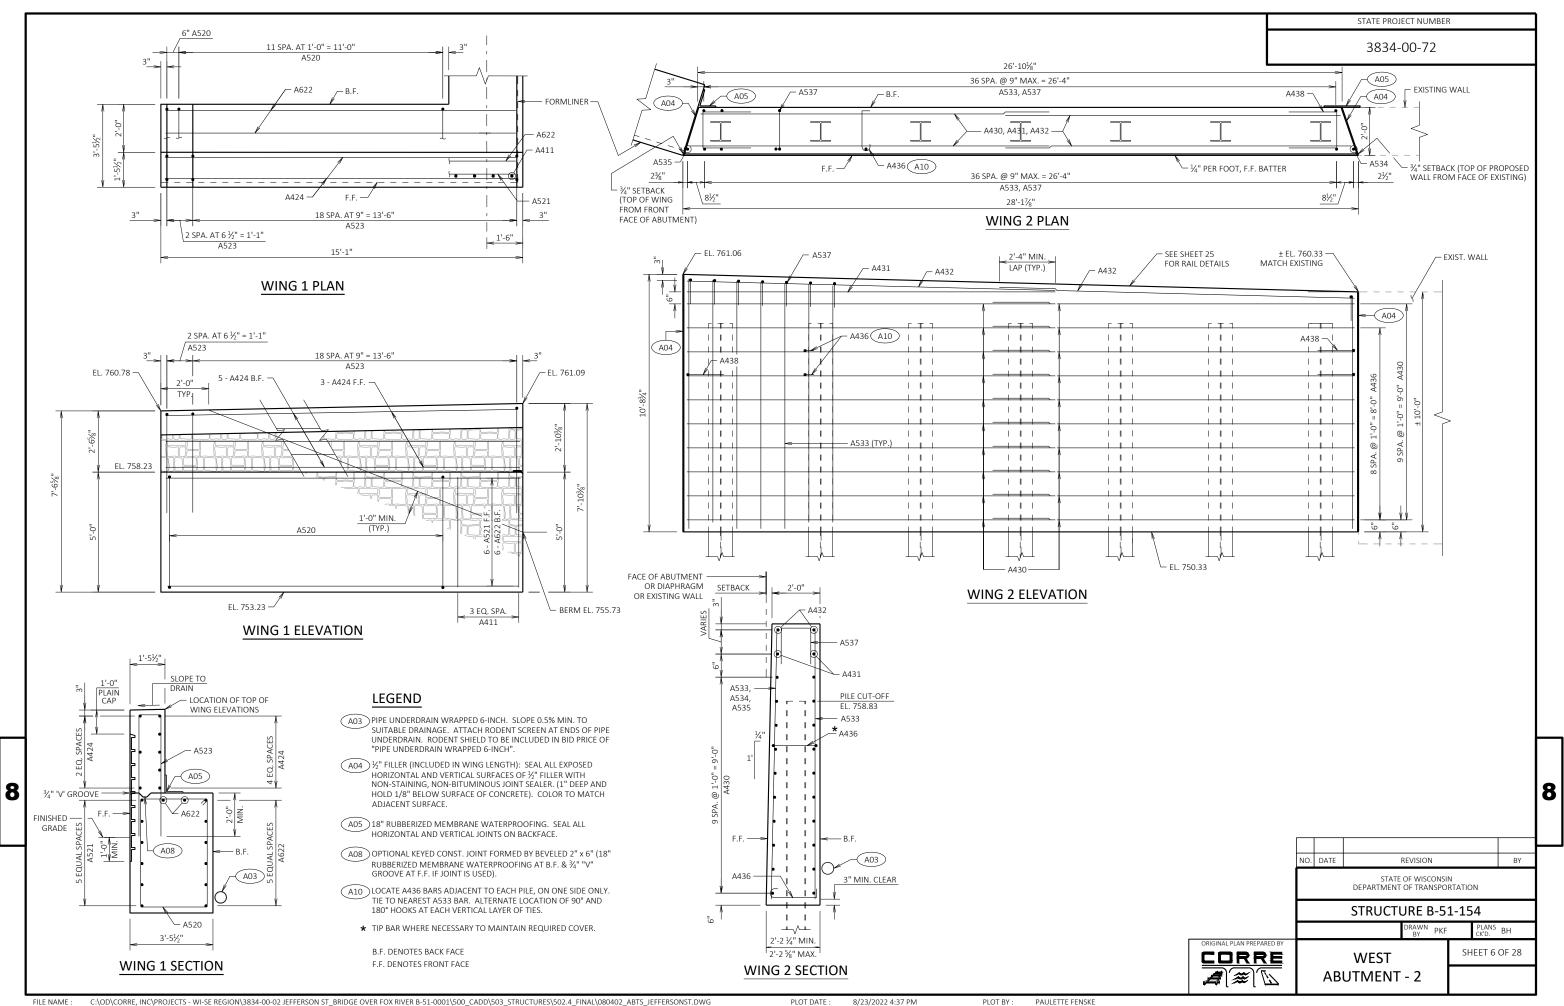

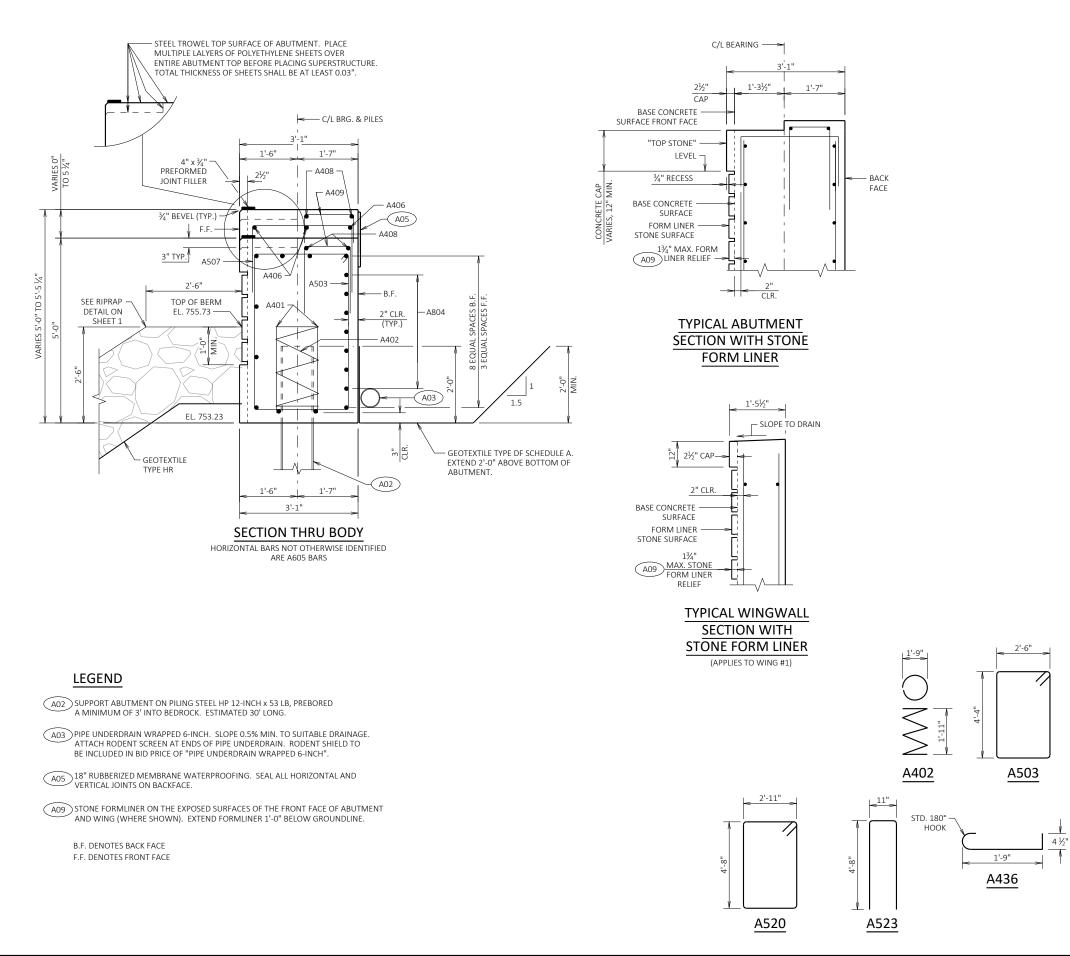

#### FILE NAME : C:\OD\CORRE, INC\PROJECTS - WI-SE REGION\3834-00-02 JEFFERSON ST_BRIDGE OVER FOX RIVER B-51-0001\500_CADD\503_STRUCTURES\502.4_FINAL\080402_ABTS_JEFFERSONST.DWG

8

PLOT DATE : 8/23/2022 4:37 PM

PAULETTE FENSKE PLOT BY :

### **BILL OF BARS - WEST ABUTMENT**

NON-COA A401 A402 A503 A804 A605 A406 A507 A408 A409 A510 A411 A412 COATED E A520 A521 A622 A523 A424 A430 A431 A432 A533 A534 A535

BAR MARK

A436

A537

A438

BAR MARK A533

STATE PROJECT NUMBER

3834-00-72

NO. REQ'D	LENGTH	BENT	BAR SERIES	LOCATION					
TED BARS TOTAL WEIGHT = 3,300 LBS									
14	2'-3"			BODY @ PILING	VERT.				
7	28'-0"	Х		BODY @ PILING	VERT.				
62	14'-4"	Х		BODY - STIRRUPS	VERT.				
14	28'-8"	Х		BODY - B.F.	HORIZ.				
20	26'-5"			BODY - F.F., TOP, & BTM.	HORIZ.				
3	14'-3"			BODY - TOP	HORIZ.				
21	5'-3"	Х		BODY - TOP	VERT.				
6	18'-0"			BODY - TOP @ NOTCH	HORIZ.				
30	4'-7"	Х		BODY - TOP @ NOTCH	VERT.				
8	2'-0"			BODY @ STORM SEWER	VERT.				
8	4'-7"			ABUTMENT ENDS	VERT.				
2	2'-0"			ABUTMENT ENDS	HORIZ.				
BARS				TOTAL WEIGHT =	2,420 LBS				
13	15'-10"	Х		WING 1 - BOTTOM, STIRRUPS	VERT.				
6	14'-6"			WING 1 - BOTTOM, F.F.	HORIZ.				
8	14'-6"			WING 1 - BOTTOM, B.F., & TOP	HORIZ.				
21	10'-0"	Х		WING 1 - TOP	VERT.				
8	14'-6"			WING 1 - TOP	HORIZ.				
40	15'-1"			WING 2 - F.F. & B.F.	HORIZ.				
2	21'-6"			WING 2 - F.F. & B.F.	HORIZ.				
4	15'-2"			WING 2 - F.F. & B.F.	HORIZ.				
74	9'-11"		Х	WING 2 - F.F. & B.F.	VERT.				
1	9'-7"			WING 2 - F.F.	VERT.				
1	10'-4"			WING 2 - F.F.	VERT.				
63	2'-7"	х		WING 2 - ADJACENT TO PILING	HORIZ.				
37	5'-5"	Х		WING 2 - TOP	VERT.				
23	4'-6"	х		WING 2 - SIDES	VERT.				

THE FIRST DIGIT OR FIRST TWO DIGITS OF THE BAR MARK SIGNIFIES THE BAR SIZE.


DIMENSIONS IN BENDING DETAILS ARE OUT-TO-OUT OF BAR.


LENGTH SHOWN FOR BAR SERIES IS AN AVERAGE. SEE BAR SERIES TABLE FOR ACTUAL LENGHTS.

### **BAR SERIES TABLE**


NO. REQ'D.	LENGTH
2 SERIES OF 37	9'-7" TO 10'-3"


BUNDLE AND TAG EACH SERIES SEPARATELY.

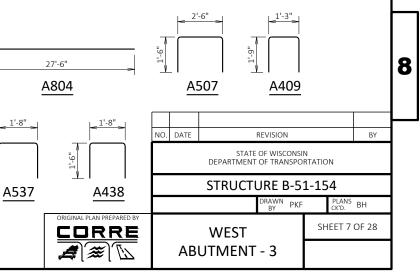

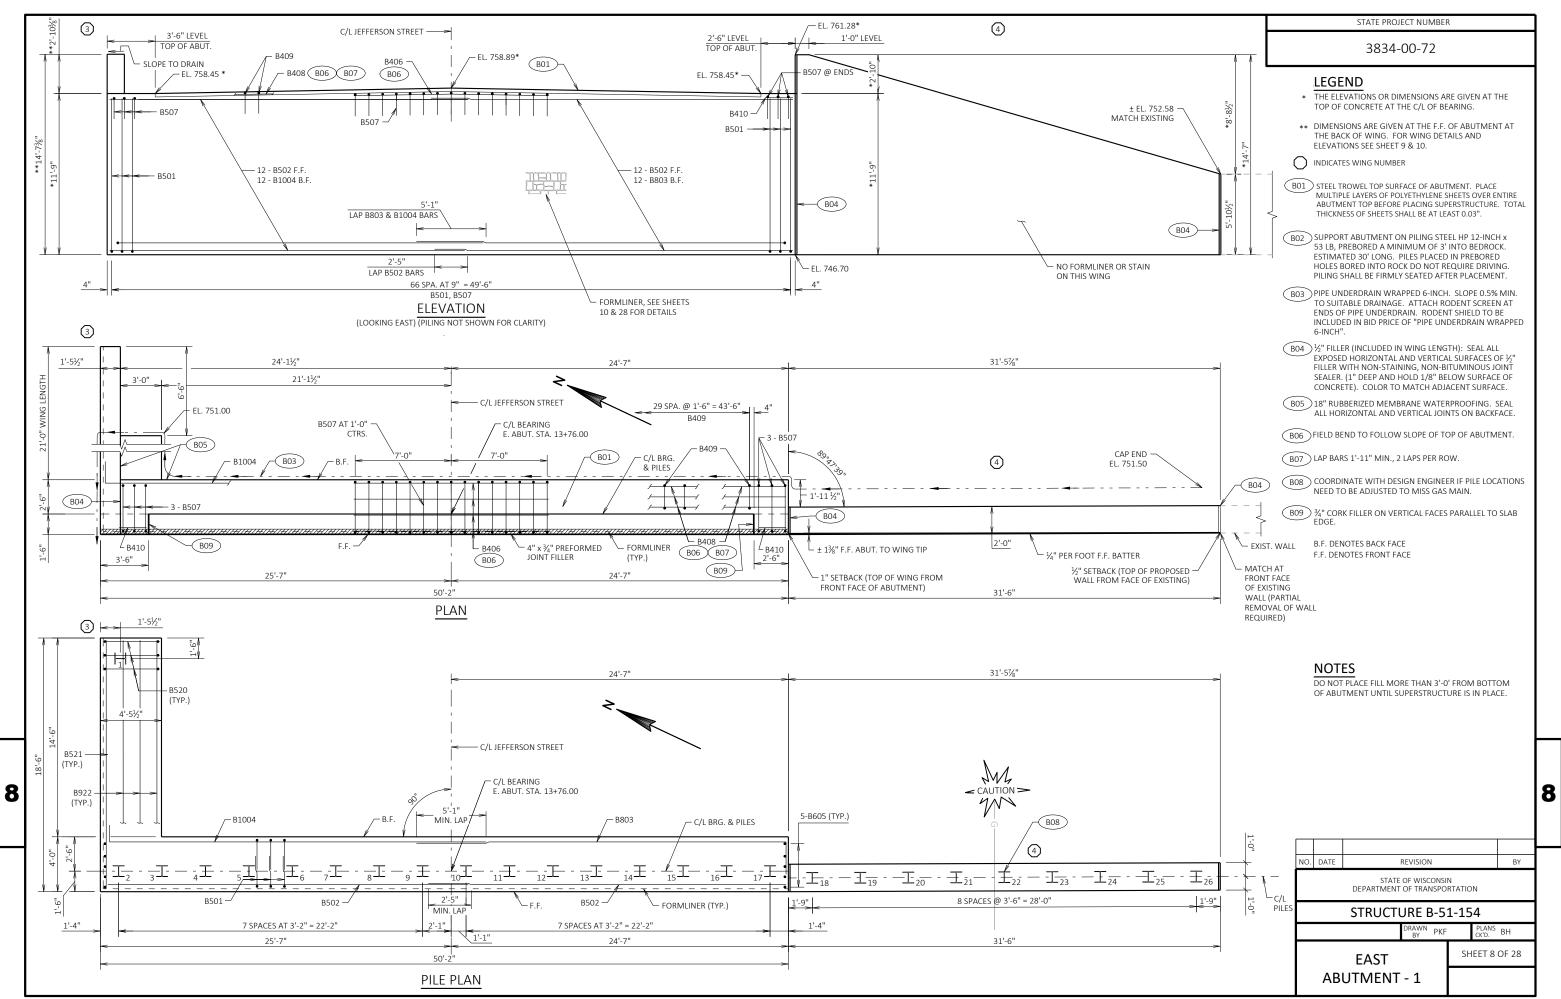



FILE NAME : C:\OD\CORRE, INC\PROJECTS - WI-SE REGION\3834-00-02 JEFFERSON ST_BRIDGE OVER FOX RIVER B-51-0001\500_CADD\503_STRUCTURES\502.4_FINAL\080402_ABTS_IEFFERSONST.DWG

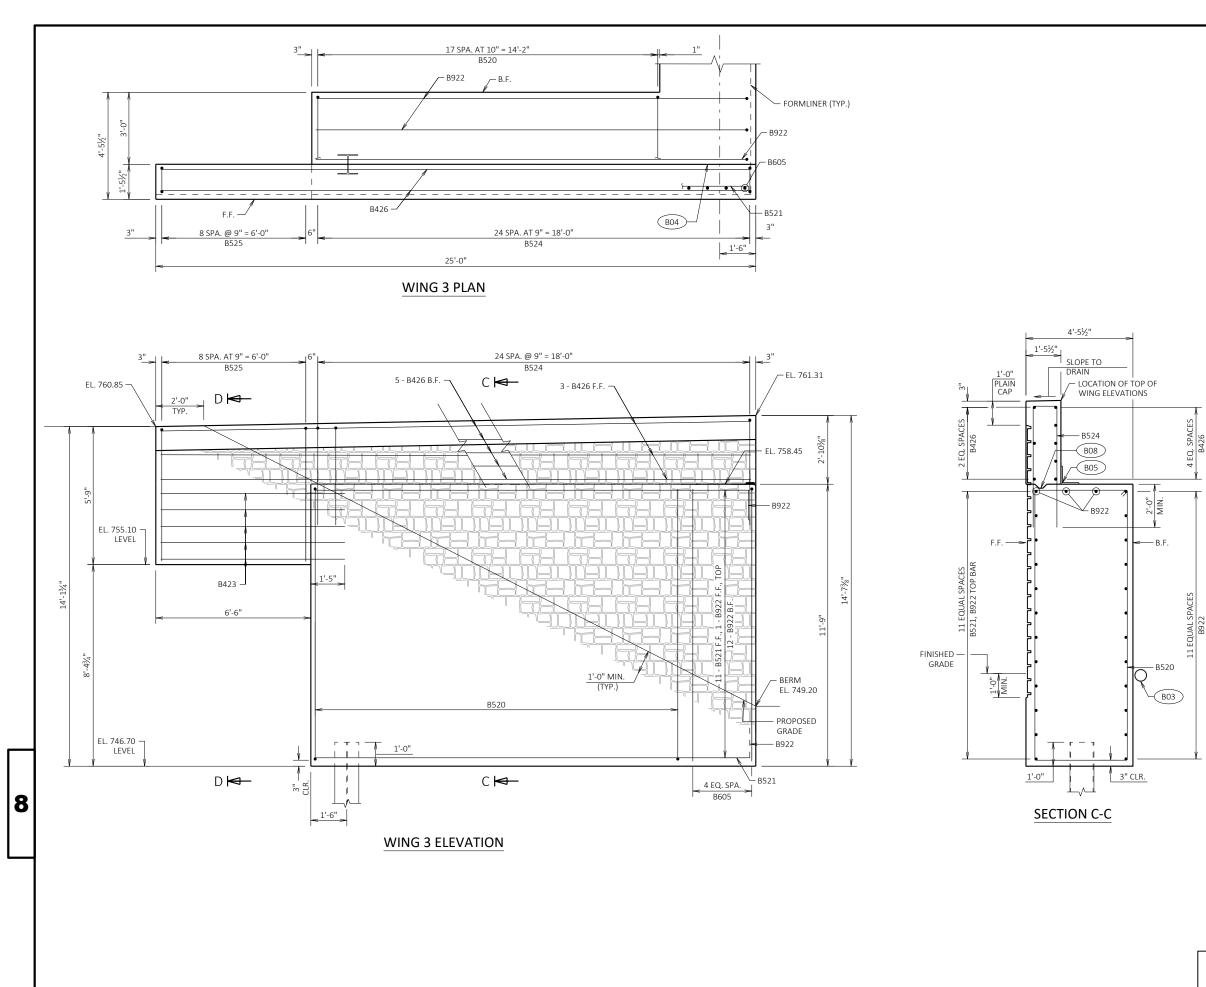

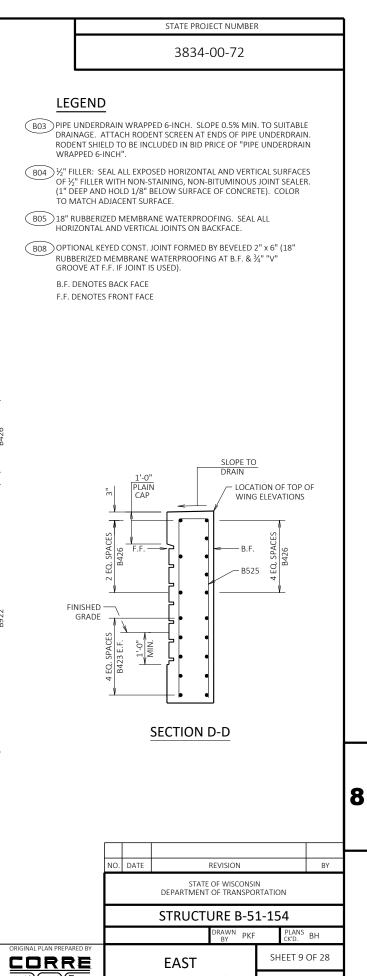

ABUTMENT - 2

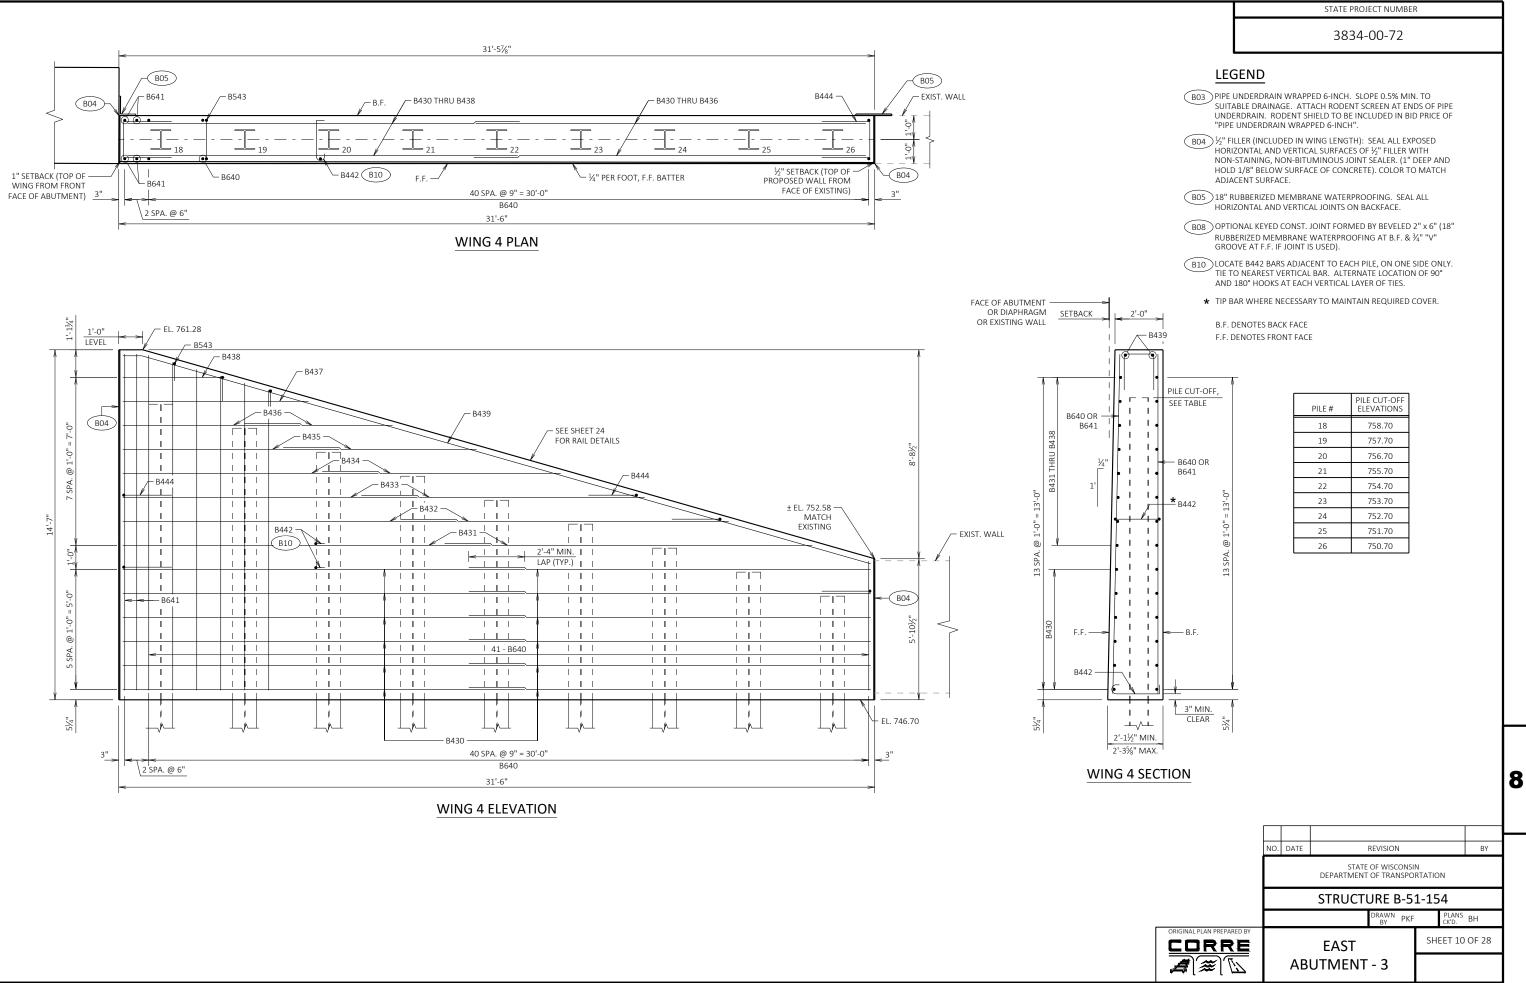


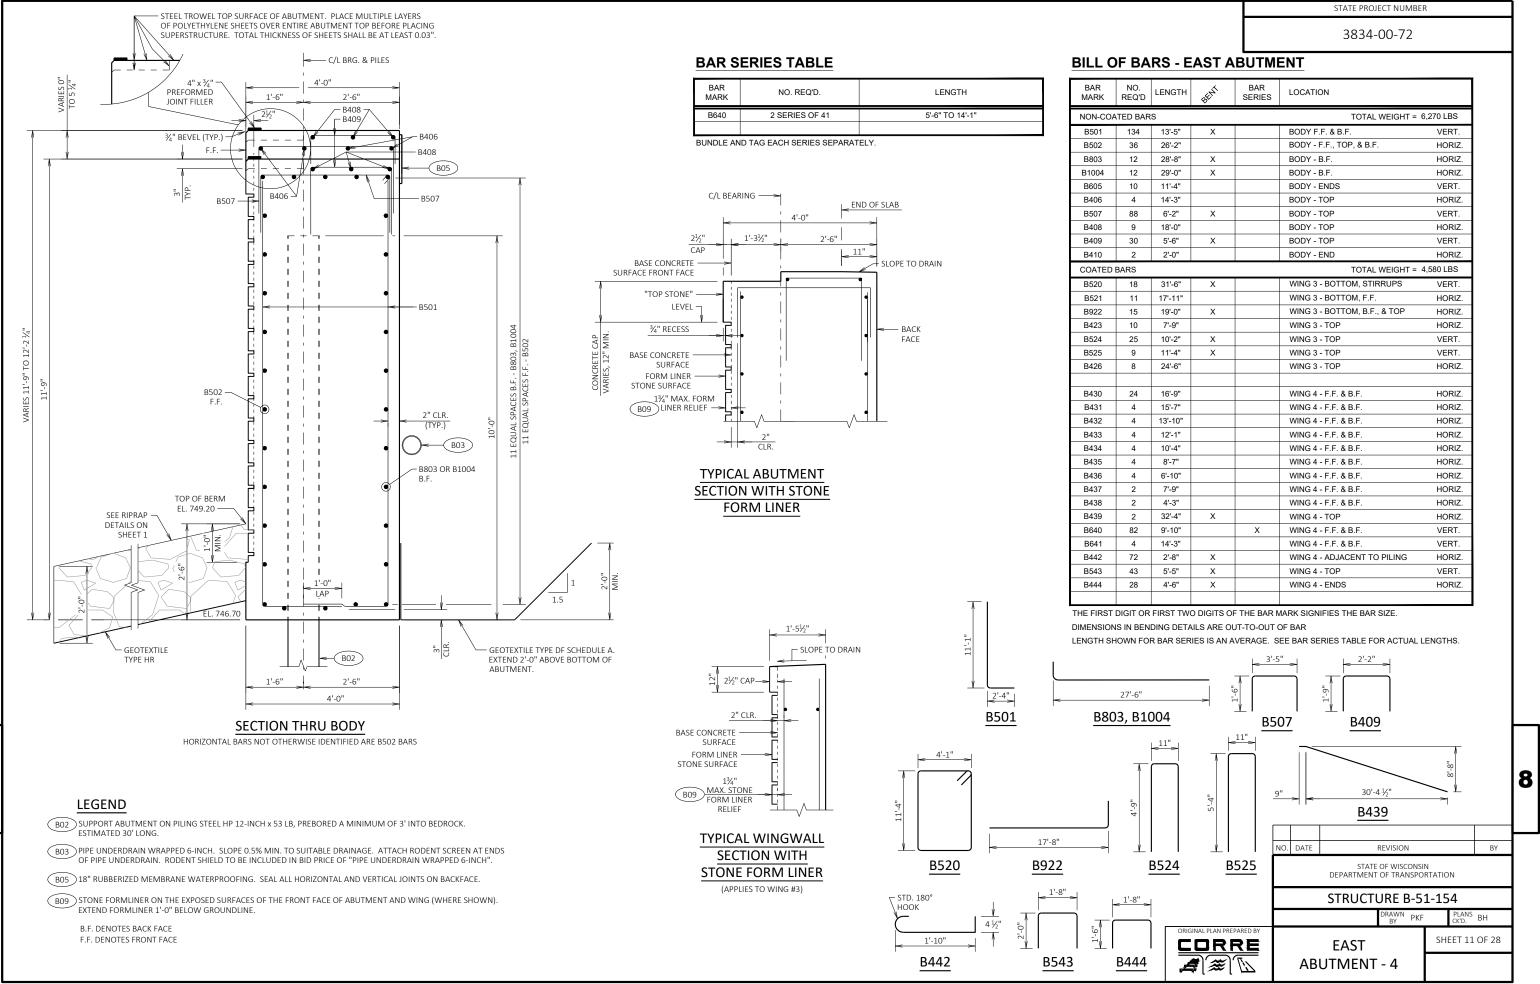

8/23/2022 4:37 PM PLOT DATE :

PAULETTE FENSKE PLOT BY :


'D	LENGTH	BENT	BAR SERIES	LOCATION	
BAR	s			TOTAL WEIGHT =	6,270 LBS
1	13'-5"	Х		BODY F.F. & B.F.	VERT.
	26'-2"			BODY - F.F., TOP, & B.F.	HORIZ.
	28'-8"	Х		BODY - B.F.	HORIZ.
	29'-0"	Х		BODY - B.F.	HORIZ.
	11'-4"			BODY - ENDS	VERT.
	14'-3"			BODY - TOP	HORIZ.
	6'-2"	Х		BODY - TOP	VERT.
	18'-0"			BODY - TOP	HORIZ.
	5'-6"	Х		BODY - TOP	VERT.
	2'-0"			BODY - END	HORIZ.
				TOTAL WEIGHT =	4,580 LBS
	31'-6"	Х		WING 3 - BOTTOM, STIRRUPS	VERT.
	17'-11"			WING 3 - BOTTOM, F.F.	HORIZ.
	19'-0"	Х		WING 3 - BOTTOM, B.F., & TOP	HORIZ.
	7'-9"			WING 3 - TOP	HORIZ.
	10'-2"	Х		WING 3 - TOP	VERT.
	11'-4"	Х		WING 3 - TOP	VERT.
	24'-6"			WING 3 - TOP	HORIZ.
	16'-9"			WING 4 - F.F. & B.F.	HORIZ.
	15'-7"			WING 4 - F.F. & B.F.	HORIZ.
	13'-10"			WING 4 - F.F. & B.F.	HORIZ.
	12'-1"			WING 4 - F.F. & B.F.	HORIZ.
	10'-4"			WING 4 - F.F. & B.F.	HORIZ.
	8'-7"			WING 4 - F.F. & B.F.	HORIZ.
	6'-10"			WING 4 - F.F. & B.F.	HORIZ.
	7'-9"			WING 4 - F.F. & B.F.	HORIZ.
	4'-3"			WING 4 - F.F. & B.F.	HORIZ.
	32'-4"	Х		WING 4 - TOP	HORIZ.
	9'-10"		Х	WING 4 - F.F. & B.F.	VERT.
	14'-3"			WING 4 - F.F. & B.F.	VERT.
	2'-8"	Х		WING 4 - ADJACENT TO PILING	HORIZ.
	5'-5"	Х		WING 4 - TOP	VERT.
	4'-6"	Х		WING 4 - ENDS	HORIZ.
_					

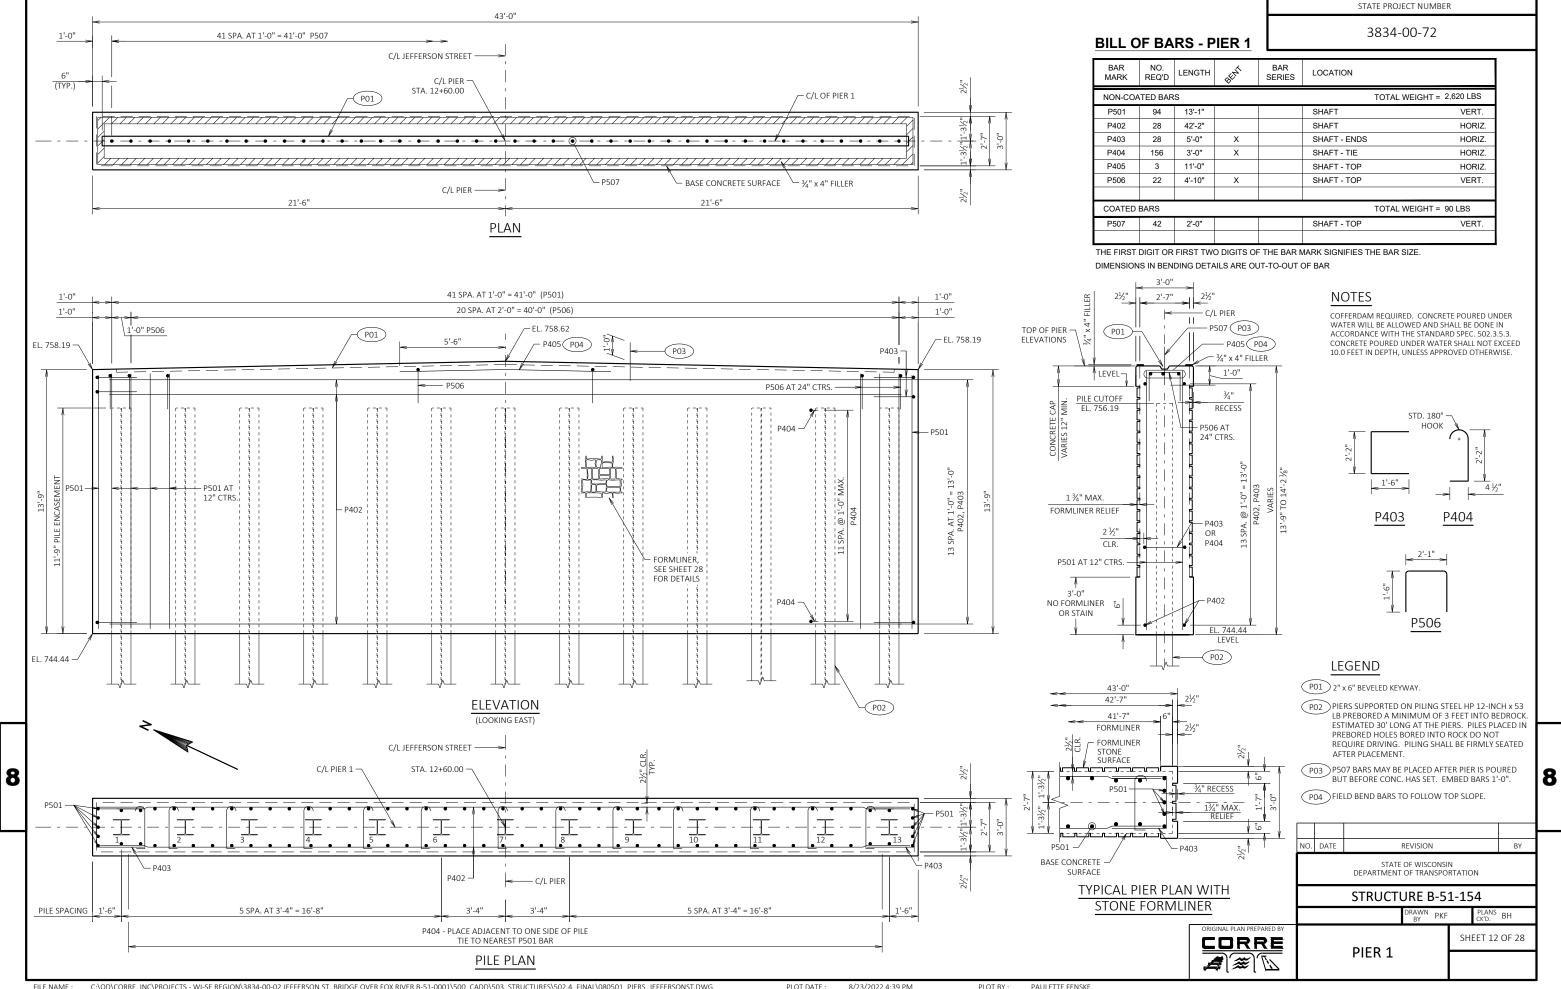


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8/23/2022 4:39 PM PLOT DATE :

'D	LENGTH	BENT	BAR SERIES	LOCATION	
BAR	S				TOTAL WEIGHT = 2,620 LBS
	13'-1"			SHAFT	VERT.
	42'-2"			SHAFT	HORIZ.
	5'-0"	Х		SHAFT - ENDS	HORIZ.
;	3'-0"	Х		SHAFT - TIE	HORIZ.
	11'-0"			SHAFT - TOP	HORIZ.
	4'-10"	Х		SHAFT - TOP	VERT.
					TOTAL WEIGHT = 90 LBS
	2'-0"			SHAFT - TOP	VERT.



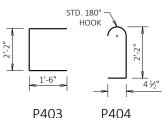

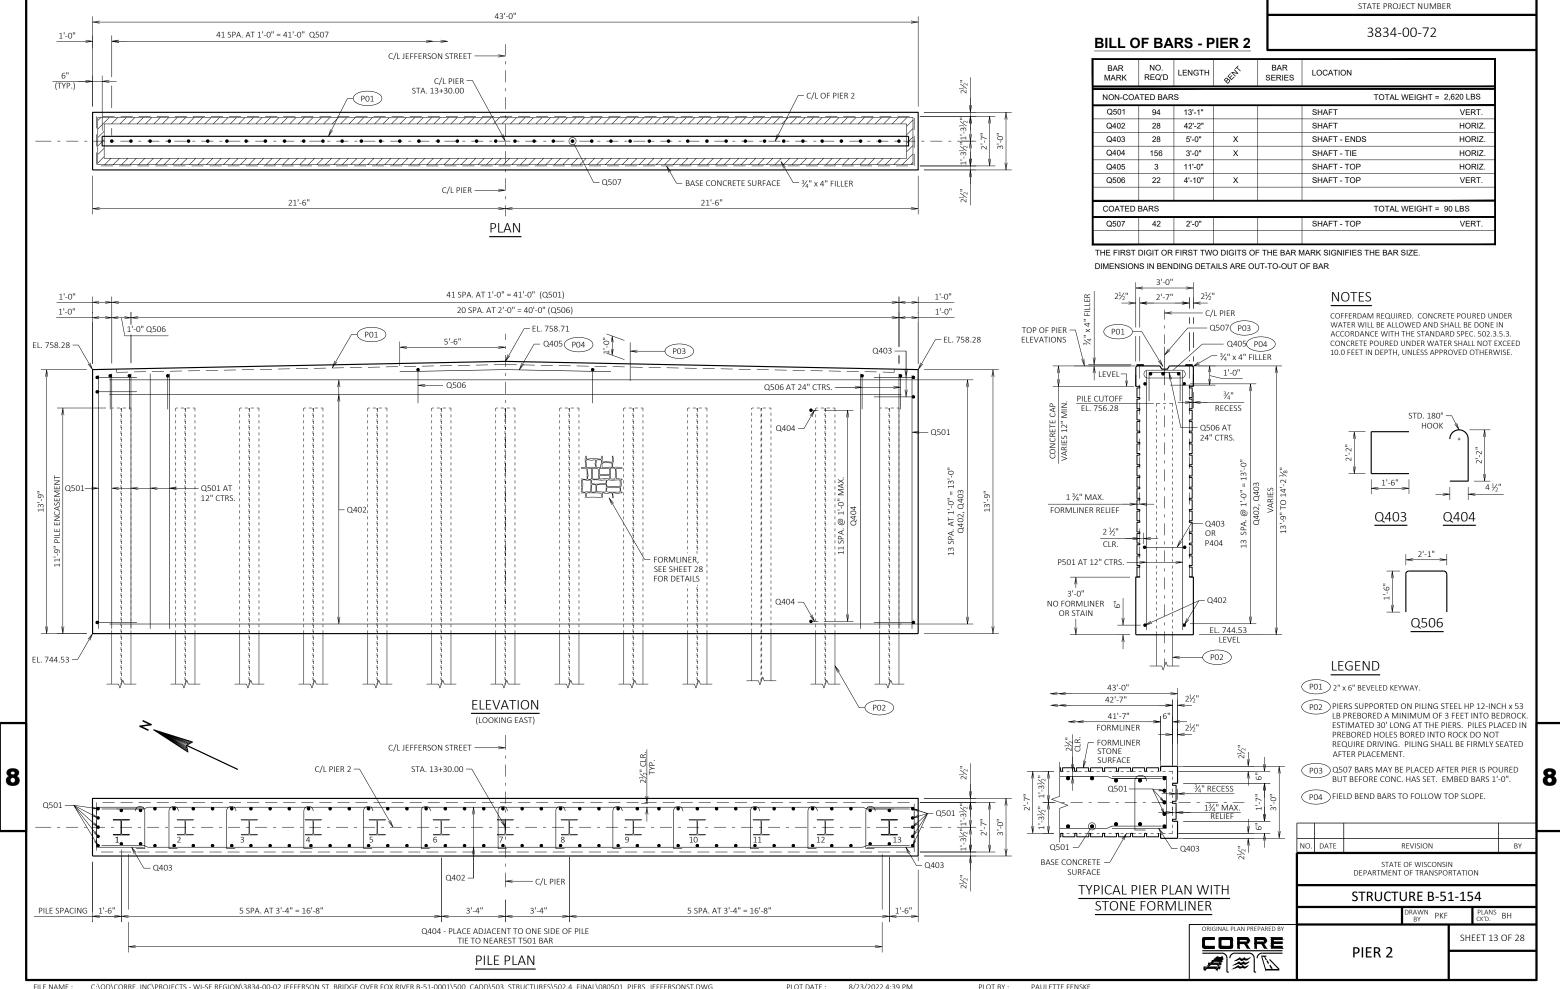


FILE NAME : C:\OD\CORRE, INC\PROJECTS - WI-SE REGION\3834-00-02 JEFFERSON ST_BRIDGE OVER FOX RIVER B-51-0001\500_CADD\503_STRUCTURES\502.4_FINAL\080501_PIERS_JEFFERSONST.DWG


8/23/2022 4:39 PM PLOT DATE :

PAULETTE FENSKE

'D	LENGTH	BENT	BAR SERIES	LOCATION	
AR	S				TOTAL WEIGHT = 2,620 LBS
	13'-1"			SHAFT	VERT.
	42'-2"			SHAFT	HORIZ.
	5'-0"	Х		SHAFT - ENDS	HORIZ.
;	3'-0"	Х		SHAFT - TIE	HORIZ.
	11'-0"			SHAFT - TOP	HORIZ.
	4'-10"	Х		SHAFT - TOP	VERT.
					TOTAL WEIGHT = 90 LBS
	2'-0"			SHAFT - TOP	VERT.
OR	FIRST TW		THE BAR N	ARK SIGNIFIES T	HE BAR SIZE.

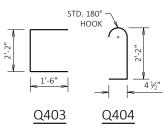



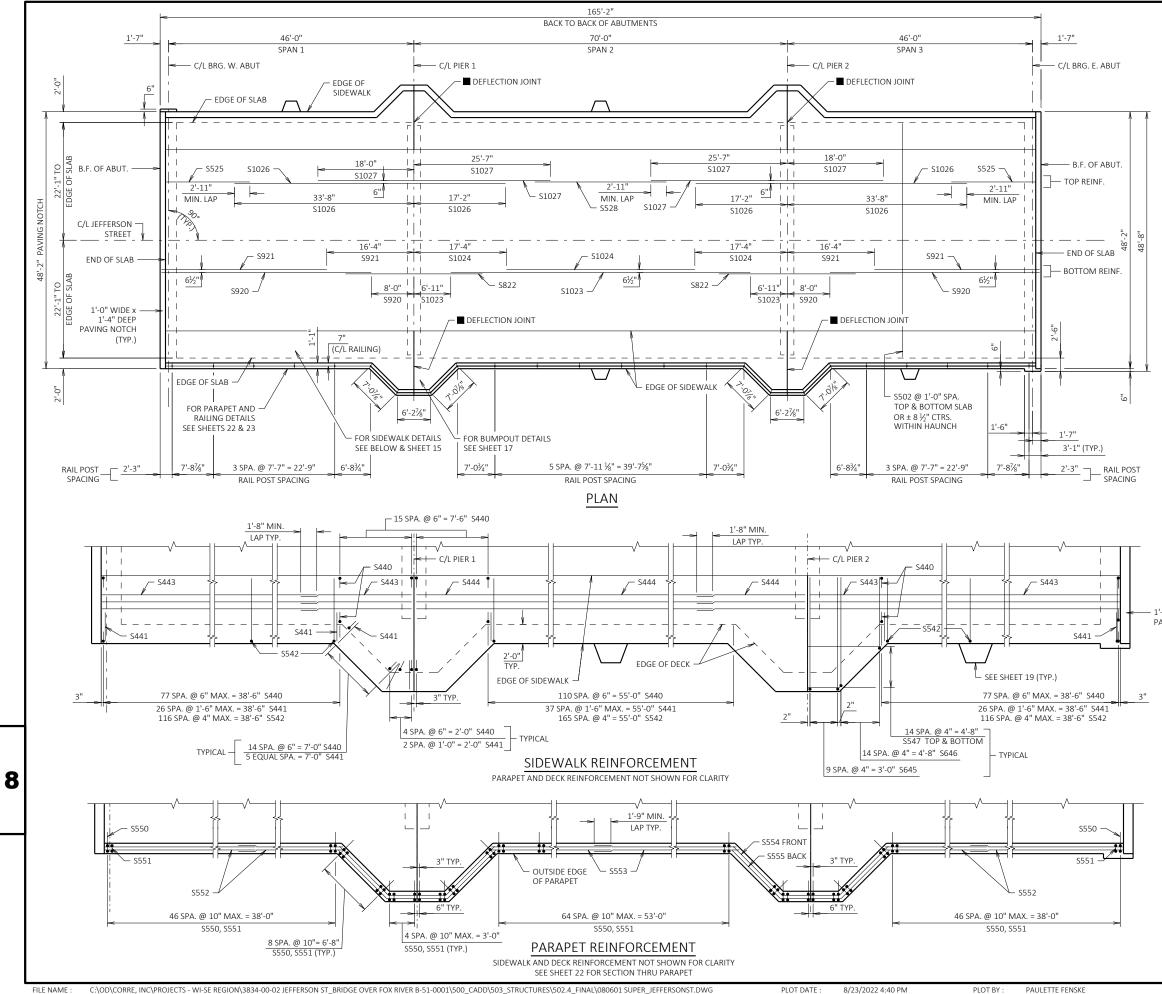

FILE NAME : C:\OD\CORRE, INC\PROJECTS - WI-SE REGION\3834-00-02 JEFFERSON ST_BRIDGE OVER FOX RIVER B-51-0001\500_CADD\503_STRUCTURES\502.4_FINAL\080601 SUPER_JEFFERSONST.DWG

STATE PROJECT NUMBER

3834-00-72

## NOTES

TOP TRANSVERSE BARS IN SLAB SHALL BE SUPPORTED BY INDIVIDUAL BAR CHAIRS AT APPROXIMATELY 3'-0" CENTERS FACH WAY, BOTTOM LONGITUDINAL BARS SHALL BE SUPPORTED BY CONTINUOUS BAR CHAIRS AT APPROXIMATELY 4'-0' CENTERS.


ALL SLAB THICKNESS DIMENSIONS ARE MINIMUM. ANY TOLERANCES NECESSARY TO CORRECT CONSTRUCTION DISCREPANCIES ARE TO BE PLUS (+).

PARAPETS AND SIDEWALKS PLACED ON TOP OF THE SLAB SHALL BE POURED AFTER FALSEWORK HAS BEEN RELEASED.

DEFLECTION JOINT IN SIDEWALK AND PARAPET AT C/L PIER TYP. SEE DETAIL, SHEET 22.


1'-0" WIDE x 1'-4" DEEP PAVING NOTCH (TYP.)


	NO.	DATE		REVISION			BY	
			STATE DEPARTMENT	OF WISCONSI OF TRANSPO		N		
			STRUCT	JRE B-5	1-15	4		
				DRAWN BY PKF		PLANS CK'D.	BH	
ORIGINAL PLAN PREPARED BY	0,	SUPE	RSTRUC	ΓURE	SH	EET 14	OF 28	
			PLAN					

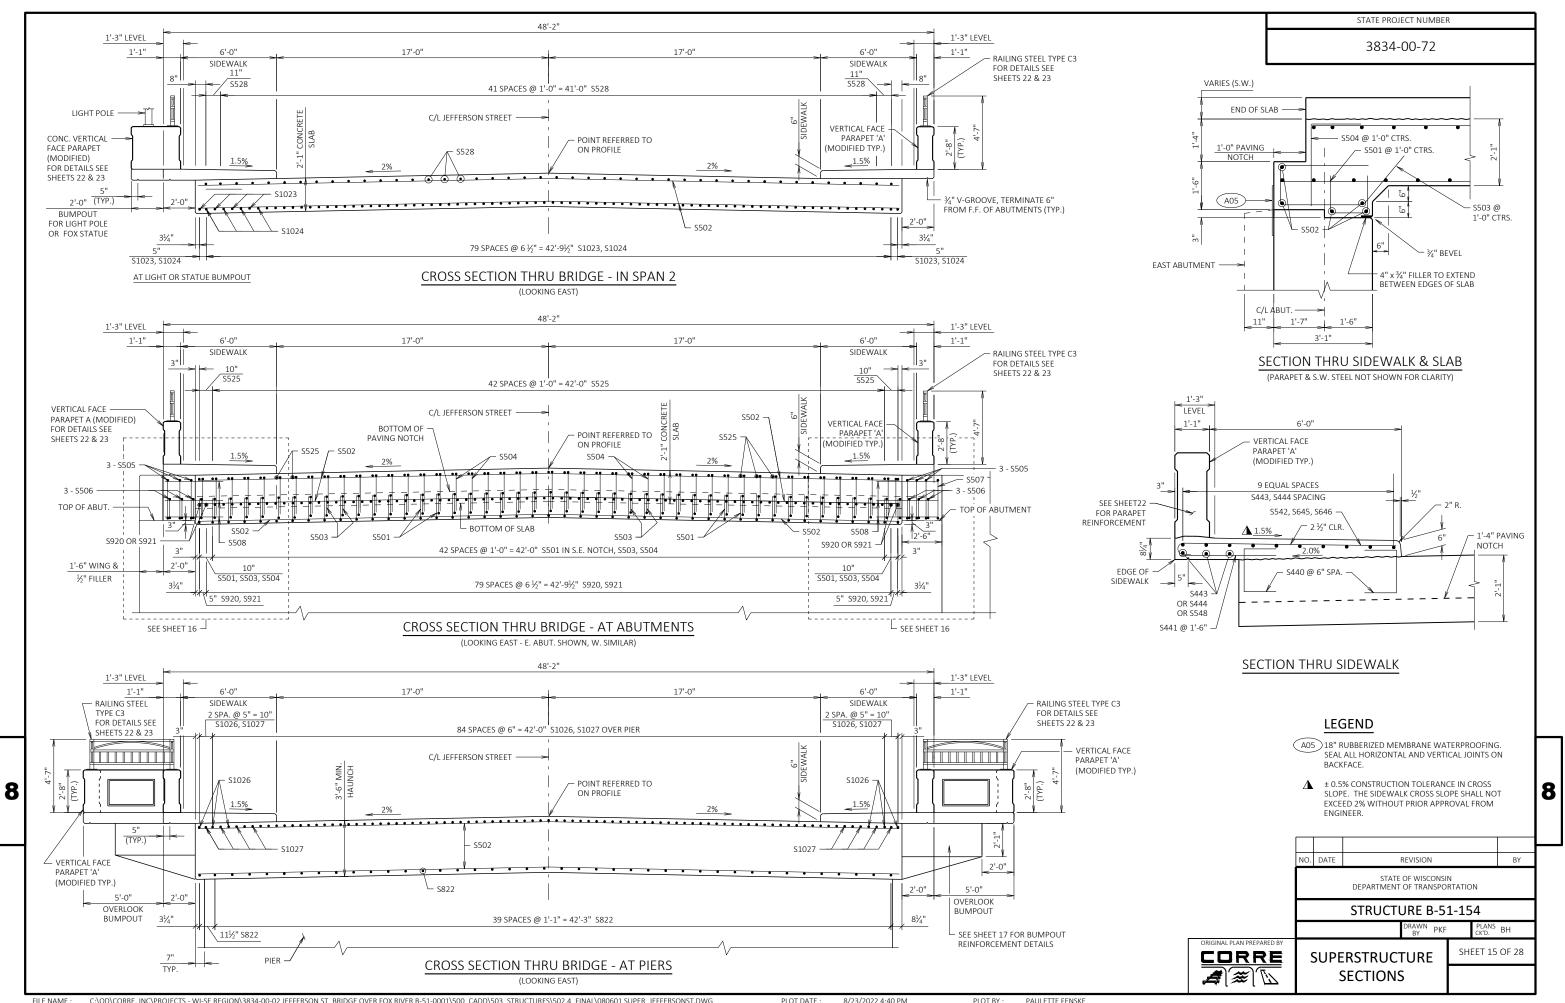

C:\OD\CORRE, INC\PROJECTS - WI-SE REGION\3834-00-02 JEFFERSON ST_BRIDGE OVER FOX RIVER B-51-0001\500_CADD\503_STRUCTURES\502.4_FINAL\080601 SUPER_JEFFERSONST.DWG

8/23/2022 4:40 PM PLOT BY :

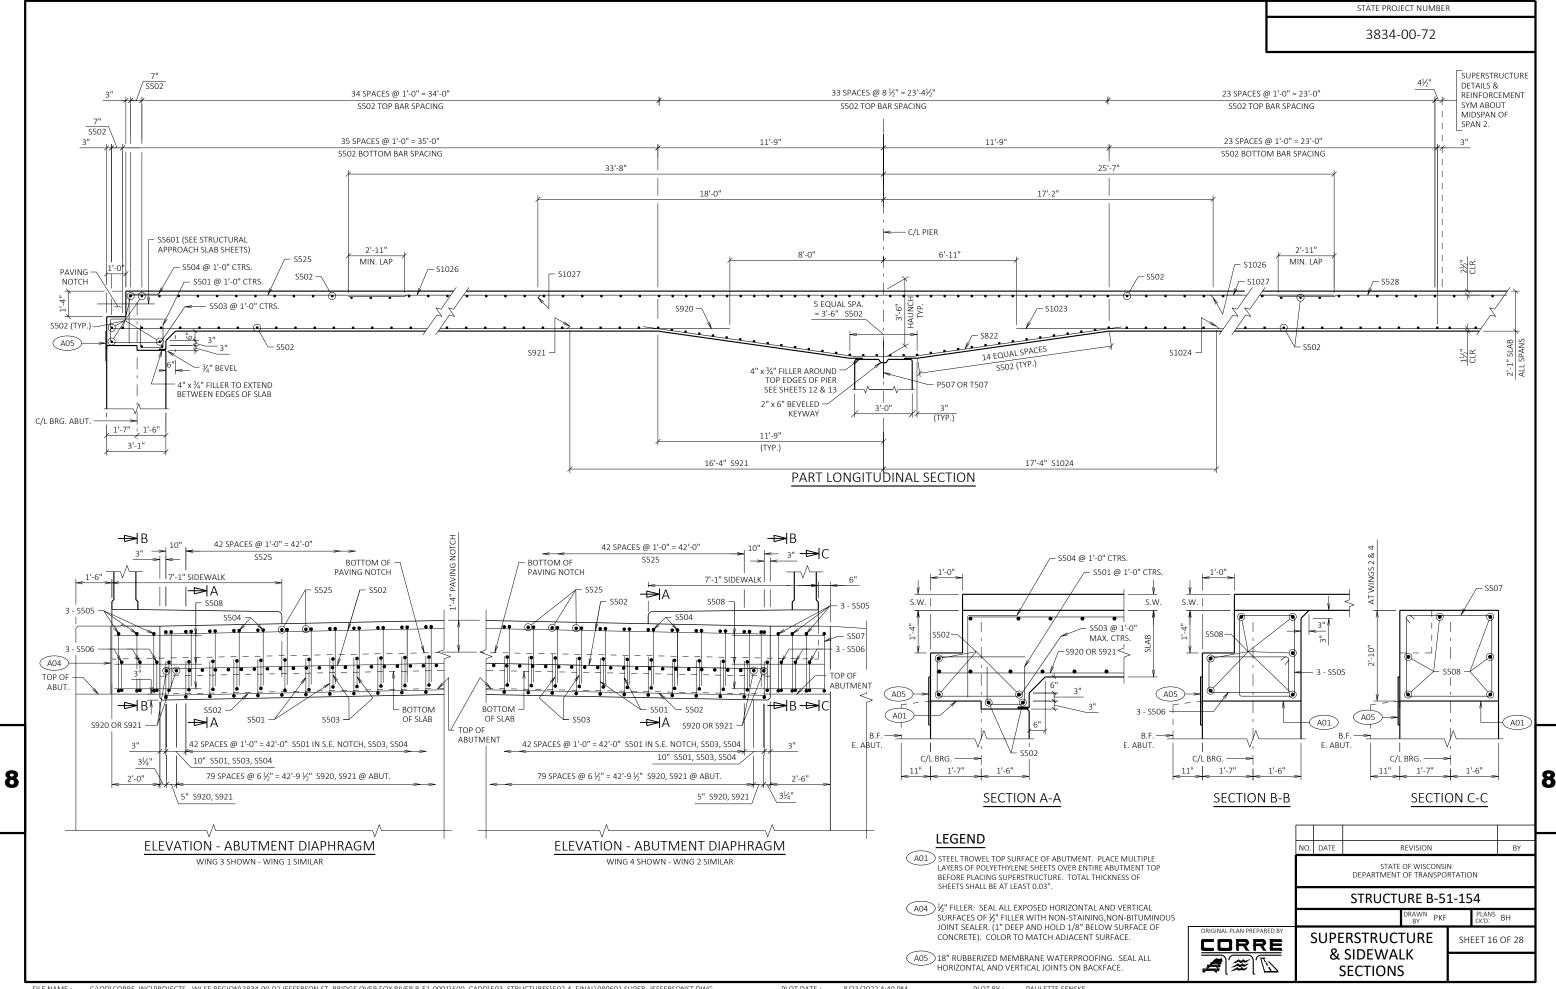

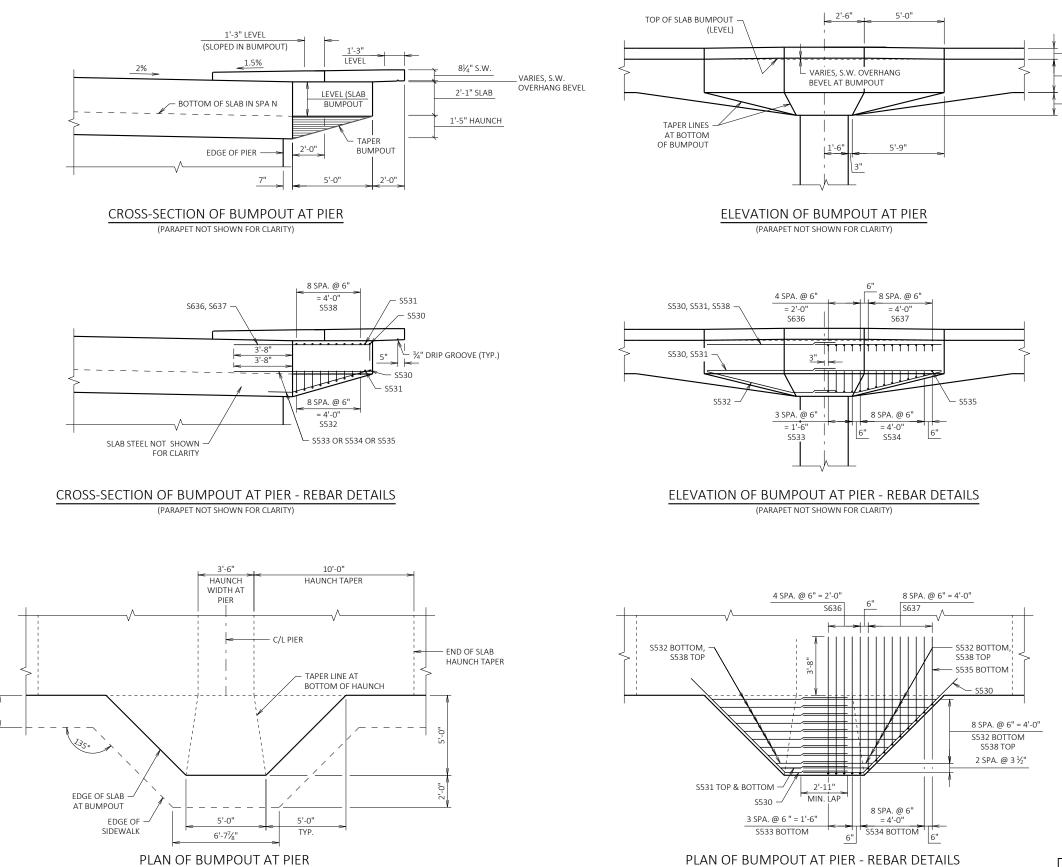

STATE	PROJECT	NUMBER

3834-00-72

8¹/₄" S.W. 2'-1" SLAB 4 1'-5" HAUNCH

8

BY

PLANS BH

SHEET 17 OF 28

NO. DATE

ORIGINAL PLAN PREPARED BY

REVISION

STATE OF WISCONSIN DEPARTMENT OF TRANSPORTATION

STRUCTURE B-51-154


SUPERSTRUCTURE


**BUMPOUT DETAILS** 

BY PKF

## TOP OF SLAB ELEVATIONS

												1																			
LOCHTION	C/L BRG.		0.0.07	0.0.07	0.4 57	0.5.07	0 ( <b>D</b> T	0.5.55	0.0 57	0.0 57		0.1 DT	0 <b>0</b> DT	0 0 DT	0.4.55	0.5.05	0.6 PT	0.5.55	0.0 PT	0.0 PT		0.1.07	0 0 DT	0 0 DT	0.4 57	0.5.07	0 ( <b>D</b> T	0.5.05	0.0 PT	0.0 57	C/L BRG.
LOCATION	W. ABUT	0.1 PT.	0.2 PT.	0.3 PT.	0.4 PT.	0.5 PT.	0.6 PT.	0.7 PT.	0.8 PT.	0.9 PT.	C/L PIER I	0.1 PT.	0.2 PT.	0.3 PT.	0.4 PT.	0.5 PT.	0.6 PT.	0.7 PT.	0.8 PT.	0.9 PT.	C/L PIER 2	0.1 PT.	0.2 PT.	0.3 PT.	0.4 PT.	0.5 PT.	0.6 PT.	0.7 PT.	0.8 PT.	0.9 PT.	E. ABUT.
NORTH EDGE OF	761.06	761.15	761.23	761.21	761.39	761 46	761 52	761 59	761.64	761.69	761.74	761.80	761.05	761 00	761.01	761.02	761.02	761.02	761.00	761.87	761.83	761.90	761 76	761 72	761 67	761.62	761 56	761 50	761 42	761.26	761.28
DECK	/01.00	/01.15	/01.25	/01.51	/01.39	/01.40	/01.32	/01.38	/01.04	/01.09	/01./4	/01.00	/01.85	/01.00	/01.91	/01.92	/01.95	/01.92	/01.90	/01.0/	/01.65	/01.00	/01./0	/01./2	/01.0/	/01.02	/01.30	701.30	/01.45	/01.50	/01.20
C/L JEFFERSON STREET	761.50	761.59	761.68	761.76	761.83	761.90	761.97	762.03	762.08	762.13	762.18	762.24	762.29	762.33	762.35	762.37	762.37	762.36	762.34	762.31	762.27	762.24	762.20	762.16	762.11	762.06	762.00	761.94	761.87	761.80	761.72
SOUTH EDGE OF DECK	761.06	761.15	761.23	761.31	761.39	761.46	761.52	761.58	761.64	761.69	761.74	761.80	761.85	761.88	761.91	761.92	761.93	761.92	761.90	761.87	761.83	761.80	761.76	761.72	761.67	761.62	761.56	761.50	761.43	761.36	761.28

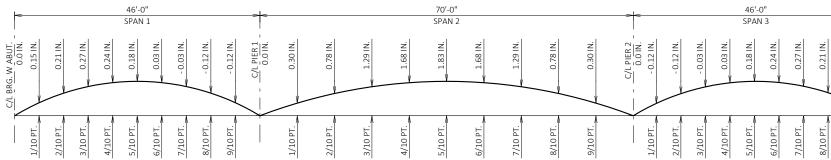

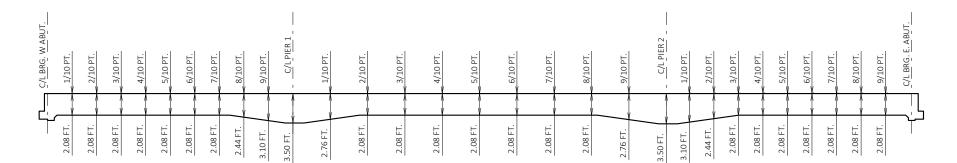

## CAMBER AND SLAB THICKNESS DIAGRAM

CAMBER IS BASED ON 3 TIMES DEAD LOAD DEFLECTIONS. CAMBER SPANS AS SHOWN TO PROVIDE FOR DEADLOAD DEFLECTION & FUTURE CREEP. CAMBER DOES NOT INCLUDE ALLOWANCE FOR FORM SETTLEMENT. PARAPETS AND SIDEWALKS SHOWN ABOVE THE HORIZ. CONST. JT. SHALL BE POURED AFTER FALSEWORK HAS BEEN RELEASED.

TO DETERMINE FALSEWORK ELEVATION AT EDGE OF SLAB OR CROWN FOLLOW THIS PROCEDURE:

- TOP OF SLAB ELEVATION AT FINAL GRADE
- LESS (-) SLAB THICKNESS
- PLUS (+) CAMBER PLUS (+) FORM SETTLEMENT/DEFLECTION DUE TO PLACEMENT OF SLAB CONCRETE (TO BE COMPUTED BY THE CONTRACTOR)

EQUALS TOP OF SLAB FALSEWORK ELEVATION.

## SURVEY TOP OF SLAB ELEVATIONS

	C/L BRG. W. ABUT.	5/10 PT.	C/L PIER 1	5/10 PT.	C/L PIER 2	5/10 PT.	C/L BRG. E. ABUT.
NORTH GUTTERLINE							
C/L JEFFERSON ST./CROWN POINT							
SOUTH GUTTERLINE							


PRIOR TO RELEASING SLAB FALSEWORK, TAKE TOP OF SLAB ELEVATIONS AT THE C/L OF ABUTMENTS, THE C/L OF PIERS, AND AT 5/10 PTS. TO VERIFY CAMBER. TAKE ELEVATIONS ALONG GUTTERLINES AND CROWN. RECORD THE ELEVATIONS IN THE ABOVE TABLE FOR THE "AS BUILT" PLANS.


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STATE	PROJECT	NUMBER
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3834-00-72





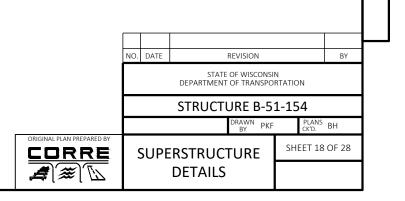


BAR MARK	NO. REQ'D	LENGTH	BENT	BAR SERIES	LOCATION	
COATED	BARS				TOTAL WEIGHT =	130,310 LBS
S501	90	3'-11"	Х		SLAB AT ABUTMENT NOTCH	VERT.
S502	384	43'-10"			SLAB -TRANSVERSE BARS	TRANS.
S503	90	8'-4"	х		SLAB AT ABUTMENTS	VERT.
S504	90	3'-10"	х		SLAB AT ABUTMENTS	VERT.
S505	12	9'-2"	х		SLAB AT ABUTMENT ENDS	VERT.
S506	12	8'-6"	х		SLAB AT ABUTMENT ENDS	VERT.
S507	2	11'-2"	х		SLAB AT ABUTMENT ENDS NEAR WINGS 2 & 4	VERT.
S508	24	4'-0"			SLAB AT ABUTMENT ENDS	HORIZ.
S509	48	6'-0"			SLAB AT LIGHT STANDARD OR STATUE BUMPOUT	TRANS.
S510	48	6'-7"	х		SLAB AT LIGHT STANDARD OR STATUE BUMPOUT	TRANS.
S920	82	39'-5"			SLAB - BOTTOM, SPANS 1 & 3	LONG.
S921	82	31'-1"			SLAB - BOTTOM, SPANS 1 & 3	LONG.
S822	82	25'-8"	х		SLAB - BOTTOM, OVER PIERS	LONG.
S1023	41	56'-2"			SLAB - BOTTOM, SPAN 2	LONG.
S1024	41	35'-4"			SLAB - BOTTOM, SPAN 2	LONG.
S525	90	15'-9"			SLAB - TOP, SPANS 1 & 3	LONG.
S1026	90	50'-10"			SLAB - TOP, OVER PIERS	LONG.
S1027	88	43'-7"			SLAB - TOP, OVER PIERS	LONG.
S528	88	24'-9"			SLAB - TOP, SPAN 2	LONG.
S530	16	12'-3"	x		SLAB BUMPOUT AT EDGE	LONG.
S531	8	5'-5"	~		SLAB BUMPOUT	LONG.
S532	72	6'-8"	x	x	SLAB BUMPOUT - BOTTOM	LONG.
S533	32	8'-9	x	~	SLAB BUMPOUT - BOTTOM	TRANS.
S534	72	6'-8"	x	x	SLAB BUMPOUT - BOTTOM	TRANS.
S535	8	4'-2"	~	~	SLAB BUMPOUT - BOTTOM	TRANS.
S636	40	9'-4"	х		SLAB BUMPOUT - TOP	TRANS.
S637	72	7'-0"	X	x	SLAB BUMPOUT - TOP	TRANS.
S538	72	6'-6"	^	X	SLAB BUMPOUT - TOP	LONG.
3330	12	0-0		^		LONG.
S440	1356	3'-2"	x		SIDEWALK - TIE BARS	VERT.
S440		3'-0"	^		SIDEWALK - THE BARS SIDEWALK AT OVERHANG - BOTTOM	
S542	256 800	7'-3"	x			TRANS. TRANS.
			^			
S443	104	24'-0"			SIDEWALK TOP & BOTTOM	LONG.
S444	52	35'-9"	X			LONG.
S645	80	12'-4"	X	X	SIDEWALK AT BUMPOUT - TOP	TRANS.
S646	120	9'-11"	Х	X	SIDEWALK AT BUMPOUT - TOP	TRANS.
S547	240	5'-5"		Х	SIDEWALK AT BUMPOUT - TOP & BOTTOM	LONG.
0550	400	41.41	Y		DADADETO	VEDT
S550	430	4'-4"	X		PARAPETS	VERT.
S551	430	4'-9"	Х		PARAPETS	VERT.
S552	64	20'-3"			PARAPETS - SPANS 1 & 3	LONG.
S553	32	28'-0"			PARAPETS - SPAN 2	LONG.
S554	32	11'-11"	X		PARAPETS AT BUMPOUTS, F.F.	LONG.
S555	32	12'-2"	X		PARAPETS AT BUMPOUTS, B.F.	LONG.
S560	48	7'-3"	x		LIGHT STD. OR STATUE BUMPOUT - TOP AT S.W.	TRANS.
S561	16	6'-3"	X		LIGHT STD. OR STATUE BUMPOUT	VERT.
S562	16	7'-1"	x		LIGHT STD. OR STATUE BUMPOUT	VERT.
S663	28	10'-0"	X		LIGHT STD. OR STATUE BUMPOUT	HORIZ.
S564	48	6'-8"			LIGHT STD. OR STATUE BUMPOUT - BTM AT S.W.	TRANS.
S565	8	3'-2"	х		LIGHT STD. OR STATUE BUMPOUT	VERT.
5565	0	3'-2"	^			VERT.

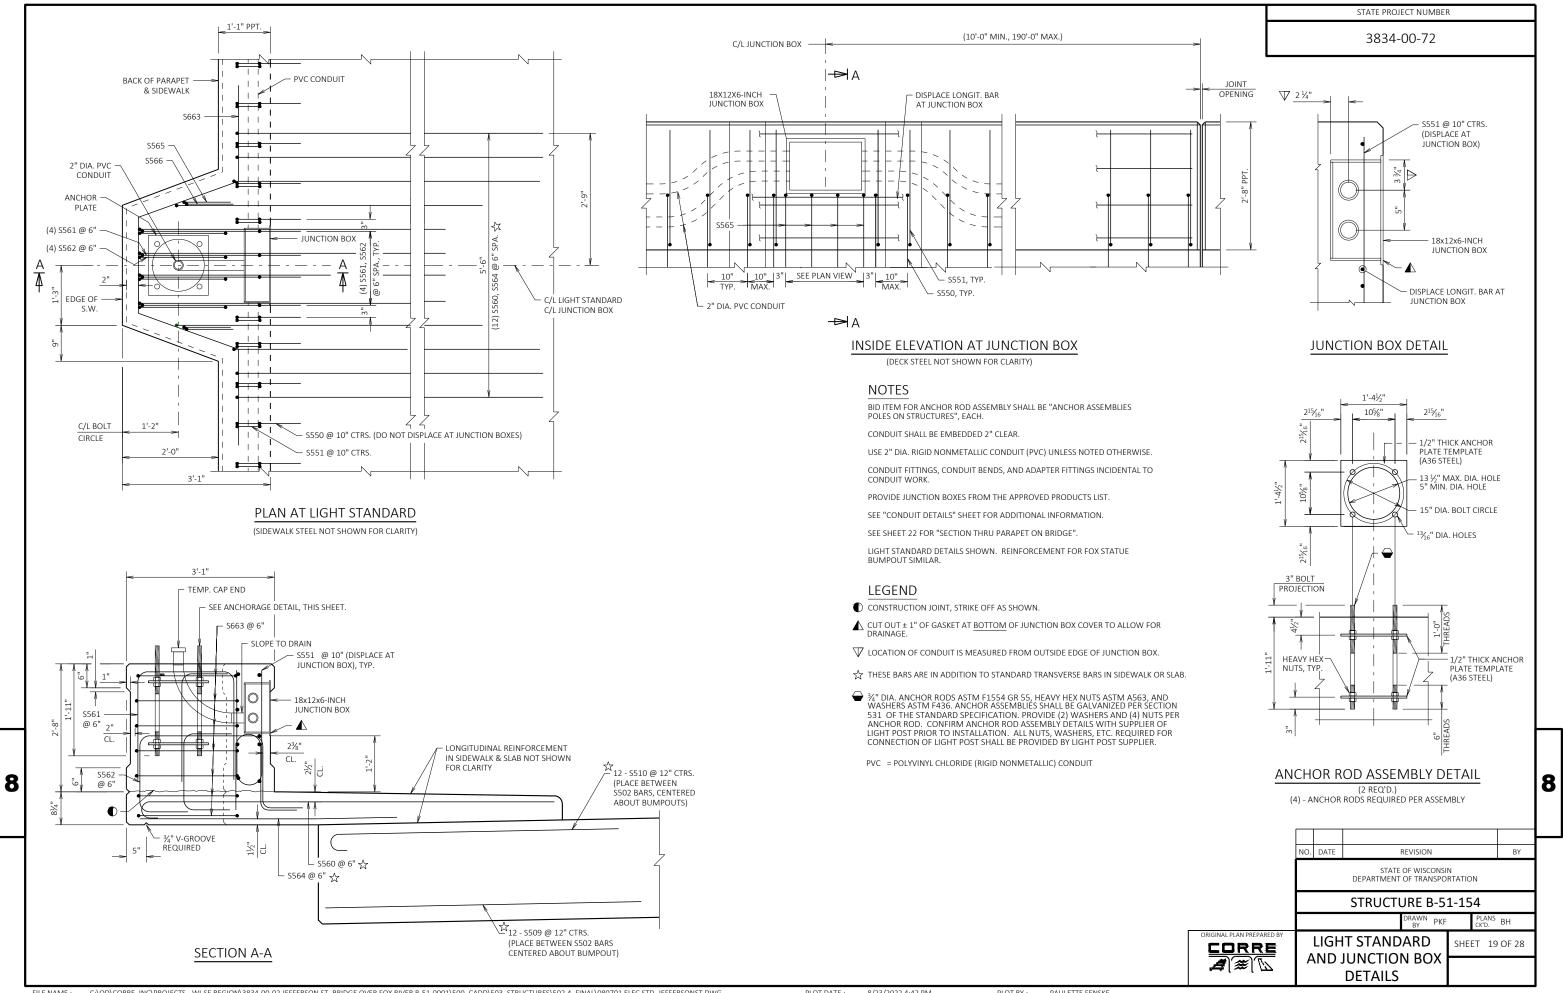
# **BILL OF BARS - SUPERSTRUCTURE**


# **BAR SERIES TABLE**


BAR MARK	NO. REQ'D.	LENGTH
S532	8 SERIES OF 9	4'-7" TO 8'-8"
S534	8 SERIES OF 9	4'-8" TO 8'-8"
S637	8 SERIES OF 9	5'-0" TO 9'-0"
S538	8 SERIES OF 9	4'-6" TO 8'-6"
S646	8 SERIES OF 15	7'-7" TO 12'-3"
S547	16 SERIES OF 15	3'-1" TO 7'-9"


BUNDLE & TAG EACH SERIES SEPARATELY

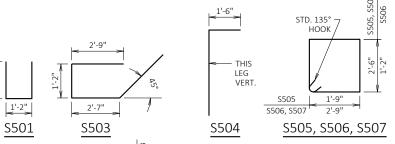

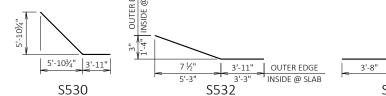

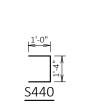

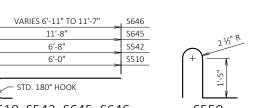

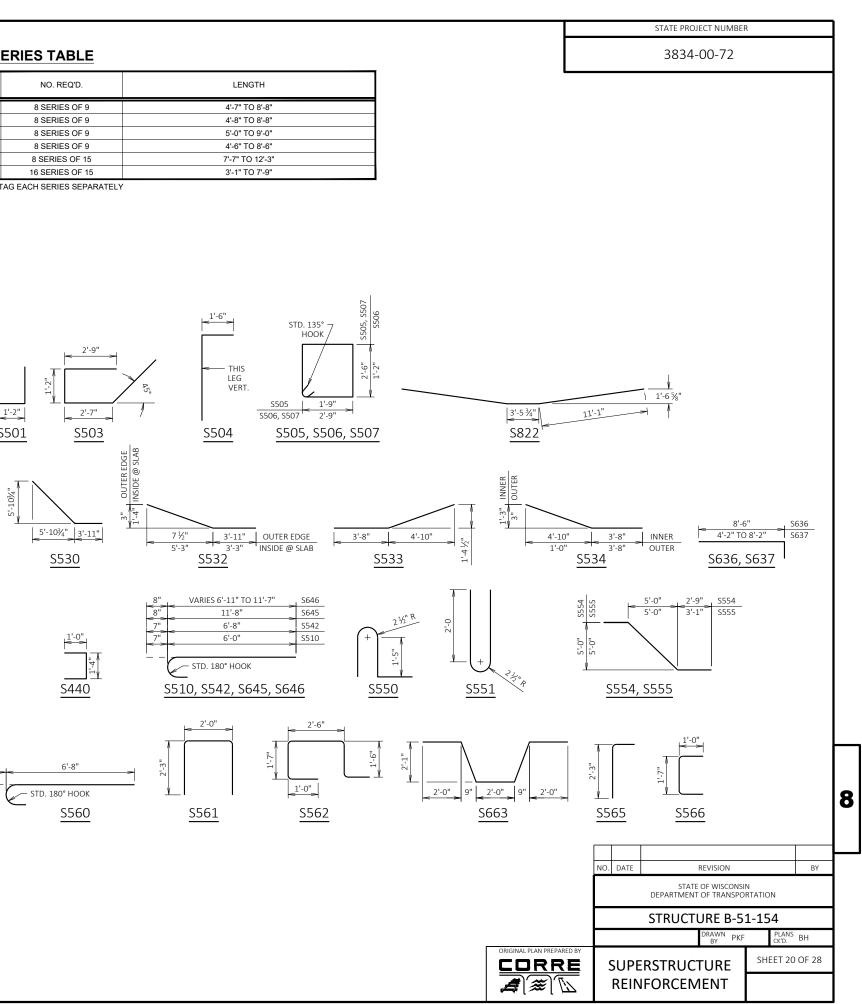

THE FIRST DIGIT OR FIRST TWO DIGITS OF THE BAR MARK SIGNIFIES THE BAR SIZE.

DIMENSIONS IN BENDING DETAILS ARE OUT-TO-OUT OF BAR.

3'-4"

LENGTH SHOWN FOR BAR SERIES IS AN AVERAGE. SEE BAR SERIES TABLE FOR ACTUAL LENGTHS.

USE REINFORCEMENT DETAILS ON SHEET 19 FOR STATUE BUMPOUTS.


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S566

8

LIGHT STD. OR STATUE BUMPOUT

VERT.

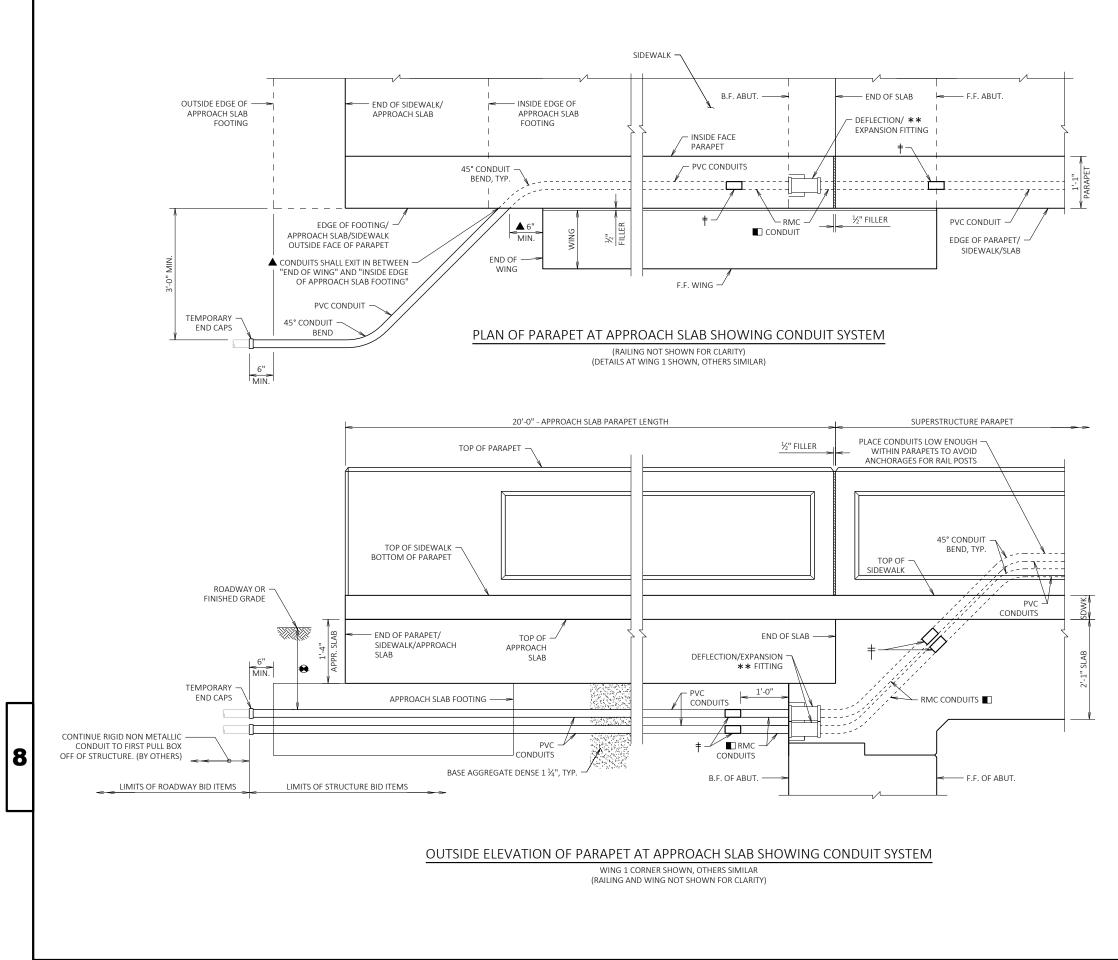

### 3834-00-72

## NOTES

CONDUIT SHALL BE EMBEDDED 2" CLEAR.

USE 2" DIA. RIGID NONMETALLIC CONDUIT (PVC) UNLESS NOTED OTHERWISE.

CONDUIT FITTINGS, CONDUIT BENDS, AND ADAPTER FITTINGS INCIDENTAL TO CONDUIT WORK.

CONDUIT BENDS SHALL CONFORM TO THE NATIONAL ELECTRIC CODE.

2'-0" MIN. CONDUIT COVER UNDER ROADWAYS, 1'-6" OTHERWISE. CONDUIT COVER SHOULD NOT EXCEED 3'-0"

PROVIDE JUNCTION BOXES FROM THE APPROVED PRODUCTS LIST.

LOCATE CONDUIT IN PARAPET TO AVOID RAIL ANCHORAGES.


AN ADDITIONAL CONDUIT IS PROVIDED AT EACH PARAPET FOR FUTURE USE.


## LEGEND

- USE 2" DIA. RIGID METALLIC (RMC) CONDUIT AT FITTINGS. PROVIDE RMC FOR 3'-0" MIN. ON EACH SIDE OF JOINT OPENINGS UNLESS NOTED OTHERWISE.
- + NONMETALLIC CONDUIT TO METALLIC CONDUIT ADAPTER FITTING (UL OR NRTL LISTED FOR ELECTRICAL USE SHALL BE USED)

SPONGE RUBBER WRAP TO BE AASHTO M153, TYPE 1 OR EQUIVALENT - '4'' MINIMUM THICKNESS. PROVIDE WRAP FOR THE ENTIRE LENGTH OF THE FITTING OR AS SHOW. SPONGE RUBBER WRAP INCIDENTAL TO "CONDUIT RIGID METALLIC 2-INCH".


- ★★ DEFLECTION/EXPANSION FITTING REQUIREMENTS (IF USED): UP TO ¾" CONDUIT CONTRACTION OR EXPANSION AND UP TO 30 DEGREES OF ANGULAR MISALIGNMENT IN ANY DIRECTION WITH BONDING JUMPER
- ▲ PROVIDE PVC CONDUIT SLEEVES, OR APPROVED ALTERNATE METHOD BY ENGINEER, AT LOCATIONS WHERE CONDUIT RUNS THROUGH EAST APPROACH SLAB FOOTING. COST OF SLEEVE IS INCIDENTAL TO "CONCRETE MASONRY" BID ITEM.

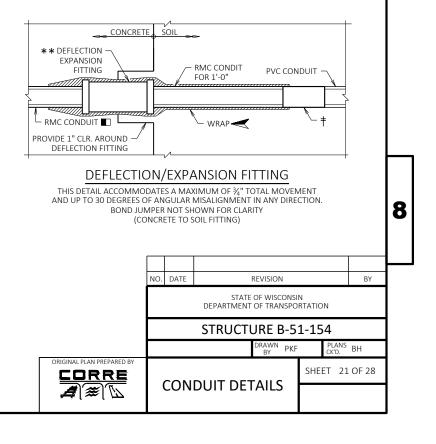

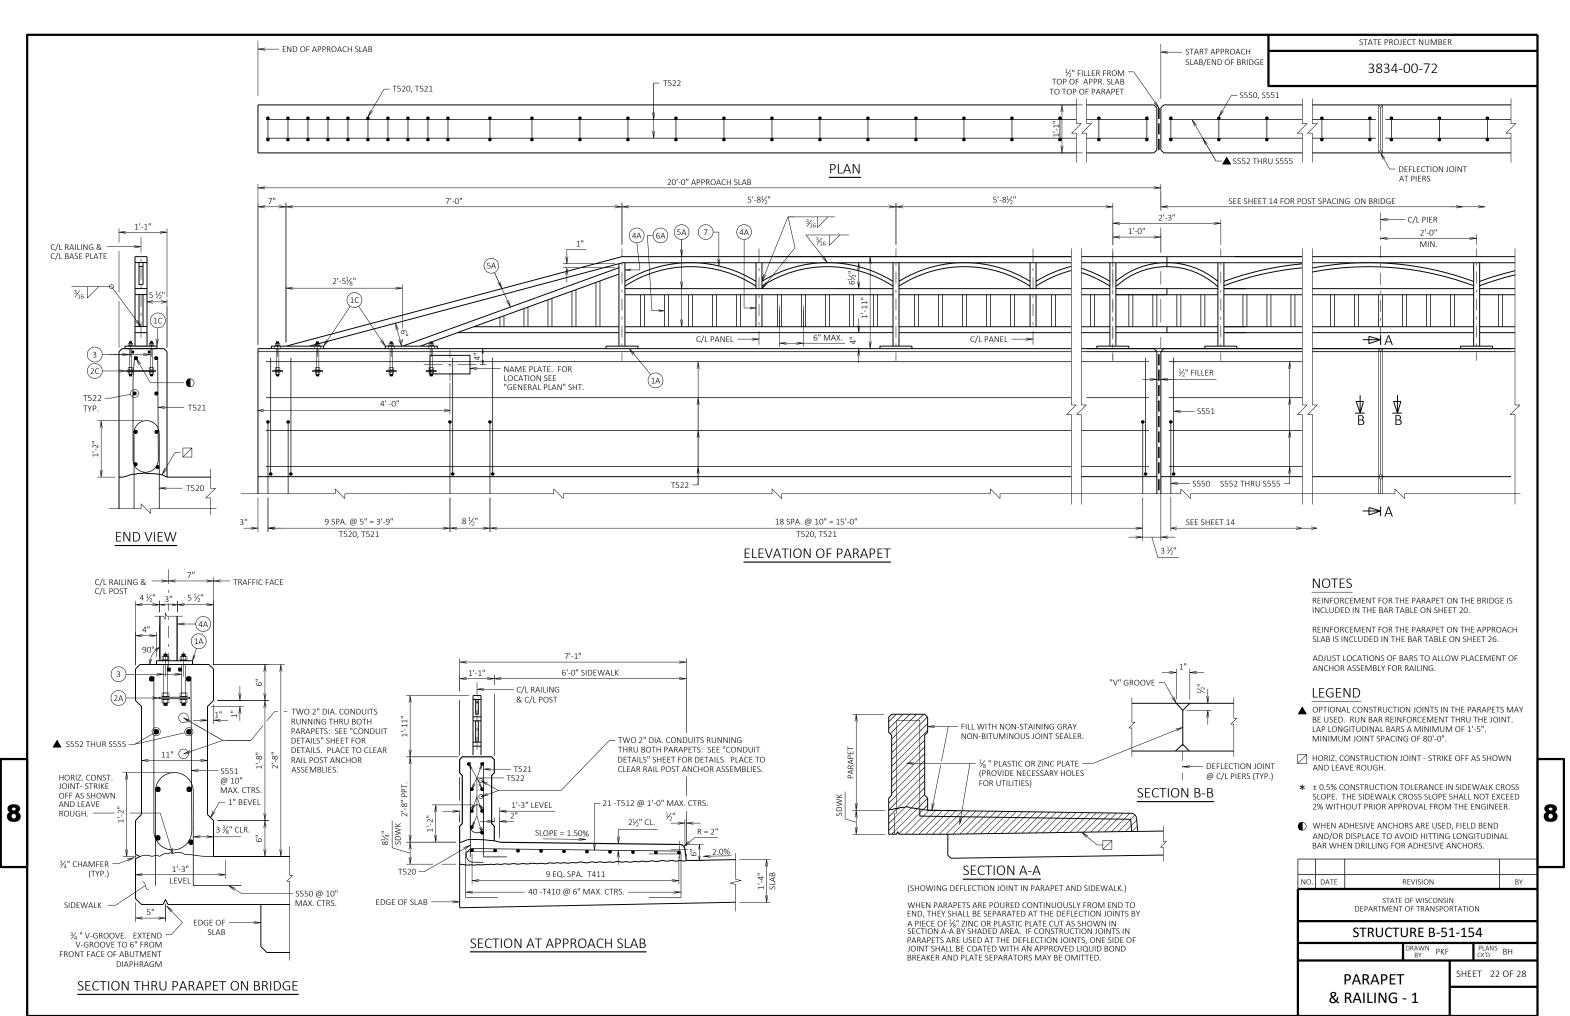

PLOT DATE : 8/23/2022 4:46 PM

PLOT BY : PAULETTE FENSKE

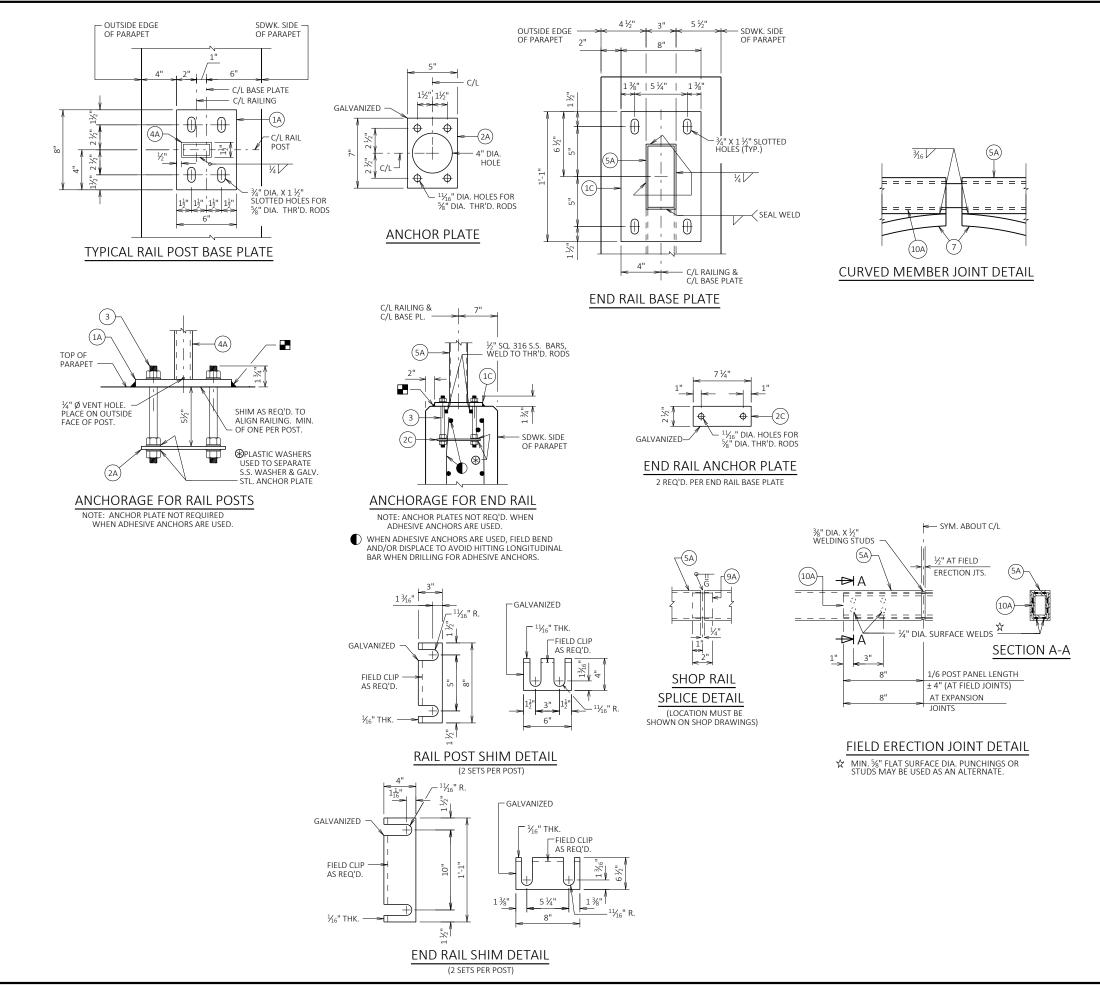

STATE PROJECT NUMBER

3834-00-72

# LEGEND

- (1A) PLATE ⁵/₈" X 6" X 8" WITH ³/₄" X 1 ¹/₂" SLOTTED HOLES.
- (1C) PLATE 5/8" X 8" X 1'-1" WITH 3/4" X 1 1/2" SLOTTED HOLES.
- (2A)  $\frac{1}{4}$ " X 5" X 7" ANCHOR PLATE WITH  $\frac{11}{16}$ " DIA. HOLES FOR THR'D. RODS NO. 3.
- (2C) ¹/₄" X 2 ¹/₂" X 7 ¹/₄" ANCHOR PLATE WITH ¹¹/₁₆" DIA. HOLES FOR THR'D. RODS NO. 3.
- %" DIA. X 9" LONG, TYPE 316 STAINLESS STEEL THREADED RODS (MIN. TENSILE STRENGTH = 70 KSI) WITH NUT AND WASHERS OF SAME ALLOY GROUP. ALTERNATIVE ANCHORAGE: CONCRETE ADHESIVE ANCHORS ½-INCH. EMBED 7" IN CONCRETE FOR RAIL POSTS. EMBED 5" IN CONCRETE FOR END RAILS. ADHESIVE ANCHORS SHALL CONFORM TO SECTION 502.2.12 AND 502.3.14 OF THE STANDARD SPECIFICATIONS.
- (4A) STRUCTURAL TUBING 3" X  $1\frac{1}{2}$ " X  $\frac{3}{16}$ ". PLACE VERTICAL. WELD TO NO. 1 & 5.
- (5A) STRUCTURAL TUBING 3" X 1 12'' X  $3_6''$  RAILS. WELD TO NO. 1 & NO. 4. INSIDE OF TUBE TO BE PAINTED AT ALL FIELD ERECTION & EXPANSION JOINTS.
- (6A) BAR 1" X 1" PICKETS. WELD TO NO. 5. PLACE VERTICAL. SPACE AT 6" MAX. C/L TO C/L.
- (7) BAR 1" X 1". BEND TO REQUIRED RADIUS. WELD TO NO. 4 & 5.
- (9A) RECTANGULAR SLEEVE FABRICATED FROM  $\frac{3}{16}$ " PLATES. PROVIDE "SLIDING FIT".
- (10A) RECTANGULAR SLEEVE FABRICATED FROM  $\frac{3}{16}$ " PLATES. (1'-4" @ FIELD ERECTION JTS.)

### **RAILING NOTES**

BID ITEM SHALL BE "RAILING STEEL TYPE C3", WHICH SHALL INCLUDE ALL STEEL ITEMS SHOWN.

POST BASE PLATES SHALL BE FLAT WITH ALL SURFACES SMOOTH AND FREE FROM WARP AND ALL EDGES SMOOTH, STRAIGHT AND VERTICAL. ALL PLATE CUTS SHALL BE MACHINE OR MACHINE FLAME CUTS.

ALL PLATES, BARS, AND RECTANGULAR SLEEVES SHALL CONFORM TO ASTM A709 GRADE 36. ALL STRUCTURAL TUBING SHALL CONFORM TO ASTM A500 GRADE B.

ANCHORAGES SHALL BE ACCURATELY PLACED TO PROVIDE CORRECT ALIGNMENT OF RAILING. SET NORMAL TO GRADE.

CUT BOTTOM OF POST TO MAKE POST VERTICAL IN BOTH TRANSVERSE AND LONGITUDINAL DIRECTION.

STEEL SHIMS SHALL BE PROVIDED & USED UNDER BASE PLATES WHERE REQUIRED FOR ALIGNMENT, AND SHALL BE GALVANIZED.

CAULK AROUND PERIMETER OF BASE PLATES, NO. 1, AND FILL BOLT SLOT OPENINGS IN SHIMS AND BASE PLATES WITH NON-STAINING GRAY NON-BITUMINOUS JOINT SEALER.

ALL JOINTS AND RECESSES IN CONCRETE PARAPET ARE TO BE VERTICAL.


ALL MATERIAL (EXCEPT NO. 3) SHALL BE GALVANIZED AFTER FABRICATION. PRIOR TO GALVANIZING, THE STEEL RAILING SHALL BE GIVEN A NO. 6 BLAST CLEANING PER SSPC SPECIFICATIONS. PAINT OVER GALVANIZING WITH AN APPROVED TIE COAT AND TOP COAT AS SPECIFIED IN THE CONTRACT DOCUMENTS. THE RAILING SHALL BE PAINTED AMS STD. COLOR NO. 27038, BLACK.

VENT HOLES SHALL BE DRILLED IN POST AND RAIL MEMBERS AS REQUIRED TO FACILITATE GALVANIZING AND DRAINAGE.


RAILING SHALL BE FABRICATED IN LENGTHS THAT INCLUDE 3 OR 4 POSTS.

TOUCH-UP PAINTING TO BE DONE AT COMPLETION OF STEEL RAILING INSTALLATION TO THE SATISFACTION OF THE ENGINEER AT NO EXTRA COST.


NO.	DATE		REVISION			BY	
		STATE DEPARTMENT	OF WISCONSI OF TRANSPO		N		
		STRUCT	JRE B-5	1-15	4		
			DRAWN BY PKF		PLANS CK'D.	BH	
		PARAPET		SHE	ET 23	OF 28	
	&	RAILING	- 2				

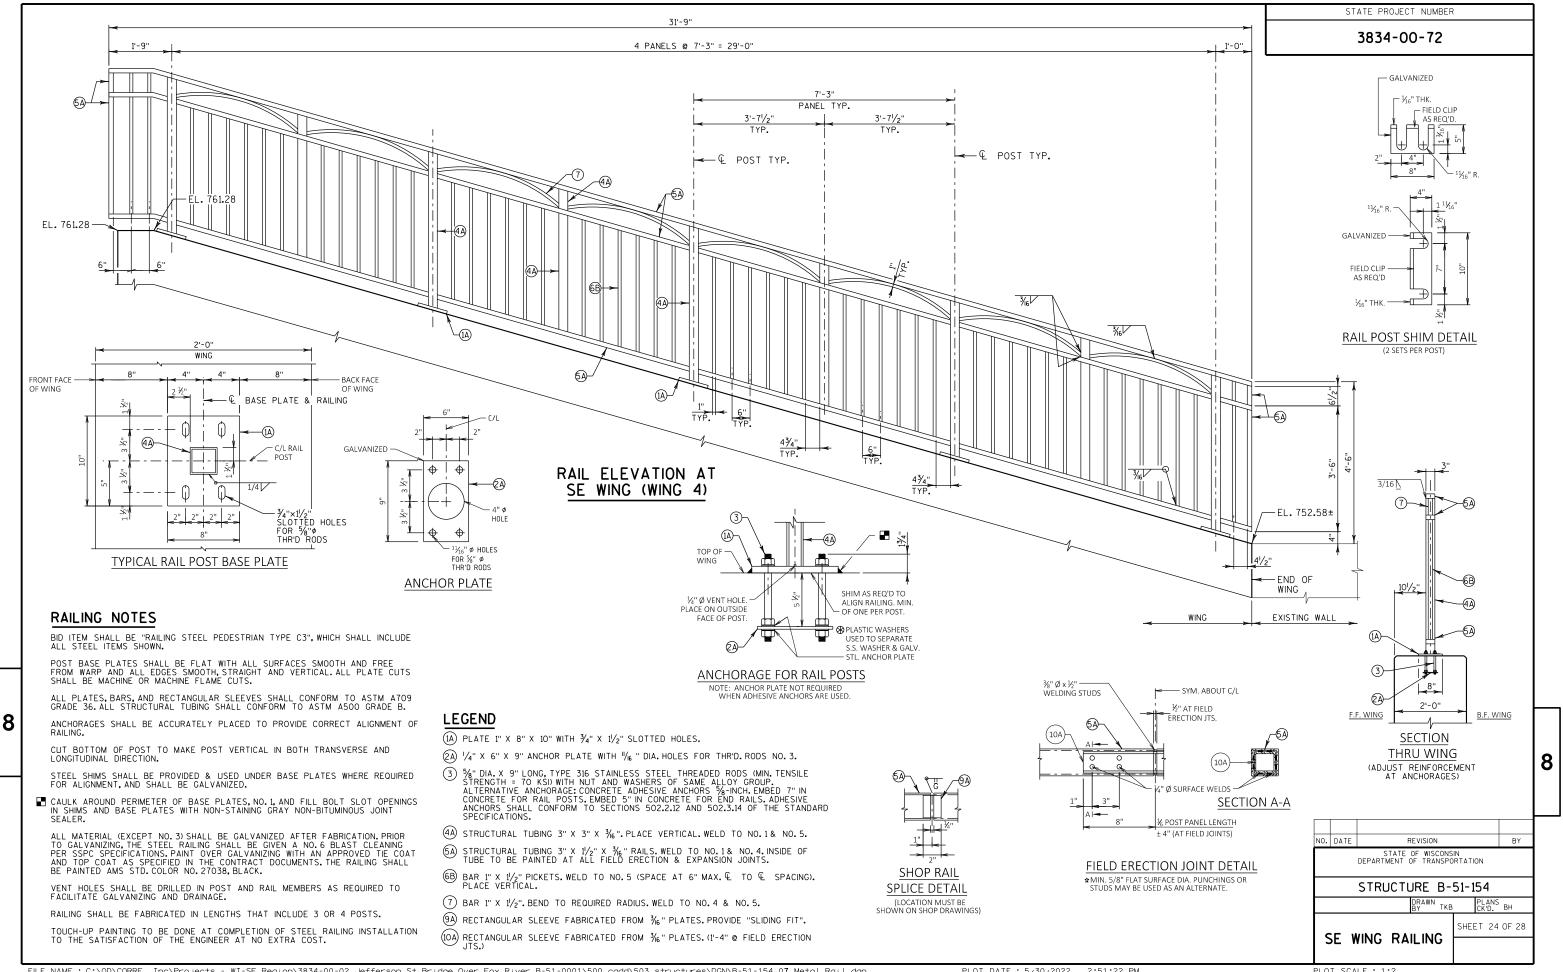

FILE NAME : C:\OD\CORRE. Inc\Projects - WI-SE Region\3834-00-02 Jefferson St_Bridge Over Fox River B-51-0001\500_cadd\503_structures\DGN\B-51-154_07 Metal Rail.dar

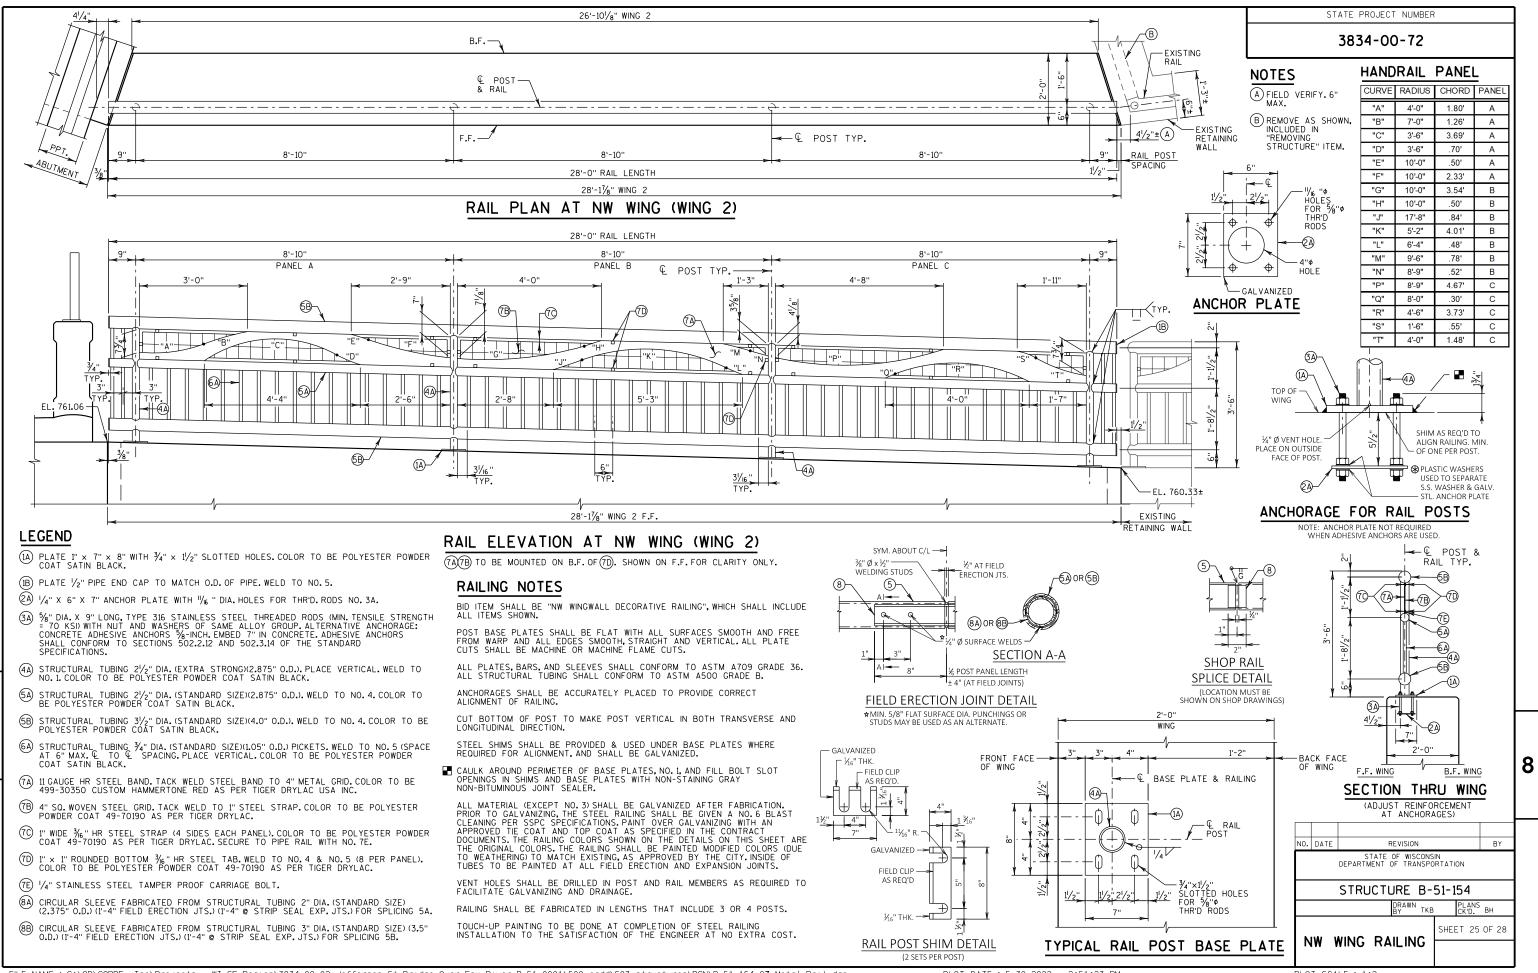

PLOT DATE : 5/30/2022 2:51:23 PM

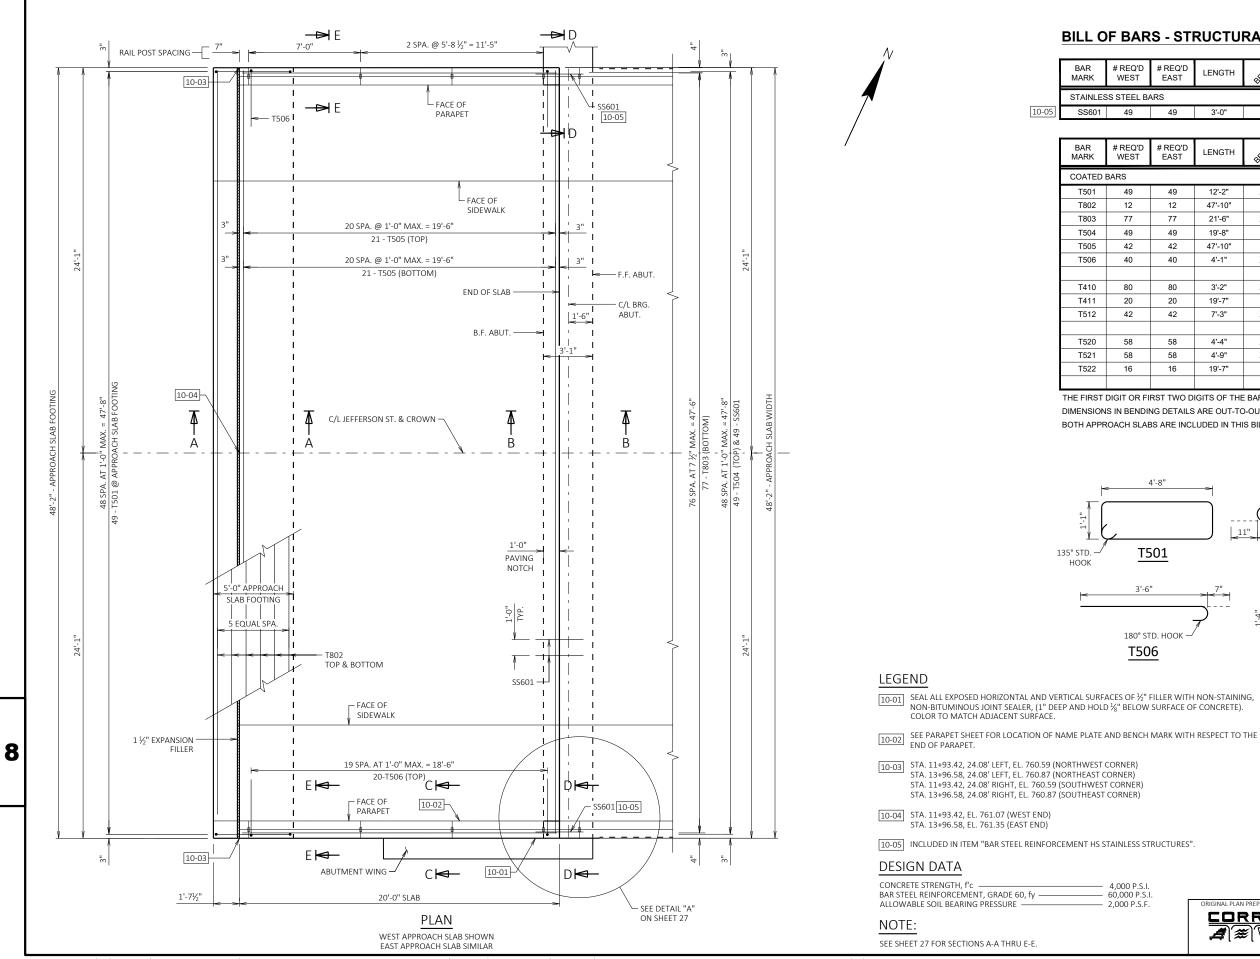

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PLOT DATE : 8/23/2022 4:47 PM

					STATE PROJECT NUMBER	
					3834-00-72	
2	S - STI	RUCTU	RAL	APPRO	DACH SLABS	
	# REQ'D EAST	LENGTH	BENT	BAR SERIES	LOCATION	
ł	ARS				TOTAL WEIGHT =	450 LBS
	49	3'-0"			STRUCTURE TO APPR. SLAB	LONGIT.
	# REQ'D EAST	LENGTH	BENT	BAR SERIES	LOCATION	
					TOTAL WEIGHT =	22,950 LBS
	49	12'-2"	Х		SLAB - FTG., STIRRUP	LONGIT.
	12	47'-10"			SLAB - FTG.	TRANS.
	77	21'-6"	Х		SLAB - BTM.	LONGIT.
	49	19'-8"			SLAB - TOP	LONGIT.
	42	47'-10"			SLAB - TOP & BTM.	TRANS.
	40	4'-1"	х		SLAB - TOP	TRANS.
	80	3'-2"	х		SIDEWALK	VERT.
	20	19'-7"			SIDEWALK	LONG.
	42	7'-3"	х		SIDEWALK	TRANS.
	58	4'-4"	x		PARAPETS	VERT.
	58	4'-9"	x		PARAPETS	VERT.
		-				

PARAPETS

LONG.

THE FIRST DIGIT OR FIRST TWO DIGITS OF THE BAR MARK SIGNIFIES THE BAR SIZE.

DIMENSIONS IN BENDING DETAILS ARE OUT-TO-OUT OF BAR

19'-7"

# REQ'D

49

# REQ'D

WEST

49

12

77

49

42

40

80

20

42

58


58

16


16

WEST

BOTH APPROACH SLABS ARE INCLUDED IN THIS BILL OF BARS

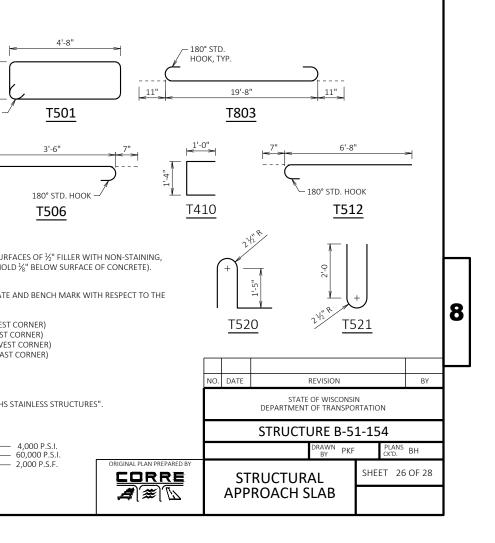


PAULETTE FENSKE PLOT BY :

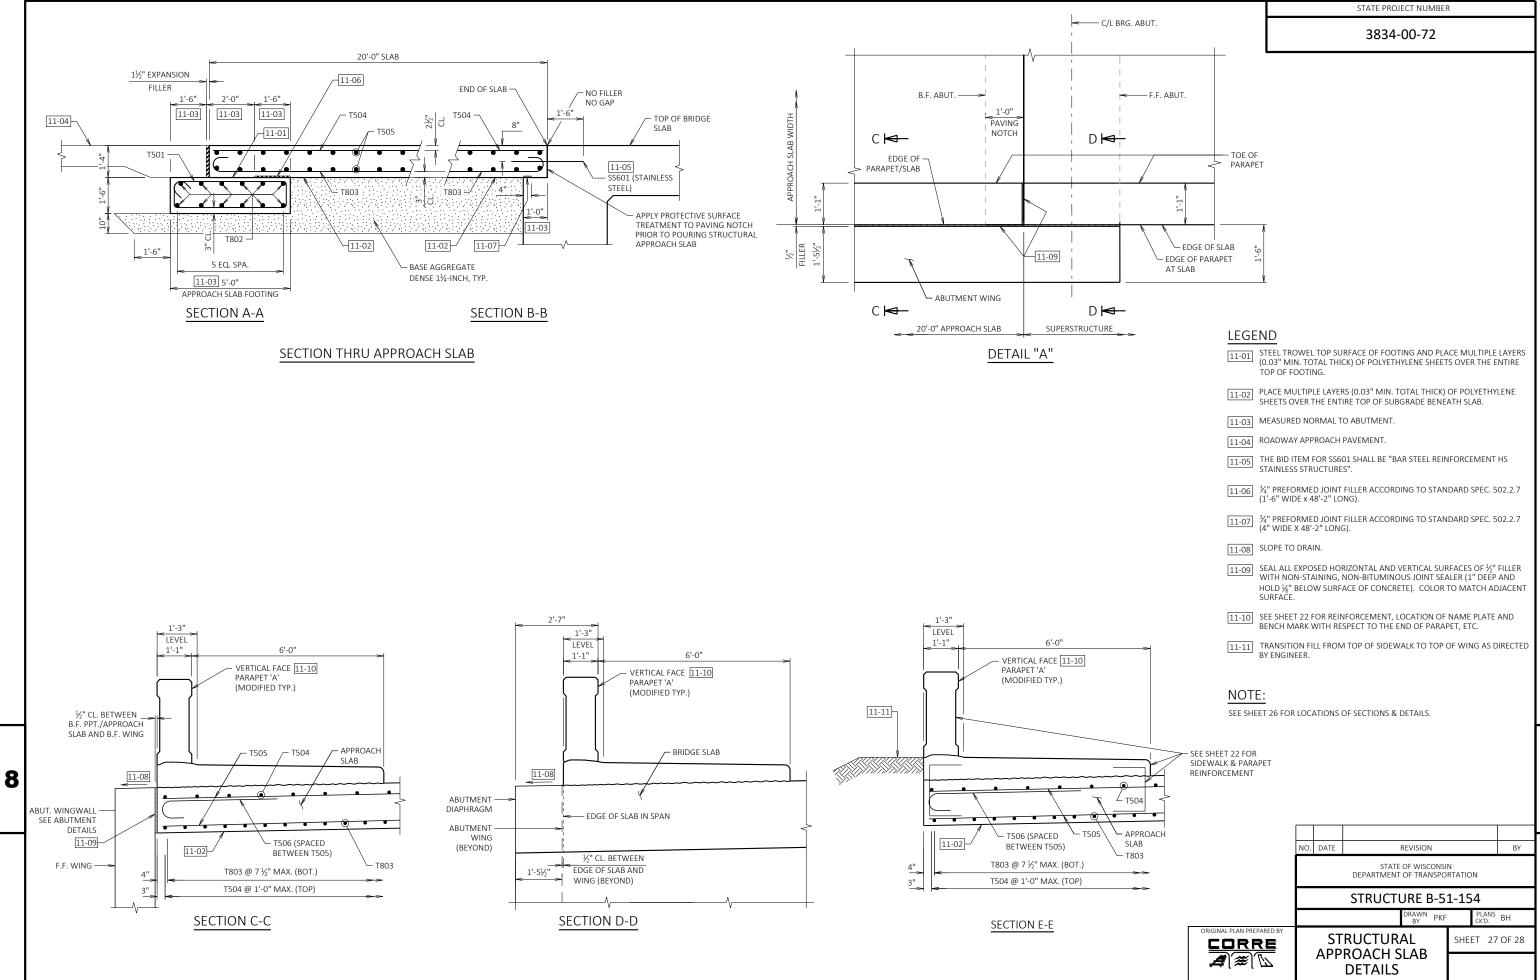

FILE NAME : C:\OD\CORRE, INC\PROJECTS - WI-SE REGION\3834-00-02 JEFFERSON ST_BRIDGE OVER FOX RIVER B-51-0001\500_CADD\503_STRUCTURES\502.4_FINAL\080901-APPRSLAB_JEFFERSONST.DWG PLOT DATE : 8/23/2022 4:47 PM

PAULETTE FENSKE PLOT BY :

	SEE SHEET 22 FOR SIDEWALK & PARAPET REINFORCEMENT						8	
l								ļ
		NO. DATE REVISION BY				BY		
		STATE OF WISCONSIN DEPARTMENT OF TRANSPORTATION						
		STRUCTURE B-51-154						
			DRAWN PKF PLANS BH					
	ORIGINAL PLAN PREPARED BY				SHEET 27			
	<b>#</b> ]´ <b>ﷺ</b> ]´ <b>\</b>	APPROACH SLAB DETAILS						

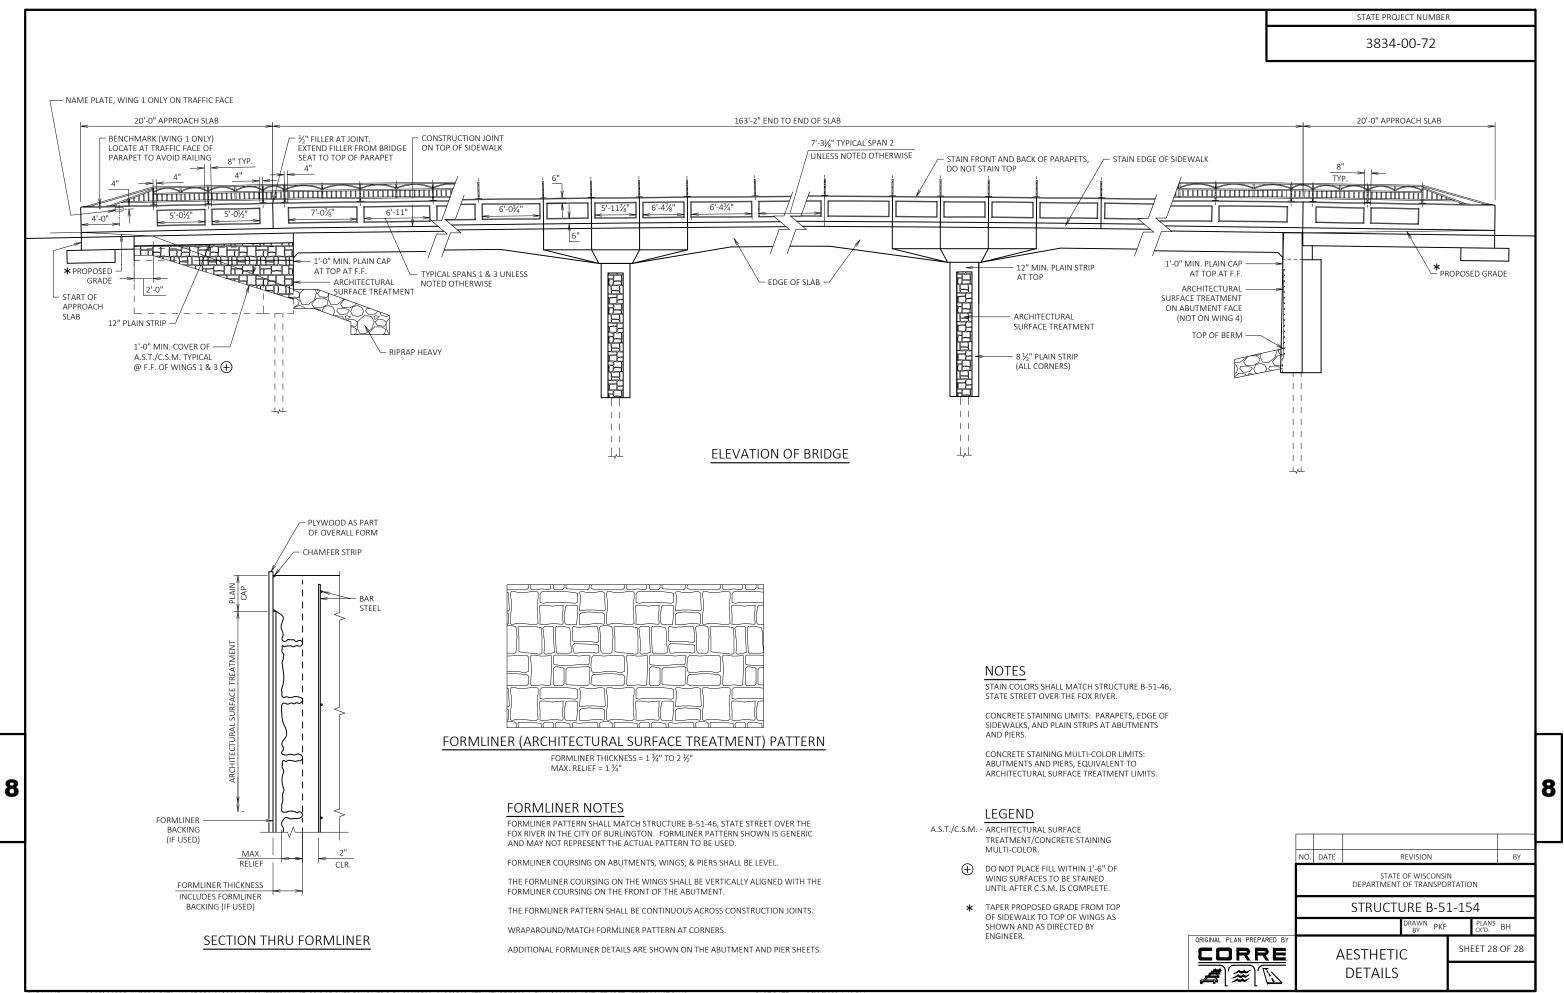

			AREA (SF)		Incremental Vol (CY) (Unadjusted)		Cumulative Vol (CY)		
STATION	Real Station	Distance	Cut	Fill	Cut	Fill	Cut 1.00	Expanded Fill 1.25	Mass Ordinate
					Note 1	Note 3	Note 1		Note 8
11+15	1115.00	0.00	83.51	0.00	0	0	0	0	0.00
11+42	1142.00	27.00	77.94	0.00	81	0	81	0	66.98
11+50	1150.00	8.00	76.42	0.00	23	0	104	0	85.77
11+55	1155.00	5.00	70.56	0.00	14	0	117	0	96.83
11+94	1194.00	39.00	55.17	0.00	91	0	208	0	167.78
13+96	1396.00	0.00	62.20	0.00	0	0	208	0	167.78
14+00	1400.00	4.00	60.04	0.00	9	0	217	0	174.79
14+30	1430.00	30.00	133.23	0.00	107	0	324	0	266.89
14+50	1450.00	20.00	54.86	1.28	70	0	394	0	325.97
14+95	1495.00	45.00	64.80	0.98	100	2	494	3	400.42


PROJECT NO:	PROJECT NO: 3834-00-72 HWY: JEFFERSON STREET		COUNTY: RACINE		EARTHWORK DATA		
FILE NAME : C:\OD\C	ORRE, INC\PROJECTS - DOCUMENTS\WI - SE REGION\3834-00-02 J	4/28/2022 2:51 PM	PLOT BY :	BEN KROLCZYK	PLOT NAME :		

PLOT SCALE : 1" = 1'


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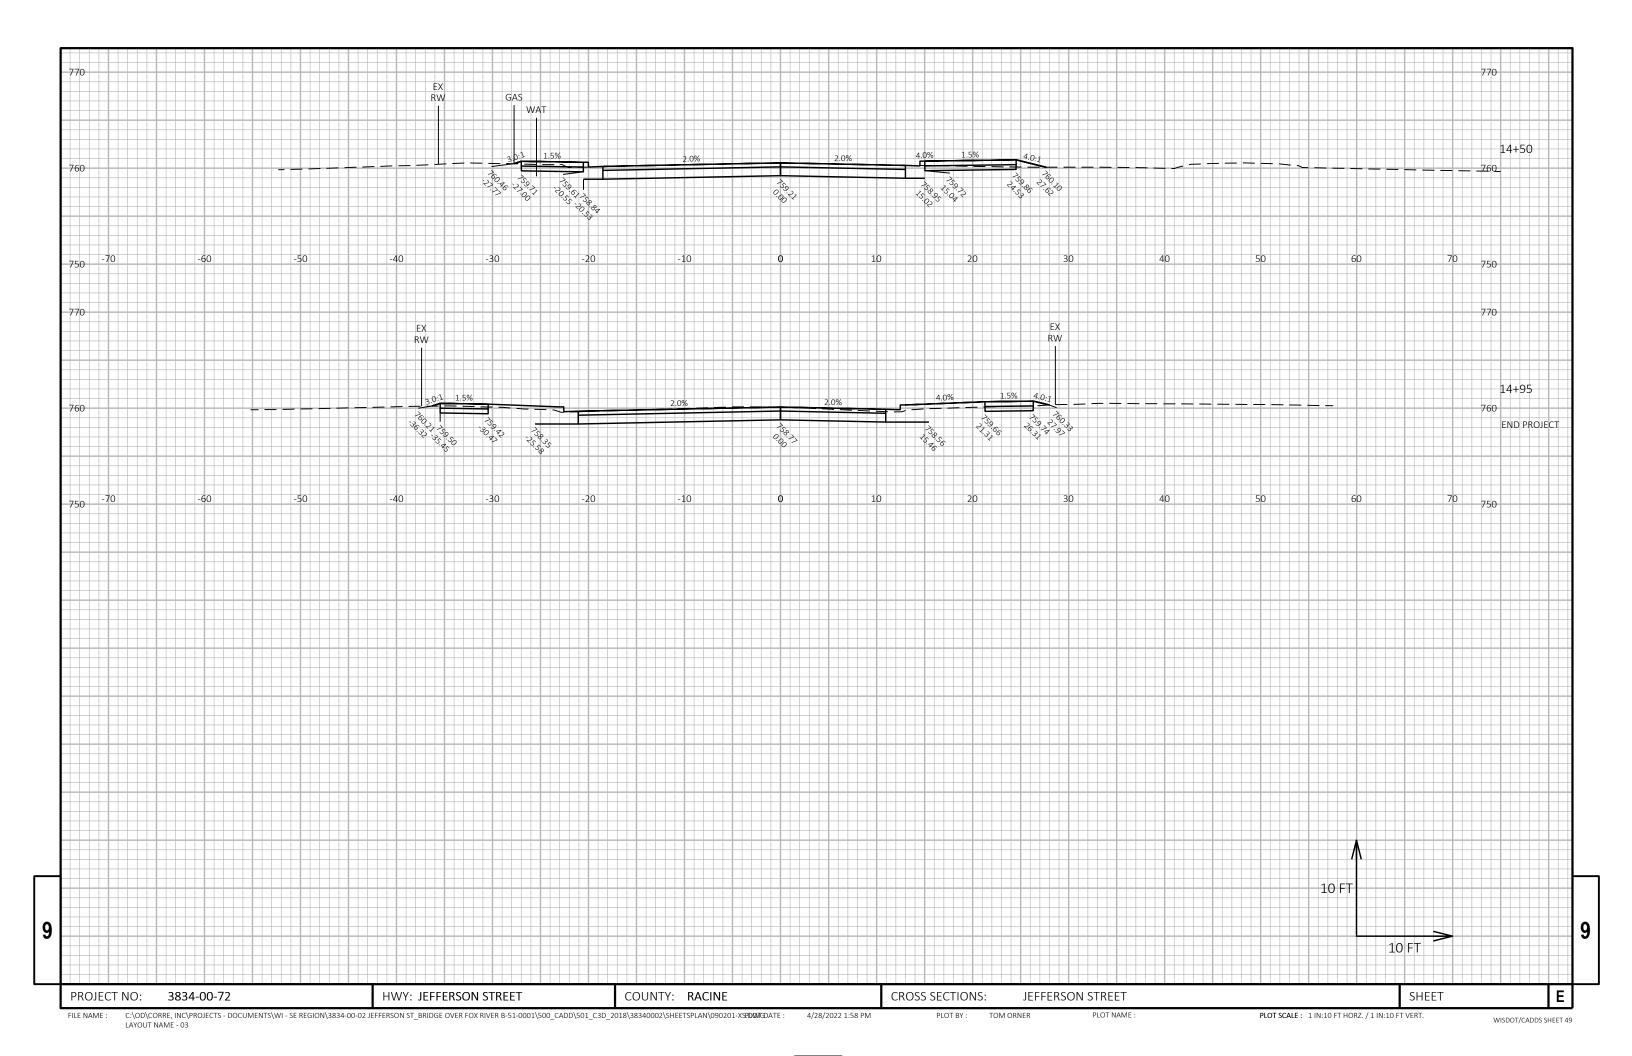
SHEET




WISDOT/CADDS SHEET 49

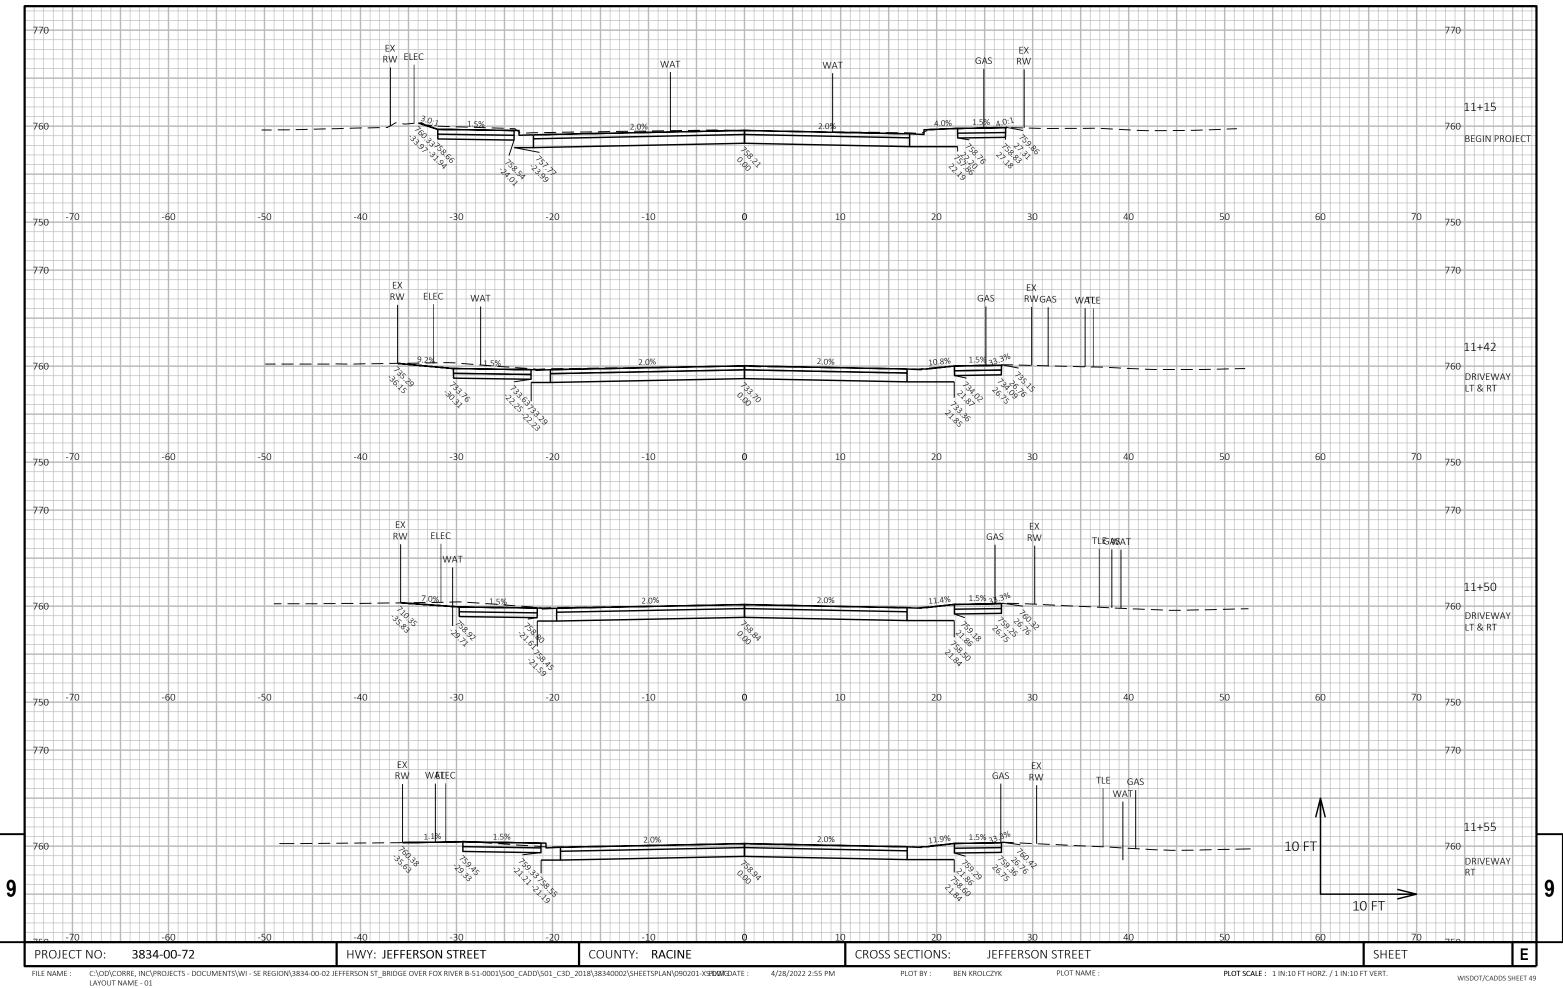

WISDOT/CADDS SHEET 49

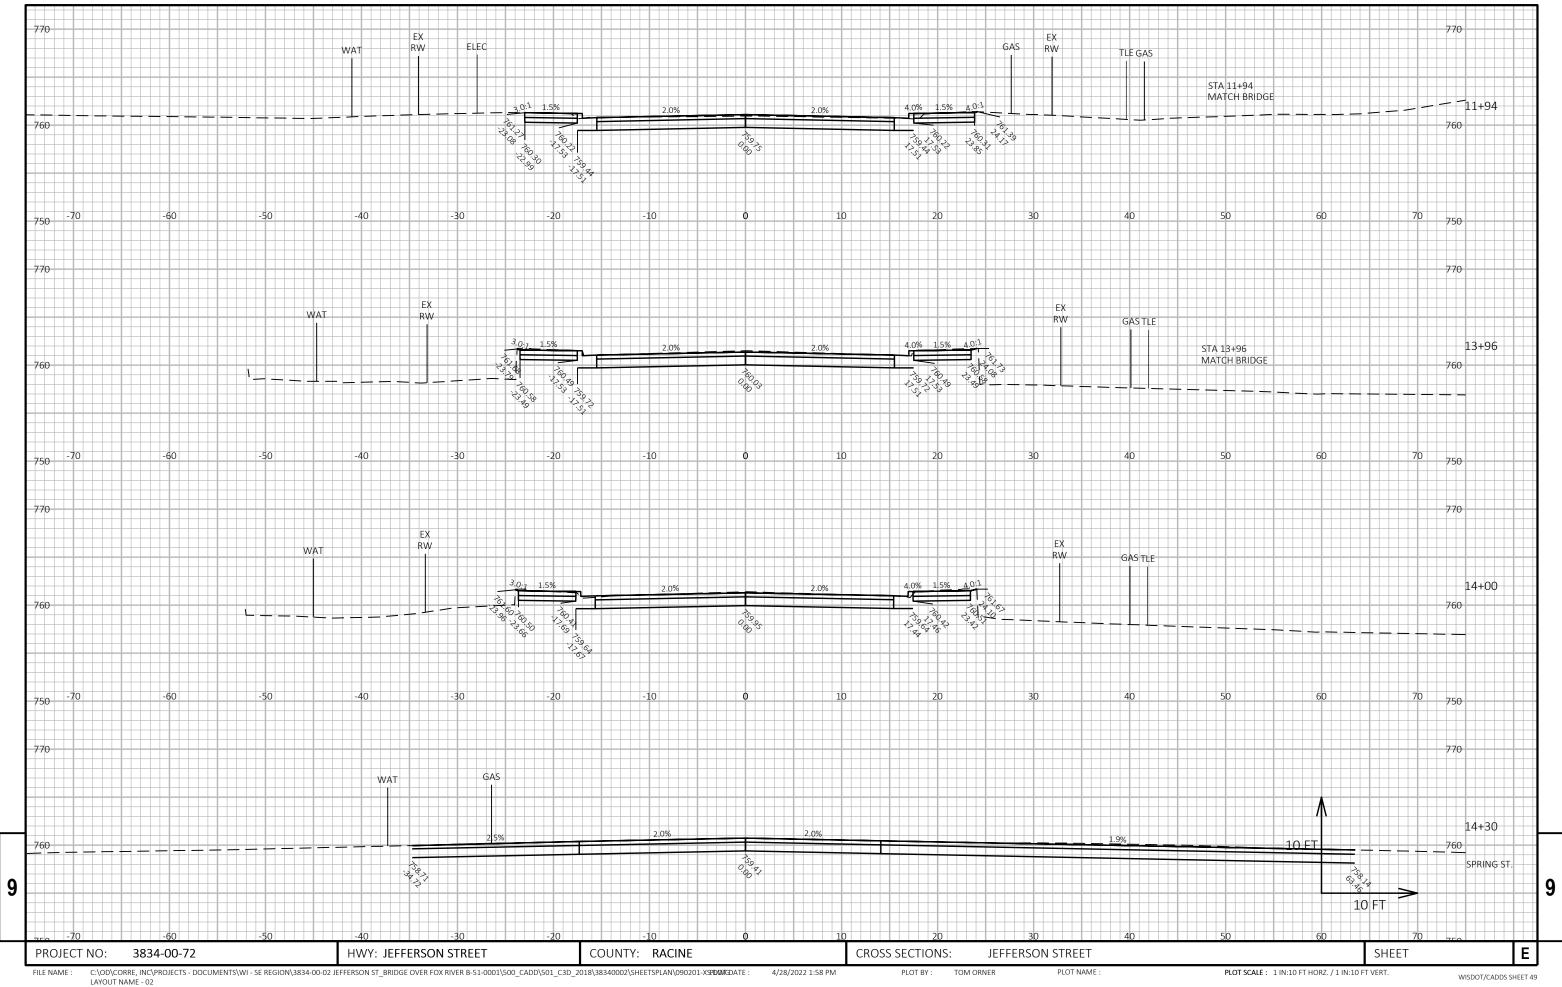

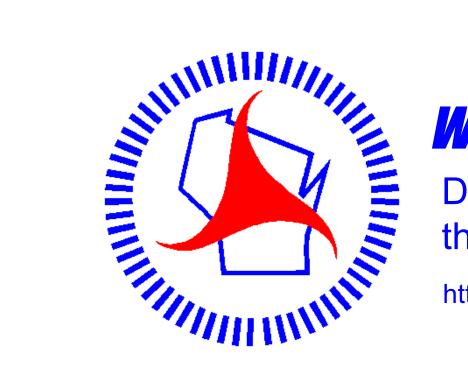

# Wisconsin Department of Transportation

Dedicated people creating transportation solutions through innovation and exceptional service.

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