

WITH

MA

ROCHELLE L. BURSA



UTILITIES

AT&T (COMMUNICATIONS) VICTORIA KASSAB 435 S 95TH ST MILWAUKEE, WI 53124 VK325D@ATT.COM (920) 401-7512

2

TIME WARNER CABLE (COMMUNICATIONS) KURT LITTLE 12405 POWERSCOURT DR ST LOUIS, MO 63131 CHTR.WI.CONST@CHARTER.COM (920) 831-9227

WISCONSIN PUBLIC SERVICE CORP -ELECTRIC AND GAS WENDY CHRIST P.O. BOX 19001 GREEN BAY, WI 54307 (920) 617-5173 UTILITIESRELOCATION@WISCONSINPUBLICSERVICE.COM

US SIGNAL (COMMUNICATIONS) RYAN MIEDEMA 20 MONROE AVE NW, STE 450 GRAND RAPIDS, MI 49503 (616) 233-7144 RJMIEDEMA@USSIGNAL.COM

SANITARY, WATER Village of Wrightstown SUPERINTENDENT OF PUBLIC WORKS ANDY VICKMAN 352 HIGH STREET WRIGHTSTOWN, WI 54180 (920) 532-0434 EXT 42 AVICKMAN@WRIGHTSTOWN.US

RUNOFF COEFFICIENT TABLE

					HYDR	OLOGIC SOIL GF	ROUP					
		А			В		С				D	
	SLOPE	RANGE	(PERCENT)	SLOPE	RANGE	(PERCENT)	SLOP	e rang	E (PERCENT)	SLOPE	RANG	E (PERCENT)
LAND USE:	0-2	2-6	6 & OVER	0-2	2-6	6 & OVER	0-2	2-6	6 & OVER	0-2	2-6	6 & OVER
ROW CROPS	.08 .22	.16 .30	.22 .38	.12 .26	.20 .34	.27 .44	.15 .30	.24 .37	.33 .50	.19 .34	.28 .41	.38 .56
MEDIAN STRIP- TURF	.19 .24	.20 .26	.24 .30	.19 .25	.22 .28	.26 .33	.20 .26	.23 .30	.30 .37	.20 .27	.25 .32	.30 .40
SIDE SLOPE- TURF			.25 .32			.27 .34			.28 .36			.30 .38
PAVEMENT:		1	1		1	1	- 1	1	1		1	1
ASPHALT					.70	95						
CONCRETE					.80	95						
BRICK					.70	80						
DRIVES, WALKS					.75	85						
ROOFS					.75	95						
GRAVEL ROADS,	SHOULD	ERS			.40	60						

1. THE LOCATIONS OF EXISTING AND PROPOSED UTILITY INSTALLATIONS AS SHOWN ON THE PLANS ARE APPROXIMATE. THERE MAY BE OTHER UTILITY INSTALLATIONS WITHIN THE PROJECT AREA THAT ARE NOT SHOWN.

2. PROPERTY LINES AS SHOWN ARE APPROXIMATE.

CONTACTS

ROBERT E. LEE & ASSOCIATES, INC. JENNIFER S LIIMATTA 1250 CENTENNIAL CENTRE BOULEVARD HOBART, WI. 54155 (920) 662-9641 JLIIMATTA@RELEEINC.COM

WDNR CONTACT JIM DOPERLASKI, JR. 2984 SHAWANO AVE GREEN BYA, WI 54313 (920)412-0165 JAMES.DOPERALSKI@WISCONSIN.GOV

			<u>standard a</u>	BBREVIA	TIONS		
GR	GRAVEL	WM	WATERMAIN	VPC	VERTICAL POINT OF CURVATURE	R∕W	RIGHT OF WAY
BIT	BITUMINOUS	HYD	HYDRANT	VPI	VERTICAL POINT OF INTERSECTION	T/C	TOP OF CURB
ASPH	ASPHALT PAVEMENT	W∨	WATER VALVE	VPT	VERTICAL POINT OF TANGENCY	F/L	FLOW LINE
CONC	CONCRETE	SAN	SANITARY SEWER	PC	POINT OF CURVATURE	C/L	CENTERLINE
SW	SIDEWALK	MH	MANHOLE	PI	POINT OF INTERSECTION	P/L	PROPERTY LINE
BLDG	BUILDING	ST	STORM SEWER	PT	POINT OF TANGENCY	R/L	REFERENCE LINE
HSE	HOUSE	СВ	CATCH BASIN	R	RADIUS	INV	INVERT
PED	PEDESTAL	TELE	TELEPHONE	EX	EXISTING	СМР	CORRUGATED METAL PIPE
PP	POWER POLE	ELEC	ELECTRIC	PR	PROPOSED	RCP	REINFORCED CONCRETE PIPE
LP	LIGHT POLE	ΤV	TELEVISION	EOR	END OF RADIUS	CULV	CULVERT
ВМ	BENCH MARK	STA	STATION	B-B	BACK TO BACK (OF CURB)	PE	PERSONAL ENTRANCE
CE	COMMERCIAL ENTRANCE	FE	FIELD ENTRANCE	E.O.P.	EDGE OF PAVEMENT		

TOTAL PROJECT AREA = 1.14 ACRES

TOTAL AREA EXPECTED TO BE DISTURBED BY CONSTRUCTION ACTIVITIES = 0.0 ACRES

PROJECT NO:	4519-20-70	HWY: ALISON COURT	COUNTY: BROWN		PLAN: GENERAL	NOTES	
FILE NAME : R:\1200\12	269\1269083\DWG\020101 GN.DWG		PLOT DATE :	9/14/2022 3:39 PM	PLOT BY :	RYAN H. TRZINSKI	PLOT NAME :


WG\020101_GN.DWG LAYOUT NAME - 01

PLOT DATE : 9/14/2022 3:39 PM

GENERAL NOTES

3. ALL CURB RADII DIMENSIONS ON THE PLAN ARE MEASURED TO FLANGE LINE.

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PROJECT NO: 4519-20-70	HWY: ALISON COURT	COUNTY: BROWN		PLAN: TYP	PICAL SECTIONS	
FILE NAME : R:\1200\1269\1269083\DWG\020301_TS.DWG		PLOT DATE :	7/5/2022 2:06 PM	PLOT B	Y : ROCHELLE L. BURSA	PLOT NAME :

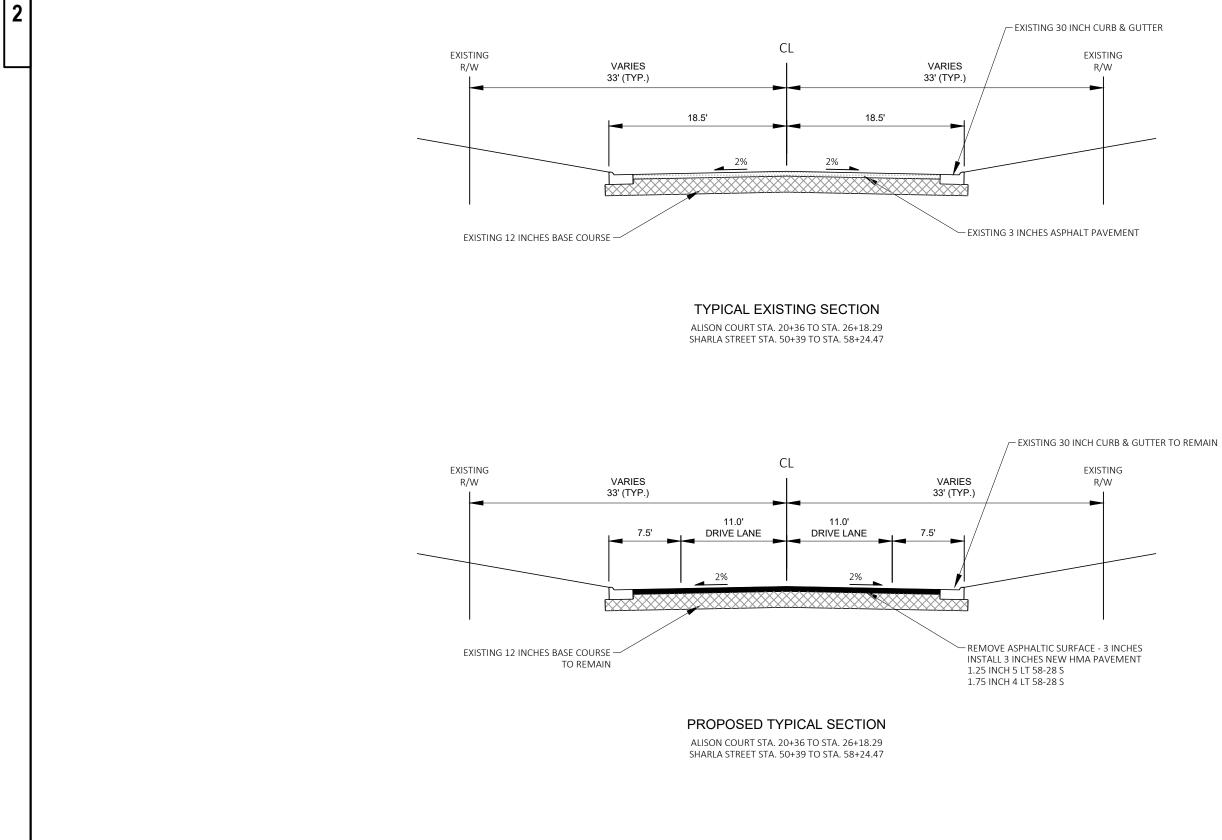
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TWO CONTINUOUS STRIPS OF 1/2" JOINT SEAL OR EQUAL BETWEEN ADJUSTING RINGS AND CASTING. COAT OUTSIDE OF ADJUSTING RINGS ONLY WITH SEWER JOINT COMPOUND AND WRAP WITH MIN. 6 MIL POLYETHYLENE.

SAWCUT FULL DEPTH ~ - PROPOSED HMA PAVEMENT EXISTING HMA PAVEMENT EXISTING SUBGRADE -

BUTT JOINT DETAIL


PROJECT NO: 4519-20-70	HWY: ALISON COURT	COUNTY: BROWN		CONSTRUCTION	I DETAILS	
FILE NAME : R:\1200\1269\1269083\DWG\021001_CD.DWG		PLOT DATE :	8/8/2022 11:01 AM	PLOT BY :	JORDAN RYNISH	PLOT NAME :

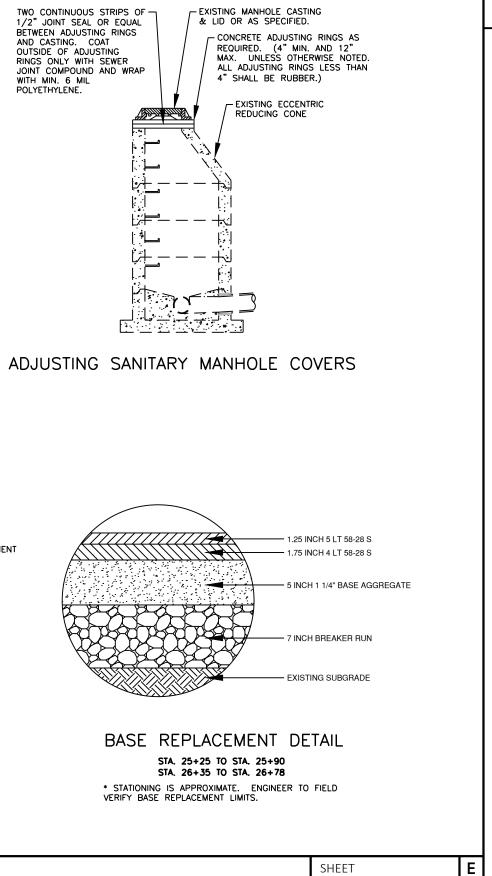

PLOT SCALE : 1 IN:10 FT

WISDOT/CADDS SHEET 42

			E	stimate Of C	antities	
					4519-20-70	
Line	Item	Item Description	Unit	Total	Qty	
0002	204.0110	Removing Asphaltic Surface	SY	5,650.000	5,650.000	
0004	205.0100	Excavation Common	CY	300.000	300.000	
0006	211.0101	Prepare Foundation for Asphaltic Paving (project) 01. 4519-20-70	EACH	1.000	1.000	
8000	213.0100	Finishing Roadway (project) 01. 4519-20-70	EACH	1.000	1.000	
0010	305.0120	Base Aggregate Dense 1 1/4-Inch	TON	290.000	290.000	
0012	311.0110	Breaker Run	TON	340.000	340.000	
0014	455.0605	Tack Coat	GAL	400.000	400.000	
0016	460.2000	Incentive Density HMA Pavement	DOL	678.400	678.400	
0018	460.5224	HMA Pavement 4 LT 58-28 S	TON	610.000	610.000	
0020	460.5225	HMA Pavement 5 LT 58-28 S	TON	450.000	450.000	
0022	618.0100	Maintenance And Repair of Haul Roads (project) 01. 4519-20-70	EACH	1.000	1.000	
0024	619.1000	Mobilization	EACH	1.000	1.000	
0026	624.0100	Water	MGAL	4.000	4.000	
0028	628.1905	Mobilizations Erosion Control	EACH	2.000	2.000	
0030	628.1910	Mobilizations Emergency Erosion Control	EACH	1.000	1.000	
0032	628.7015	Inlet Protection Type C	EACH	4.000	4.000	
0034	642.5001	Field Office Type B	EACH	1.000	1.000	
0036	643.0300	Traffic Control Drums	DAY	320.000	320.000	
0038	643.0420	Traffic Control Barricades Type III	DAY	45.000	45.000	
0040	643.0705	Traffic Control Warning Lights Type A	DAY	90.000	90.000	
0042	643.0900	Traffic Control Signs	DAY	70.000	70.000	
0044	643.5000	Traffic Control	EACH	1.000	1.000	
0046	650.5000	Construction Staking Base	LF	145.000	145.000	
0048	650.8000	Construction Staking Resurfacing Reference	LF	1,428.000	1,428.000	
0050	650.9911	Construction Staking Supplemental Control (project) 01. 4519-20-70	EACH	1.000	1.000	
0052	690.0150	Sawing Asphalt	LF	64.000	64.000	
0054	ASP.1T0A	On-the-Job Training Apprentice at \$5.00/HR	HRS	600.000	600.000	
0056	ASP.1T0G	On-the-Job Training Graduate at \$5.00/HR	HRS	300.000	300.000	
0058	SPV.0060	Special 01. Adjusting Sanitary Manhole Covers	EACH	4.000	4.000	
0060	SPV.0060	Special 02. Adjusting Water Valve Boxes	EACH	1.000	1.000	

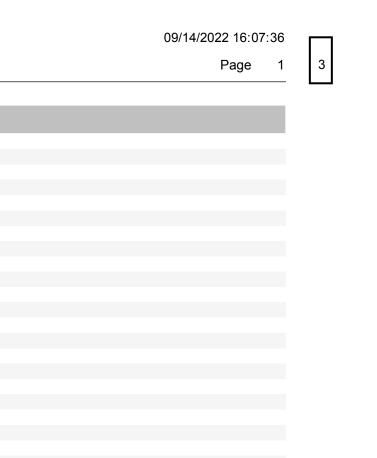

	<u>EX</u>	CAV	ATION C	<u>ommon</u>	
					205.0100
					EXCAVATION
					COMMON
CATEGORY	STA	то	STA	LOCATION	CY
0010	25+25	-	25+90	ALISON CT	78
0010	26+35	-	26+78	CUL DE SAC	169
0010		UN	IDISTRIB	UTED	53
				TOTAL	300


			<u>P/</u>	AVEMENT REI	MOVAL	
					204.0110	211.0101
					REMOVING	PREPARE FOUNDATION
					ASPHALTIC	FOR ASPHALTIC PAVING
					SURFACE	(PROJECT)
CATEGORY	STA	то	STA	LOCATION	SY	EA
0010	20+36	-	50+39	4519-20-70		1
0010	20+36	-	26+78	ALISON CT	2,787	
0010	50+39	-	58+25	SHARLA ST	2,795	
0010		UN	DISTRIB	UTED	68	
				TOTAL	5,650	1


					BASEAGO	REGATE		
					DROEFICE		311 0110	624.0100
						BASE AGGREGATE		
						DENSE 1 1/4-INCH	RUN	WATER
CATEG	ORY	STA	то	STA	LOCATION	TON	TON	MGAL
001	.0	25+25	-	25+90	ALISON CT	65	81	1
001	.0	26+35	-	26+78	CUL DE SAC	141	177	2
001	.0		UNE	DISTRIBU	JTED	84	82	1
					TOTALS	290	340	4

PROJECT NO: 4519-20-70	HWY: ALISON CT	COUNTY: BROWN	MISCELLANEOUS QUANTITIES
	-		

PLOT DATE : 8/8/2022 2:40 PM PLOT BY : JORDAN RYNISH PLOT NAME :

<u>FINI</u>	SHING ROAD	NAY
		213.0100
CATEGORY	PROJECT	EACH
0010	4519-20-70	1
	TOTAL	1

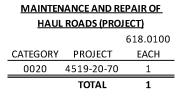

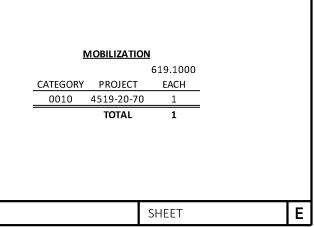

PLOT SCALE : 1" = 1'

WISDOT/CADDS SHEET 42

		ATIONS				EROS	ON CONTR	ROL DEVICES	
	628.1905 MOBILIZATIONS EROSION	628.1910 MOBILIZATIONS EMERGENCY							628.7015 INLET PROTECTION TYPE C
PROJECT	CONTROL EA	EROSION CONTROL EA		CATEGORY	STA	то	STA	LOCATION	EA
4519-20-70	2	1	_	0010	20+36		26+78	ALISON CT	2
TOTALS	2	1	=	0010	50+39	-	58+25	SHARLA ST	2 4
								TOTAL	-

TRAFFIC CONTROL ITEMS										
			643.0	300	643.	0420	643.	0705	643.	0900
		PROJECT	TRAFFIC C	ONTROL	TRAFFIC	CONTROL	TRAFFIC	CONTROL		
		DURATION	DRU	MS*	BARRICAD	ES TYPE III	WARNING LIGHTS TYPE A		TRAFFIC CONTROL SIGNS	
CATEGORY	LOCATION	DAYS	EACH	DAYS	EACH	DAYS	EACH	DAYS	EACH	DAYS
0010	4519-20-70	10	29	290	4	40	8	80	6	60
0010	UNDISTRIBUTED			30		5		10		10
		TOTALS		320		45		90		70

*NOTE: TRAFFIC CONTROL DRUMS AVAILABLE FOR PROTECTING MANHOLES, WATER VAVLE BOXES, BASE REPLACEMENT AREAS, OR OTHER MISCELLANEOUS NEEDS FOR CONSTRUCTION OPERATIONS

PROJECT NO: 4519-20-70	HWY: ALISON CT	COUNTY: BROWN	MISCELLANEOUS QUANTITIES

CATEGORY PROJECT 0010 4519-20-70

FIELD OFFICE TYPE B

	TOTAL	1
0010	4519-20-70	1
CATEGORY	PROJECT	EACH
		642.5001

TRAFFIC CONTROL

	TOTAL	1
0010	4519-20-70	1
CATEGORY	PROJECT	EACH
		643.5000

WISDOT/CADDS SHEET 42

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CONSTRUCTION STAKING										
		650.5000	650.8000	650.9911						
		CONSTRUCTION CONSTRUCTION STAKING STAKING BASE RESURFACING REFERENCE		CONSTRUCTION STAKING						
				SUPPLEMENTAL						
		STARING DASE	NESON ACING NEPENDICE	CONTROL (PROJECT)						
CATEGORY STA TO S	TA LOCATION	LF	LF	EA						
0010 20+36 - 26	+78 ALISON CT	145	642	1						
0010 50+39 - 58	+25 SHARLA ST	No. 144	786	99 task						
	TOTALS	145	1,428	1						

		TOTAL	64				
0010	50+39	CLAY ST	32				
0010	20+36	HIGHLAND ST	32				
CATEGORY	STATION	LOCATION	LF				
			ASPHALT				
			SAWING				
			690.0150				
SAWING ASPHALT							

ADJUSTING UTILITIES										
SPV.0060.01 SPV.0060.02										
					ADJUSTING SANITARY	ADJUSTING WATER				
					MANHOLE COVERS	VALVE BOXES				
CATEGORY	STA	то	STA	LOCATION	EA	EA				
0020	20+36	-	26+78	ALISON CT	2	—				
0020	50+39	-	58+25	SHARLA ST	2	1				
				TOTALS	4	1				


PROJECT NO:	4519-20-70	HWY: ALISON CT	COUNTY: BROWN			MISCELLANEOU	IS QUANTITIES	
D\4200\4				BLOT BATE	0/0/2022 40 52 444	BLOT BY		DI OT NIANAE


3

SHEET

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		VW-160-C-17 NICOLE VESSER 231 ALISON COURT	VW-160-C-16 NICOLE VESSER 235 ALISON COUR PI STA = 21+76.87 Y = 499454.617 X = 62308.389 DELTA = 33°05'45" LT D = 21°27'33" T = 79.33' L = 154.23' R = 267.00' PC STA = 20+97.54 Y = 499497.566 X = 62241.688 PT STA = 22+51.77 Y = 499455.058 X = 62387.720 DB = S57°13'21"E DA = N89°40'54"E	VW-160-C-15 THOMAS S & AMANDA K DARDEN 239 ALISON COURT	J JOANIS LIVING TRUST 243 ALISON COURT 30" CONCRETE CURE AND GUTTER TO REMAIN (TYP.)		ANN D URT W (TYP.)	17
5	W-160-G-1 BRAD D AMENSON 228 ALISON COURT	VW-160-C- LELAND & PAMEL REVOCABLE LIVIN 232 ALISON C	22+00	VW-I60-G-3 PATRICK SCHOMAKER 236 ALISON COURT	ADJUSTING SANITARY MANHOLE COVER VW-160-G-4 EMMA E ALBERTS 240 ALISON COURT	EDGE OF ASPHA (TYP.) VW-160-G-5 JOSHUA E & NICC VERBETEN 244 ALISON CO	REMOVE E AGGREGATI 7" BREAKE LT AGGREGATI	E AND INS
		REMOVE ASPHALTIC S 3 INCHES INSTALL 3 INCHES HN UPPER - 1.25 INCHES LOWER - 1.75 INCHES	IA PAVEMENT 5 LT 58-28S			BM # Station BM 53 22+51.77	ark Table Offset Elevation 27.84L 653.28 3.20R 650.96	n [FLAG BO TAG BOL
	PROJECT NO: 4519-20-70	HWY: ALISON COURT	C	OUNTY: BROWN	PLAN: A	LISON COURT		



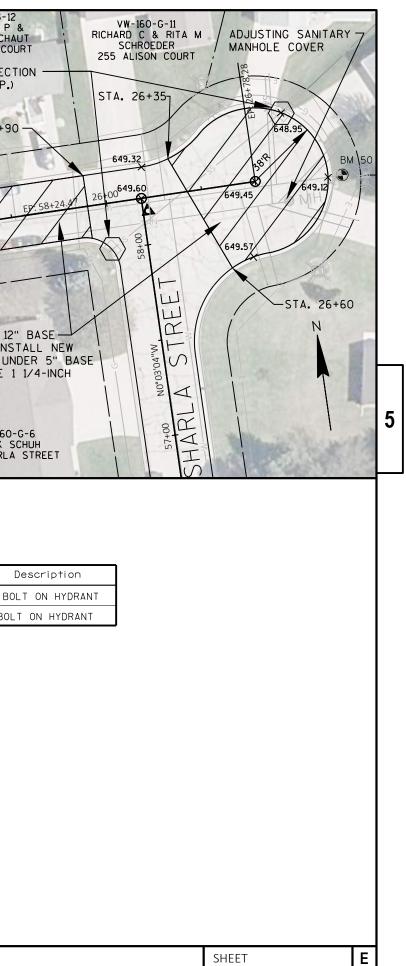


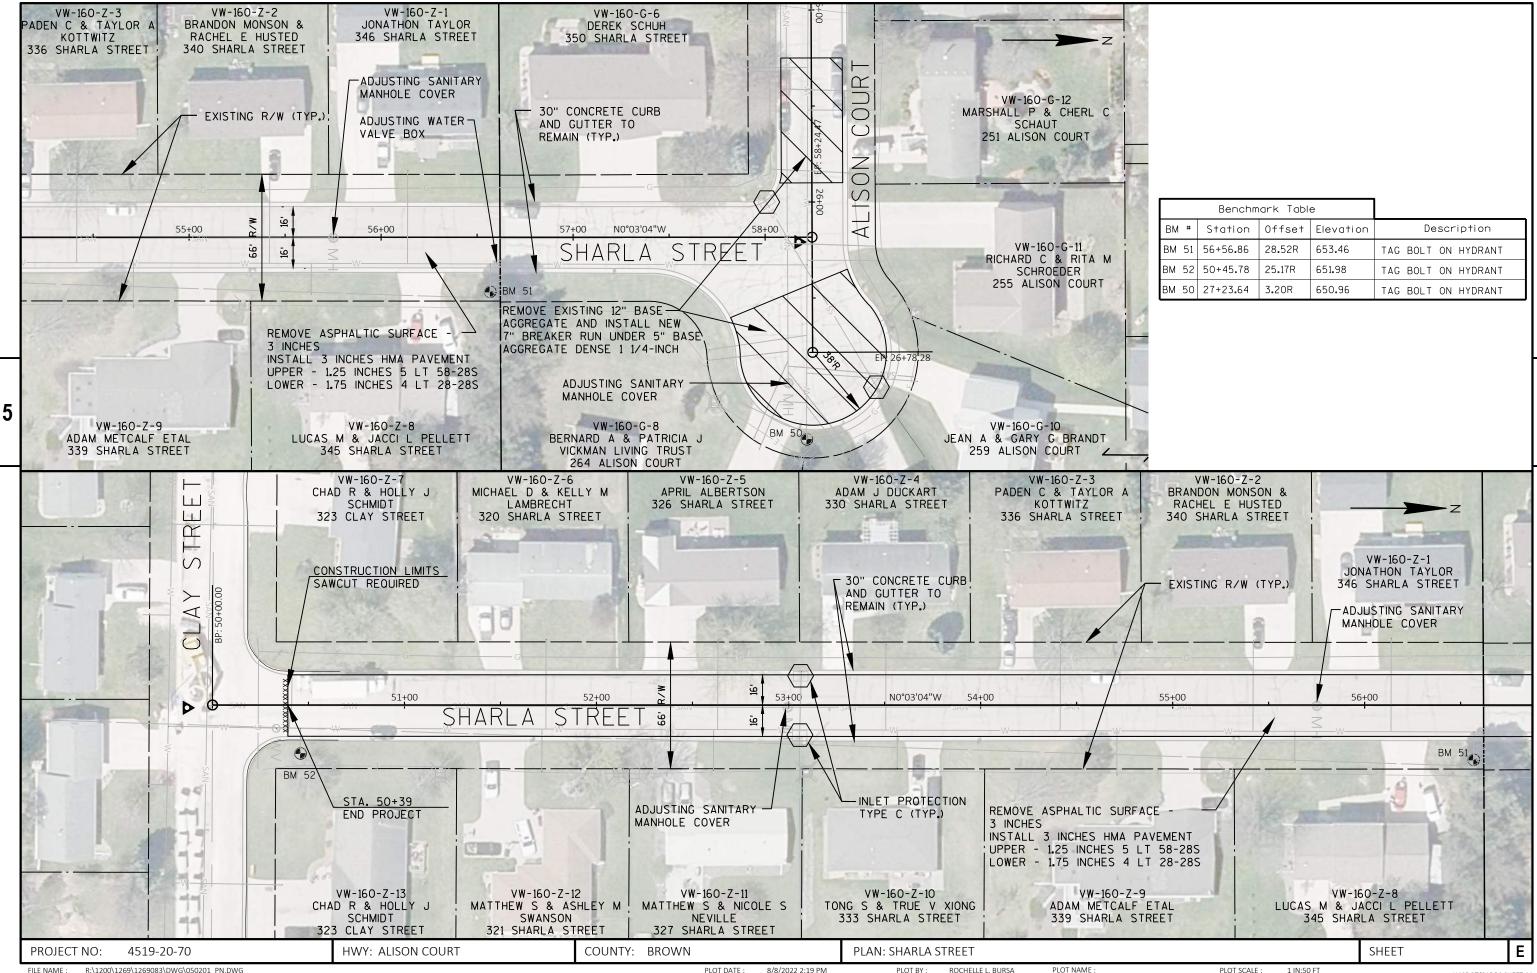PLOT BY : ROCHELLE L. BURSA PLOT DATE : 8/8/2022 2:19 PM


Benchmark Table					
BM 4	#	Station	Offset	Elevation	Description
BM 5	51	56+56.86	28.52R	653.46	TAG BOLT ON HYDRANT
BM 5	52	50+45.78	25 . 17R	651.98	TAG BOLT ON HYDRANT
BM 5	50	27+23.64	3.20R	650.96	TAG BOLT ON HYDRANT


Standard Detail Drawing List


08E10-02	INLET PROTECTION TYPE A, B, C AND D
13C19-03	HMA LONGITUDINAL JOINTS
15C02-08A	BARRICADES AND SIGNS FOR MAINLINE CLOSURES
15C05-05	TRAFFIC CONTROL, ADVANCE WARNING SIGNS 40 M.P.H. OR LESS
15С11-09В	CHANNELIZING DEVICES DRUMS, CONES, BARRICADES AND VERTICAL PANELS

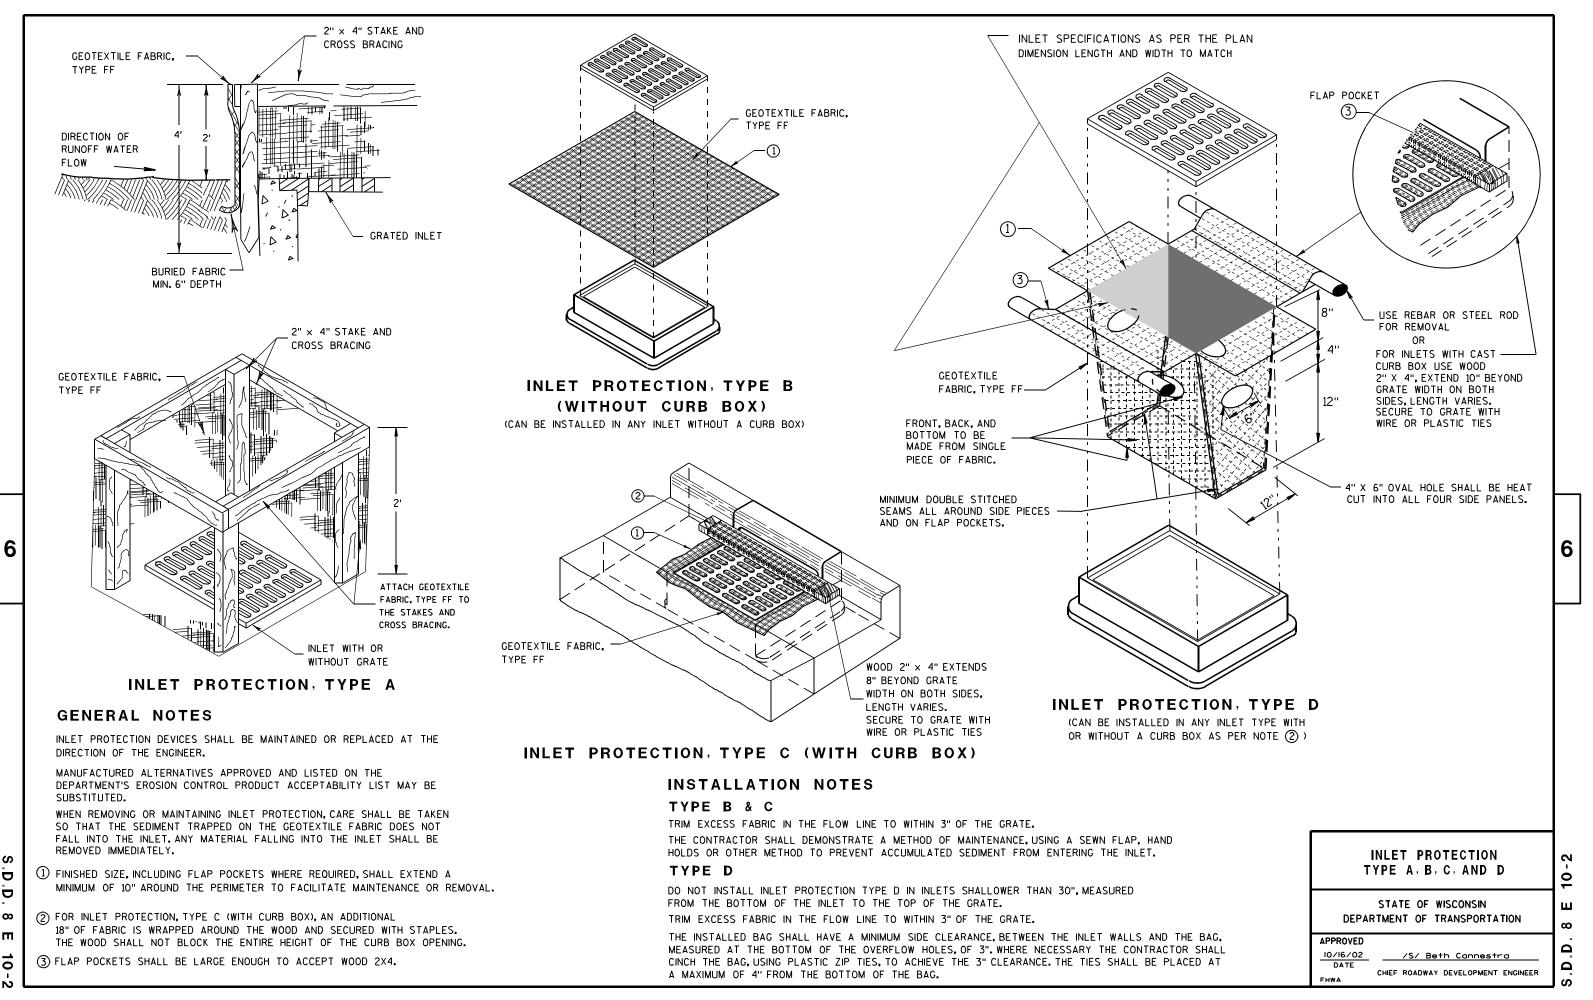


O

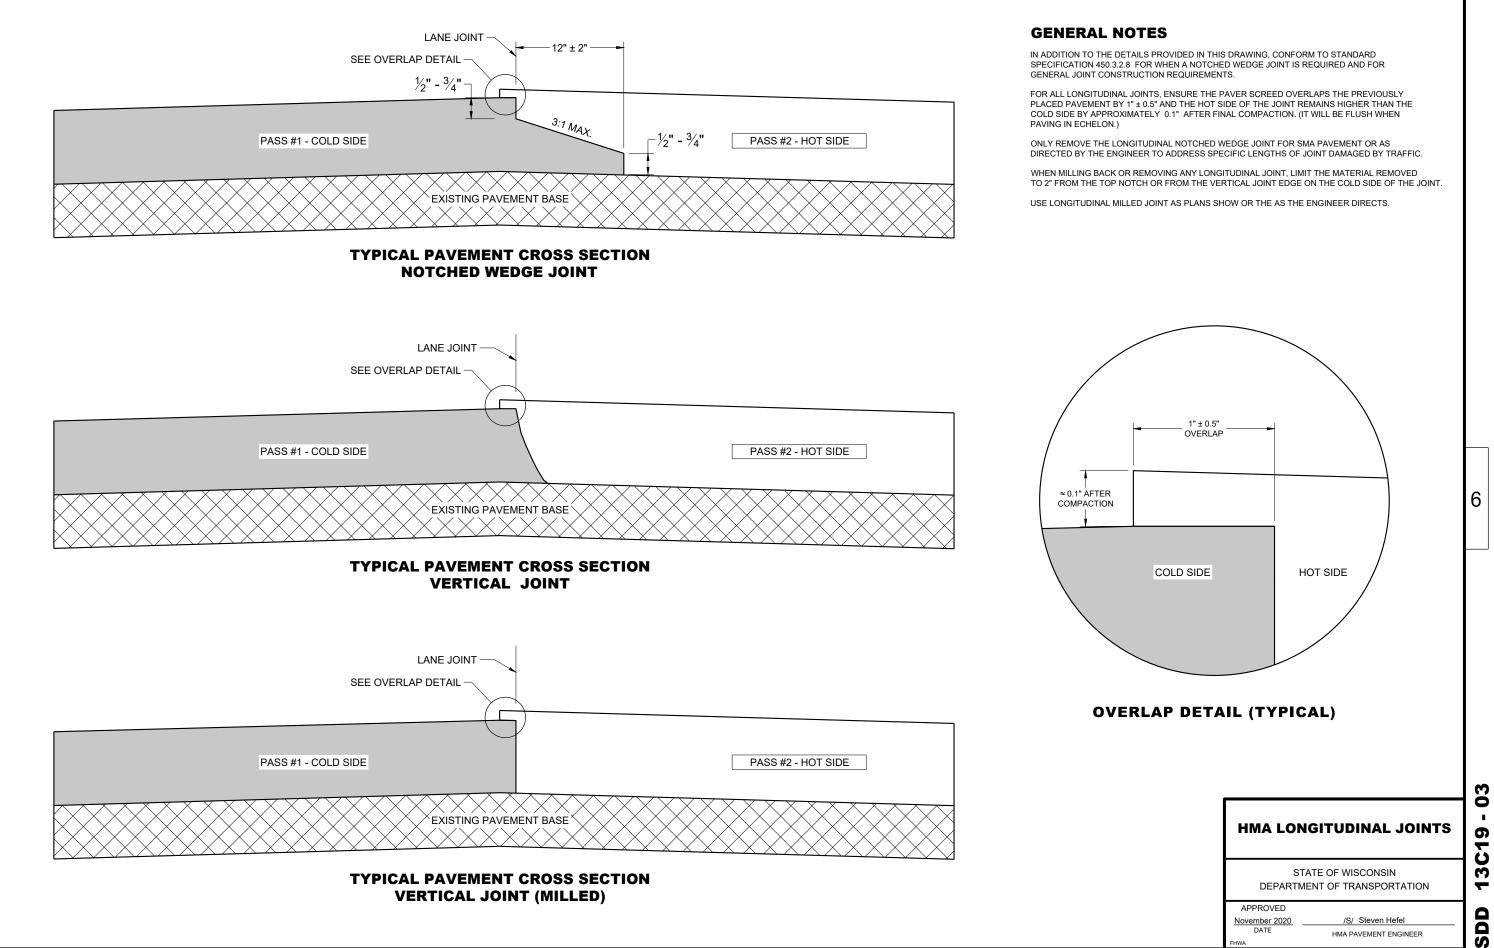

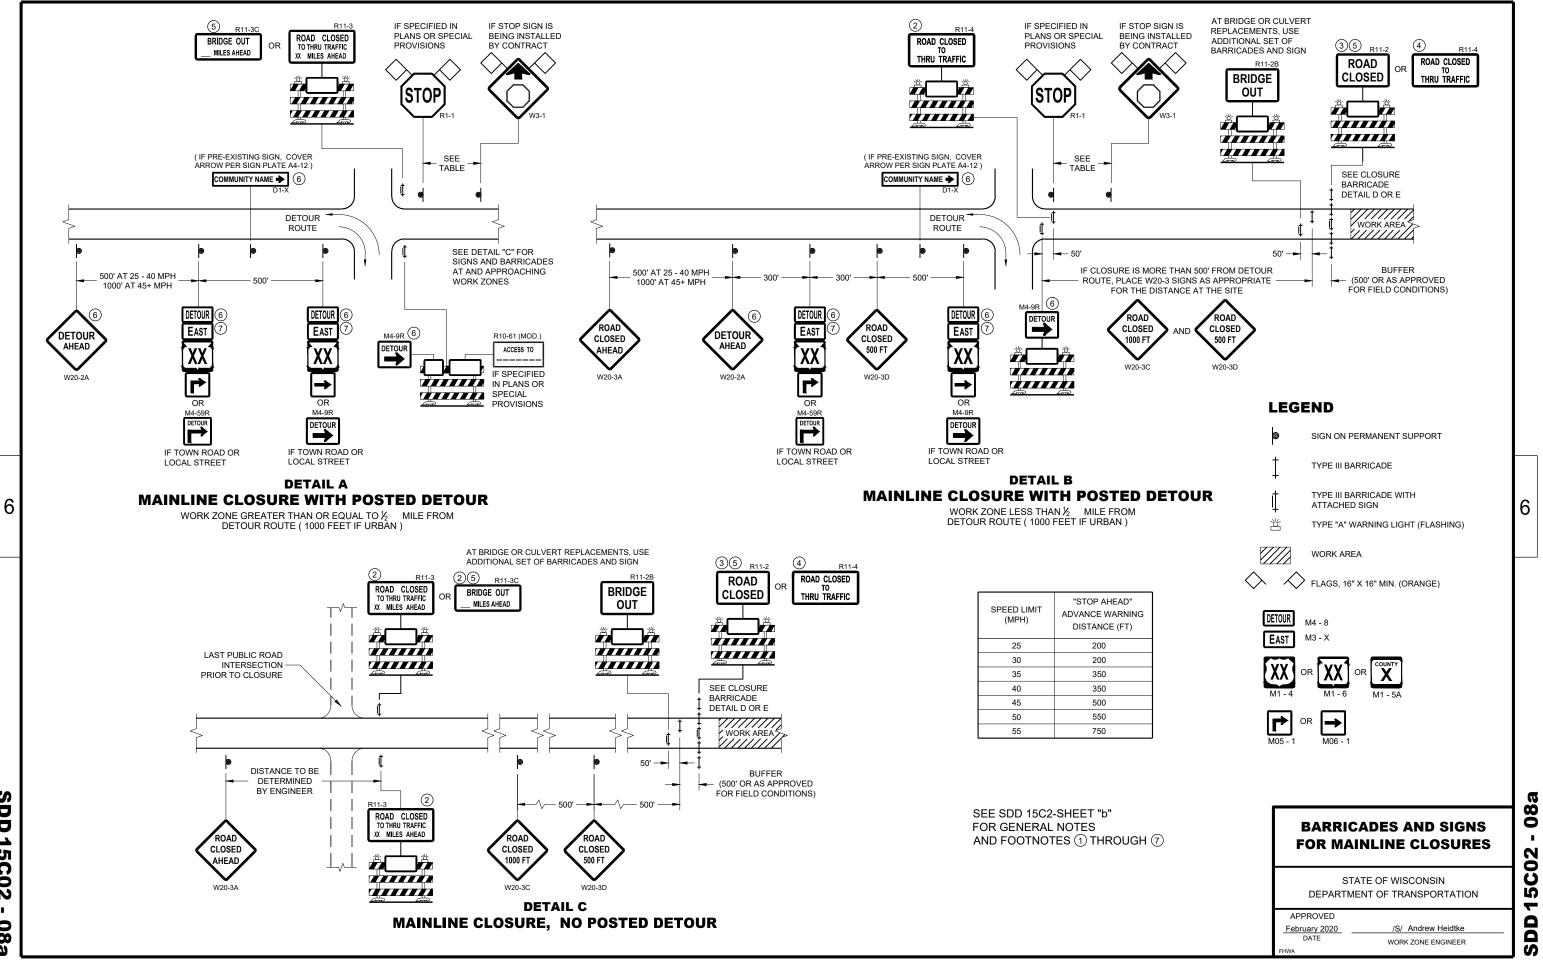

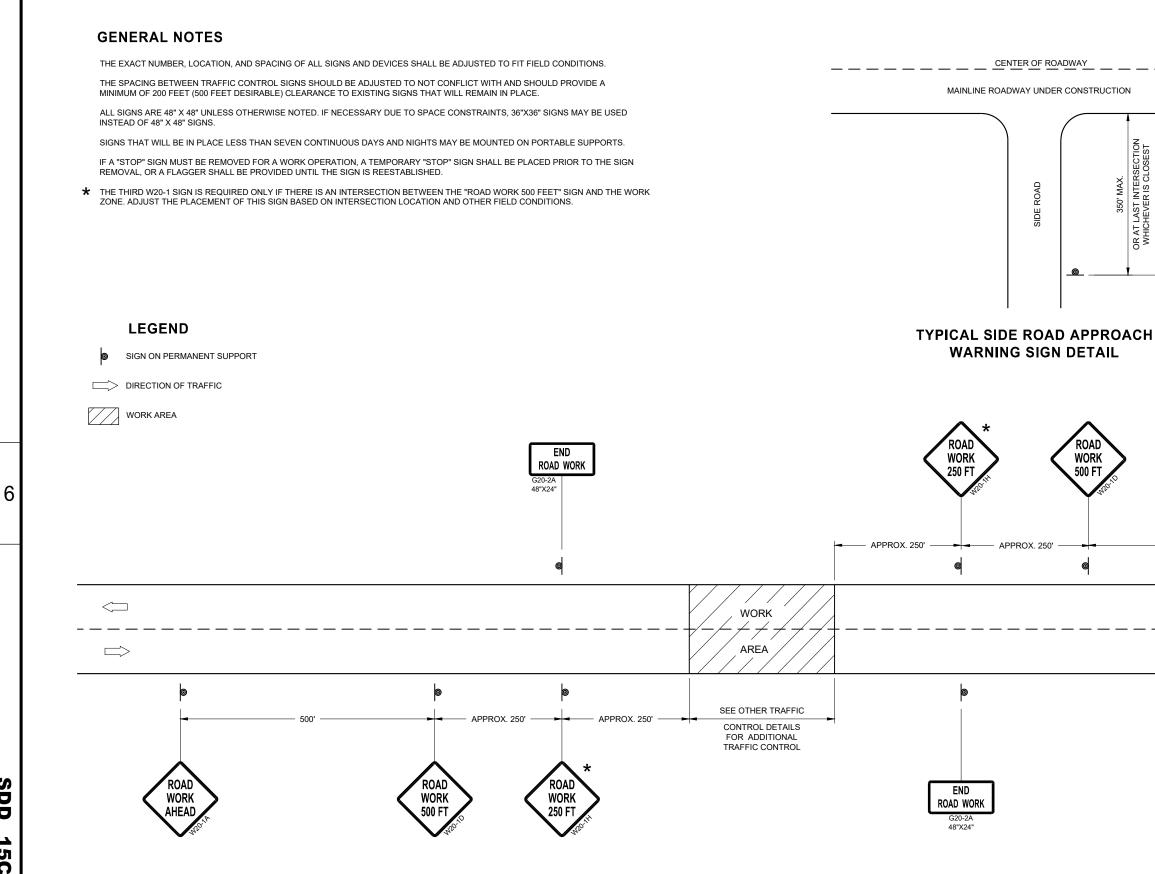



TRAFFIC CONTROL, ADVANCE WARNING SIGNS 40MPH OR LESS

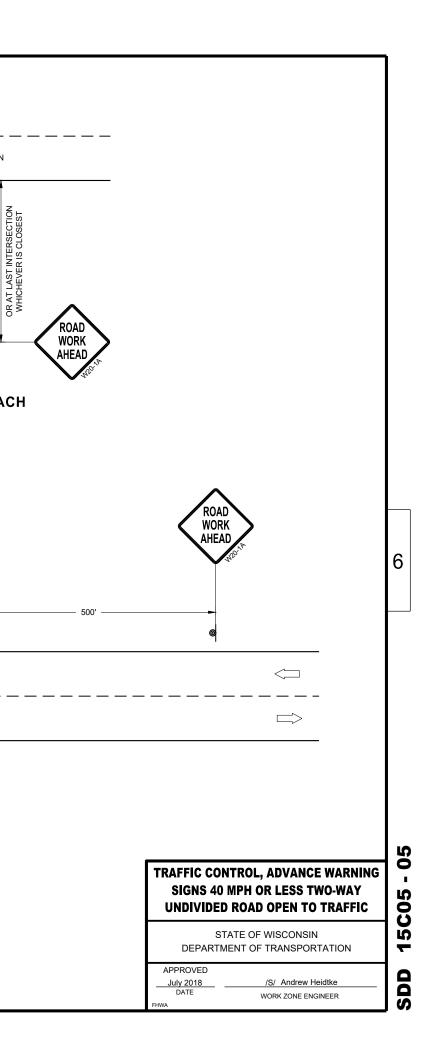

GENERAL NOTES


- (2) LOCATION OF WARNING LIGHTS WHEN SHOWN ON THE PLAN.

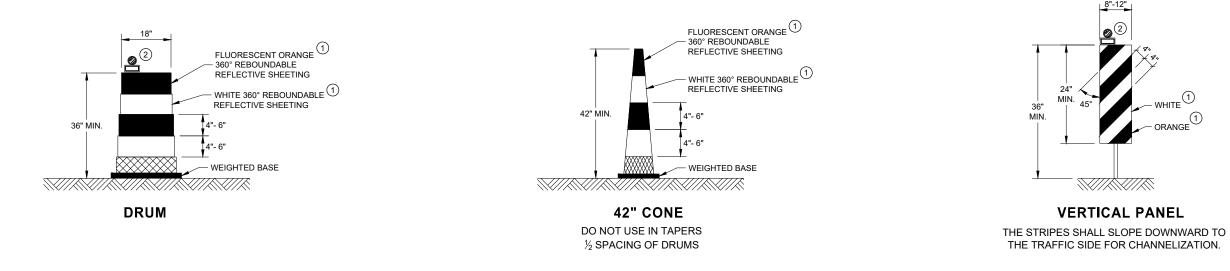

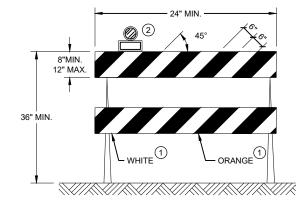

TYPE II BARRICADE

FOR RAILS LESS THAN 36" LONG, 4" WIDE STRIPES MAY BE USED. ALL STRIPES SHALL SLOPE DOWNWARD TO THE TRAFFIC SIDE FOR CHANNELIZATION.

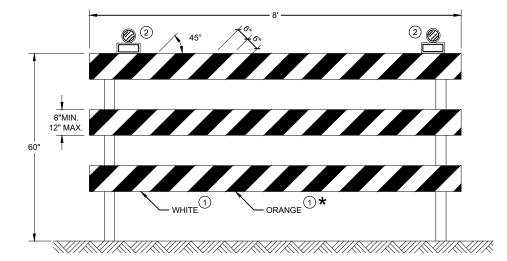

TYPE III BARRICADE

IF SIGN MOUNTED, DO NOT COVER MORE THAN 50% OF THE TOP TWO RAILS OR 33% OF THE TOTAL AREA OF THE THREE RAILS.

★ IF USED FOR A PERMANENT APPLICATION USE RED SHEETING.

(1) REFLECTIVE SHEETING SHALL FOLLOW THE REQUIREMENTS IN THE APPROVED PRODUCTS LISTING FOR SIGN SHEETING.


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CHANNELIZING DEVICES DRUMS, CONES, BARRICADES AND VERTICAL PANELS

STATE OF WISCONSIN DEPARTMENT OF TRANSPORTATION

APPROVED May 2021 DATE

/S/ Andrew Heidtke WORK ZONE ENGINEER

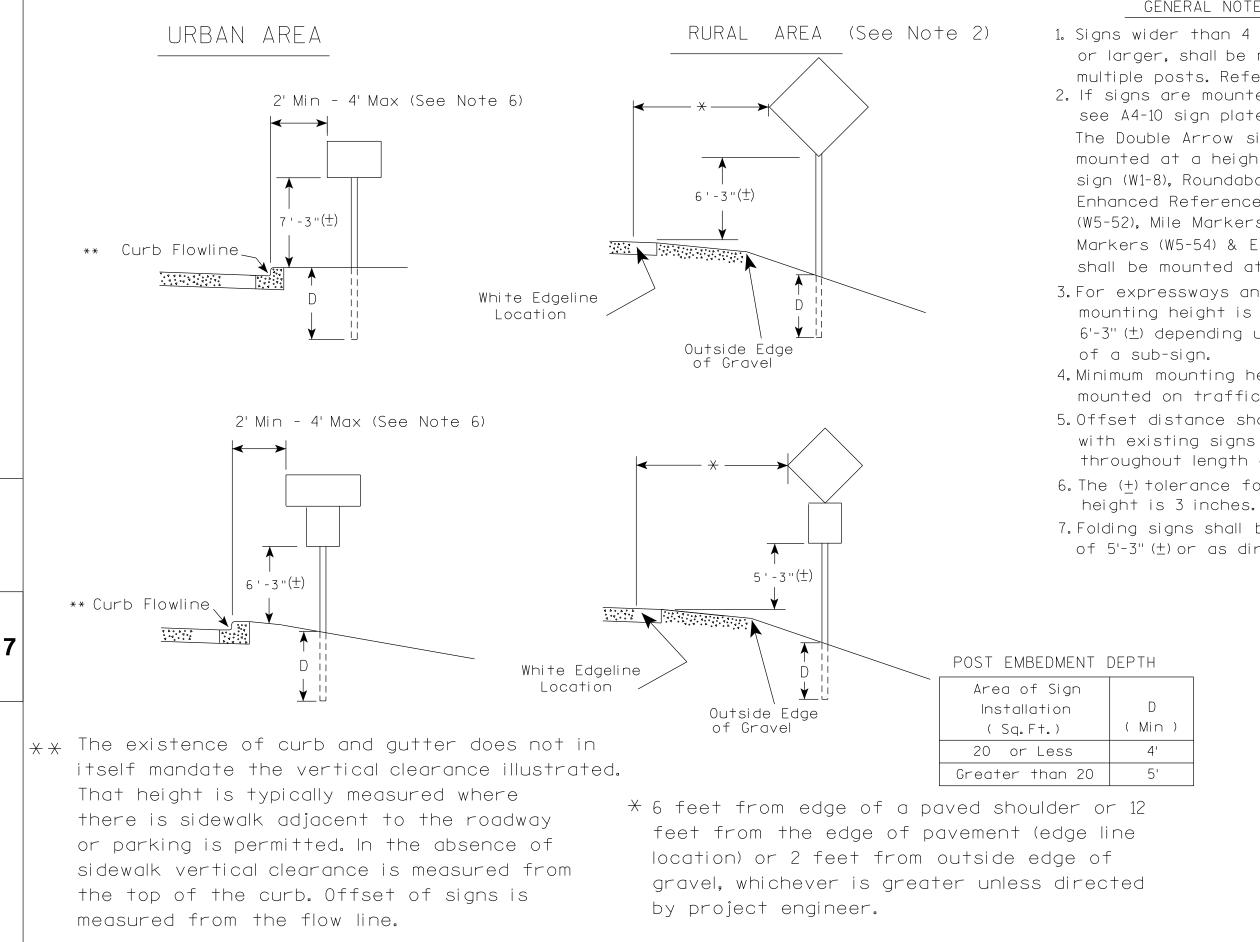



PROJECT NO:	HWY:	COUNTY:			
			DI AT DITE : 47 HUN 0000 4 4	DI OT DY IN IO	DLOT NAME -

GENERAL NOTES

1. Signs wider than 4 feet or 20 sq.ft or larger, shall be mounted on multiple posts. Refer to plate A4-4. 2. If signs are mounted on or behind barrier wall. see A4-10 sian plate. The Double Arrow sign (W12-1D) shall be mounted at a height of $2'-3''(\pm)$. The Chevron sign (W1-8), Roundabout Chevron panel (R6-4B), Enhanced Reference Markers, Clearance Markers (W5-52). Mile Markers (D10 series). In Road Object Markers (W5-54) & End of Road Markers (W5-56) shall be mounted at a height of 4'-3'' (+). 3. For expressways and freeways, mounting height is 7'- 3" (\pm) or $6'-3''(\pm)$ depending upon existence 4. Minimum mounting height for signs mounted on traffic signal poles is 5' - 3'' (+). 5. Offset distance shall be consistent with existing signs or consistent throughout length of project. 6. The (+) tolerance for mounting 7. Folding signs shall be mounted at a height of 5'-3" (\pm) or as directd by the Engineer.

)	
	TYPICAL INSTALLATION
	OF PERMANENT TYPE II
	SIGNS ON SINGLE POSTS
	WISCONSIN DEPT OF TRANSPORTATION
	APPROVED Matthew & Rauch For state Traffic Engineer
	DATE <u>5/13/202</u> 0 PLATE NO. <u>44-3.22</u>
	SHEET NO: E
PLOT SCALE : \$\$	WISDOT/CADDS SHEET 42

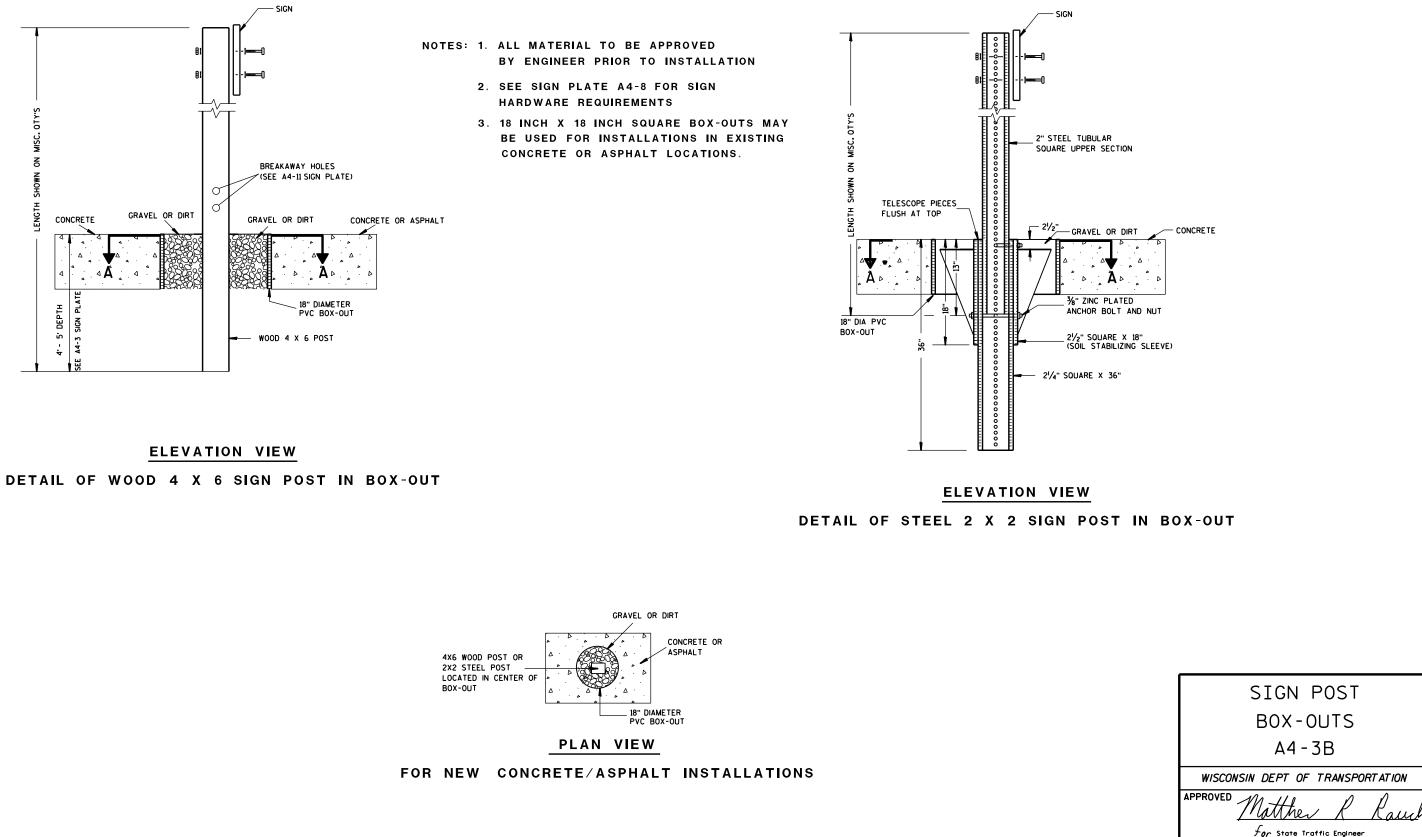

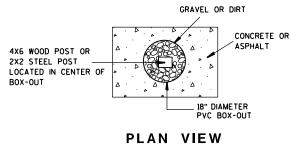


PROJECT NO:	HWY:	COUNTY:				
FILE NAME : C:\CAEFiles\Projects\tr_stdplate\A43B.DGN			PLOT DATE : 27-JAN-2014 09:4	18	PLOT BY : mscsja	PLOT NAME :

DATE <u>1/27/14</u>

SHEET NO:

PLATE NO. <u>A4-3B.1</u>

Ε

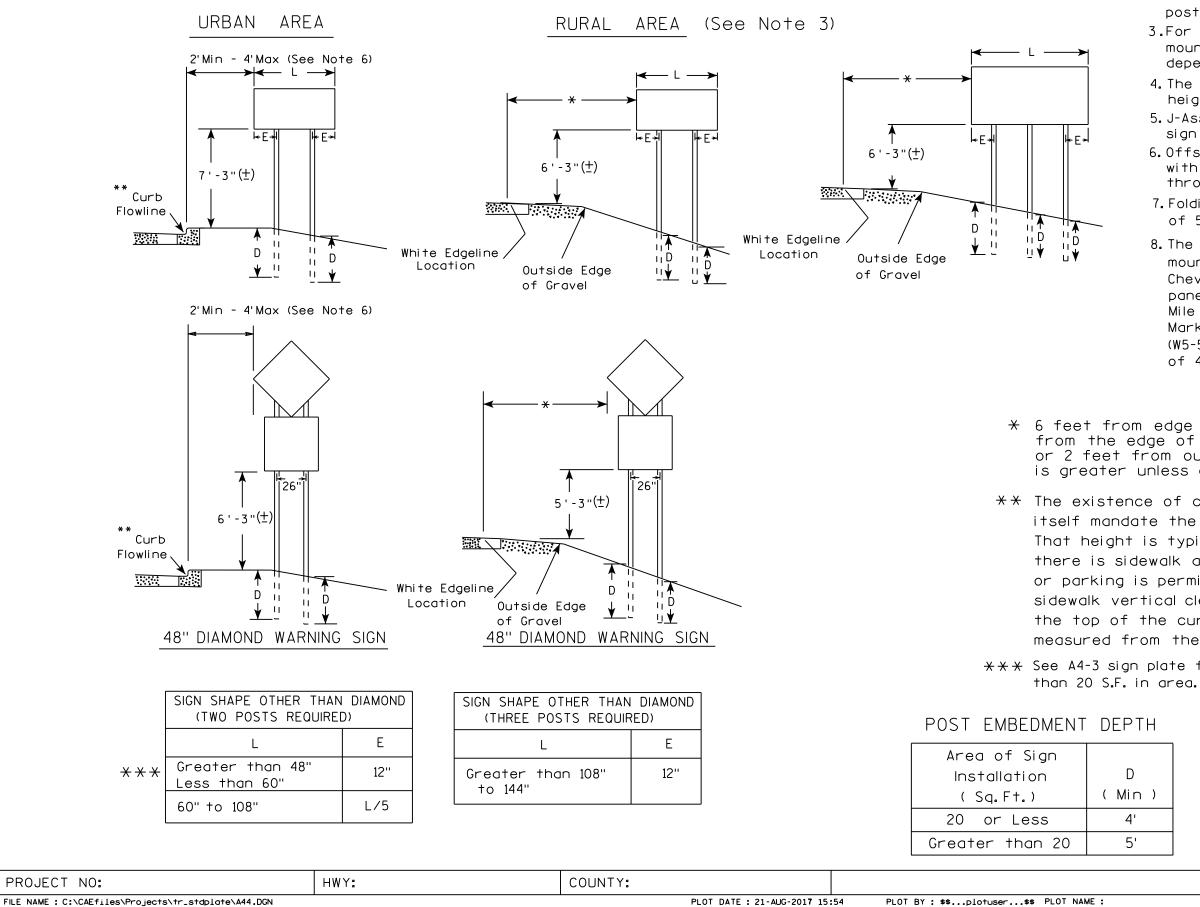

FILE NAME : C:\CAEfiles\Projects\tr_stdplate\A44.DGN

7

GENERAL NOTES

- 1. For 3 or 4 post installations, individual post spacing shall be greater than 3'-6".
- 2. See tables below for required number of posts.
- 3.For expressways and freeways, mounting height is $7'-3''(\pm)$ or $6'-3''(\pm)$ depending upon existence of sub-sign.
- 4. The (±) tolerance for mounting height is 3 inches.
- 5. J-Assemblies are considered to be one sign for mounting height.
- 6. Offset distance shall be consistent with existing signs or consistent throughout length of project.
- 7. Folding signs shall be mounted at a height of 5'-3" (\pm) or as directed by the engineer.
- 8. The Double Arrow sign (W12-1) shall be mounted at a height of 2'-3'' (±). The Chevron sign (W1-8), Roundabout Chevron panel (R6-4B), Clearance Markers (W5-52), Mile Markers (D10 series), In Road Object Markers (W5-54) & End of Road Markers (W5-56) shall be mounted at a height of 4"-3" (±).

* 6 feet from edge of a paved shoulder or 12 feet from the edge of pavement (edge line location) or 2 feet from outside edge of gravel, whichever is greater unless directed by project engineer.


** The existence of curb and gutter does not in itself mandate the vertical clearance illustrated. That height is typically measured where there is sidewalk adjacent to the roadway or parking is permitted. In the absence of sidewalk vertical clearance is measured from the top of the curb. Offset of signs is measured from the flow line.

 \times \times See A4-3 sign plate for signs 4' or less in width and less

H	TYPICAL INSTALLATION OF TYPE II SIGNS ON MULTIPLE POSTS			
)	WISCONSIN DEPT OF TRANSPORTATION			
,	APPROVED Matther & Rauch			
	For State Traffic Engineer			
	DATE 8/21/17 PLATE NO. 44-4.15			
	SHEET NO: E			
DI AT. CA	N F + 100 100007+1 00000			

PLOT SCALE : 108.188297:1.000000

WISDOT/CADDS SHEET 42

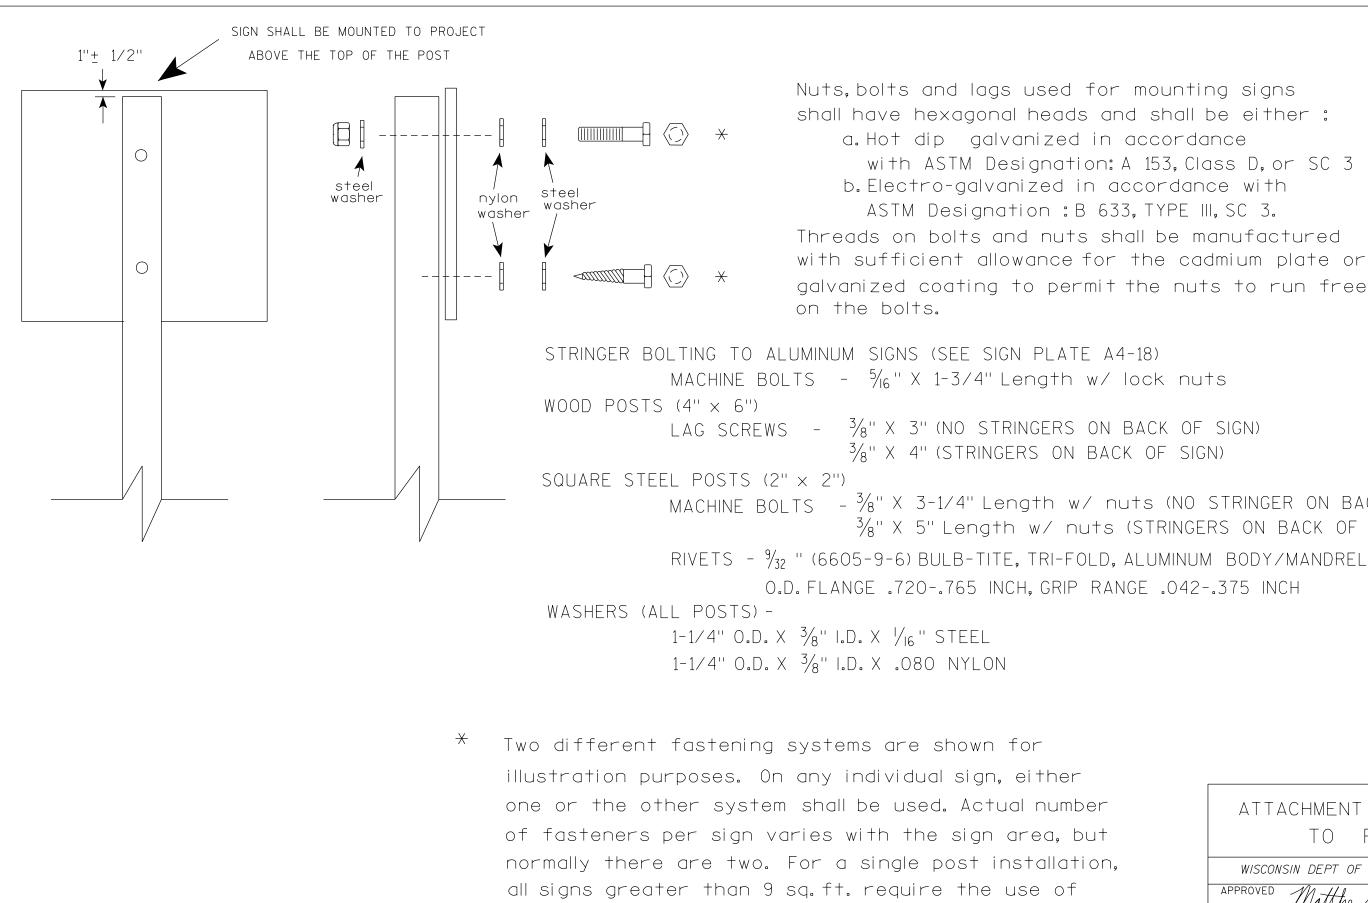


3 fasteners.


Nuts, bolts and lags used for mounting signs shall have hexagonal heads and shall be either : a. Hot dip galvanized in accordance with ASTM Designation: A 153. Class D. or SC 3 b. Electro-galvanized in accordance with ASTM Designation : B 633, TYPE III, SC 3. Threads on bolts and nuts shall be manufactured with sufficient allowance for the cadmium plate or galvanized coating to permit the nuts to run freely

 $\frac{3}{8}$ " X 4" (STRINGERS ON BACK OF SIGN)

MACHINE BOLTS - ³/₈" X 3-1/4" Length w/ nuts (NO STRINGER ON BACK OF SIGN) 3/8" X 5" Length w/ nuts (STRINGERS ON BACK OF SIGN)

ATTACHMENT OF SIGNS TO POSTS
WISCONSIN DEPT OF TRANSPORTATION
APPROVED Matthew R Rauch
Tor State Traffic Engineer
DATE <u>4/1/202</u> 0 PLATE NO. <u>A4-8.9</u>
SHEET NO: E

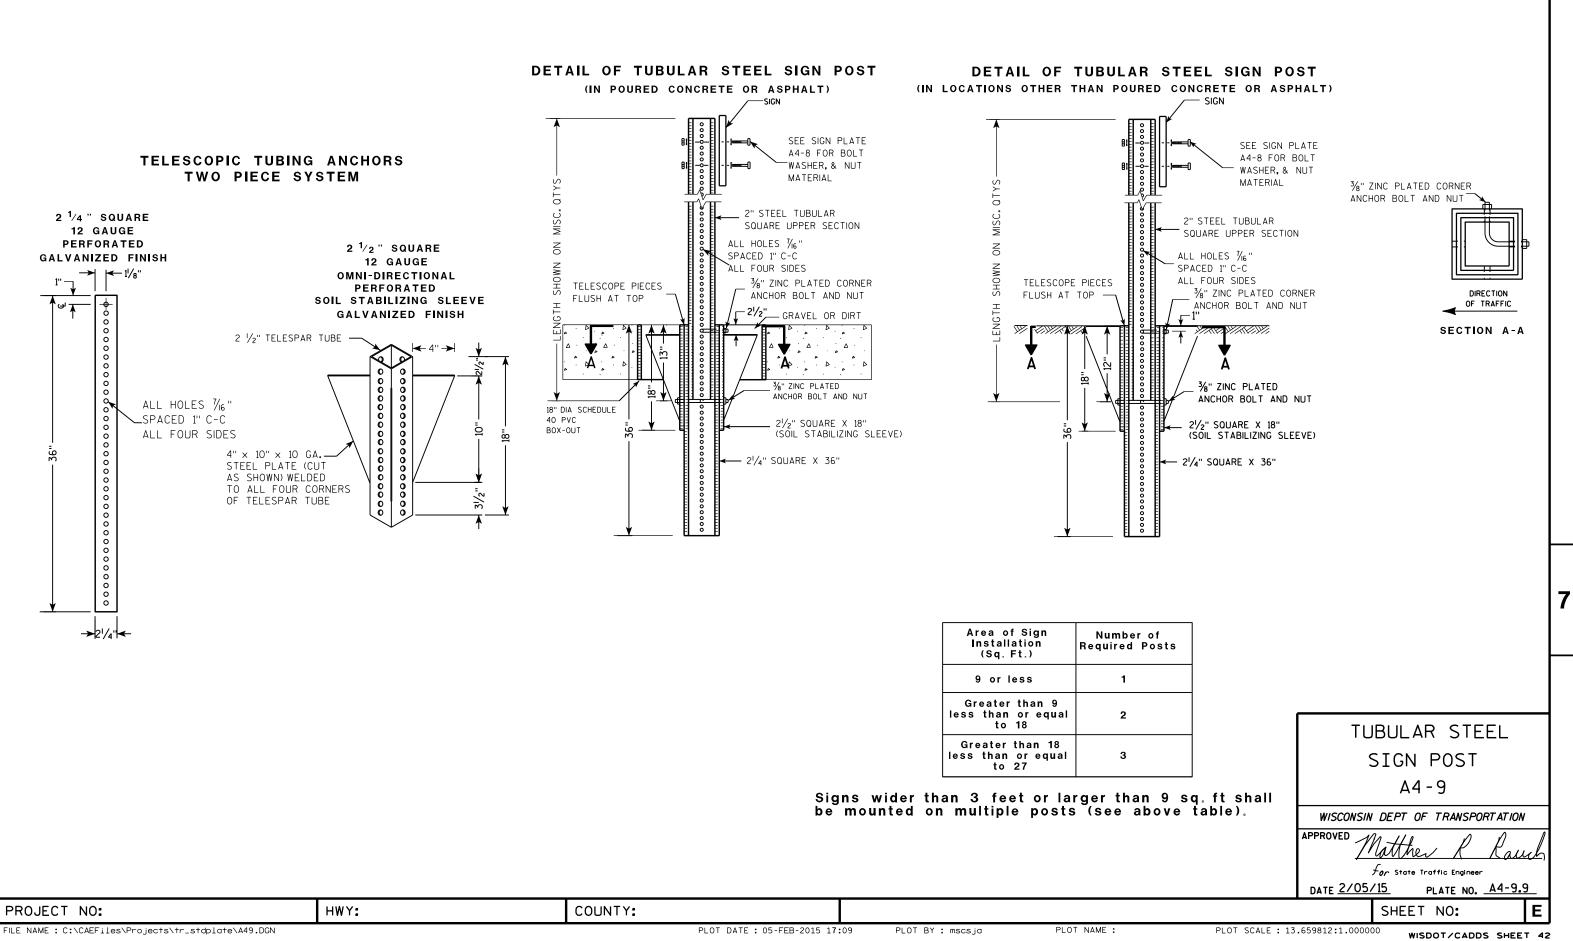

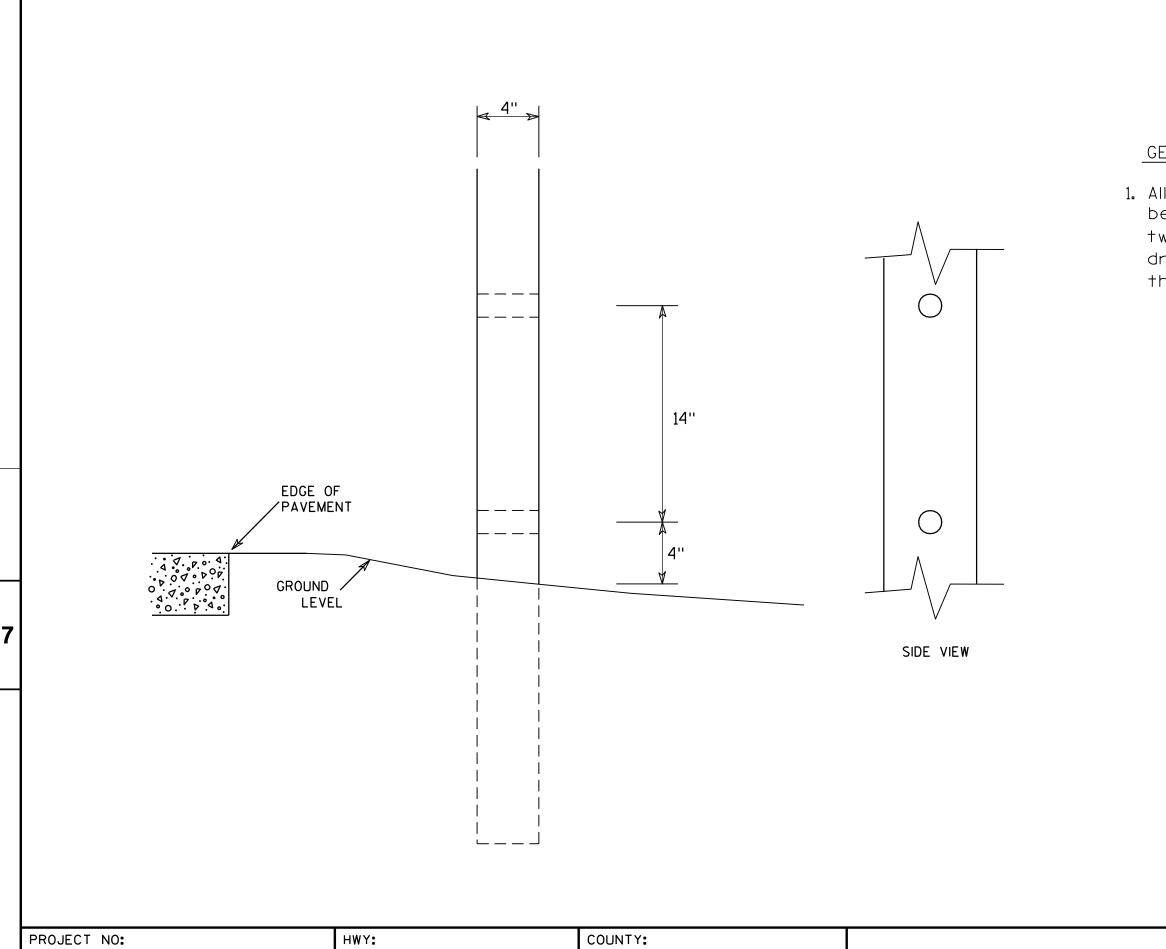


FILE NAME : C:\Users\Projects\tr_stdplate\A411.DGN

GENERAL NOTES

1. All 4 x 6 Wood Posts shall be modified by having two $1\frac{1}{2}$ " diameter holes drilled perpendicular to the roadway centerline.

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	MODIFICATIONS							
	WISCONSIN DEPT OF TRANSPORTATION							
	APPROVE	D	Ine	iter \	Γź	Span		_
	for State Traffic Engineer							
	DATE 3	/27/9	7	PLA	TE N	A4- 1	11.2	_
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NOTES

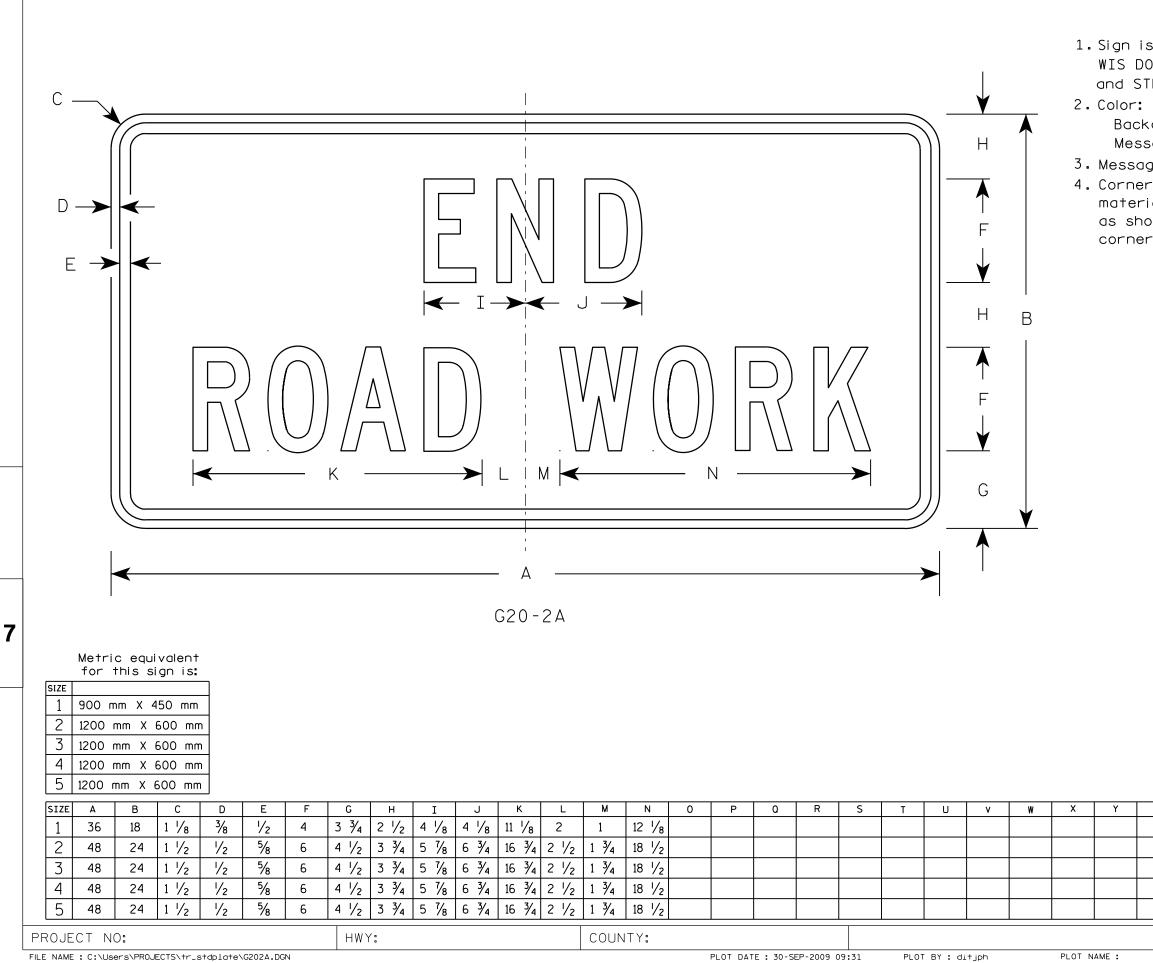1. Sign is Type II - Type F Reflective - reference WIS DOT Standard Specification for HIGHWAY and STRUCTURE CONSTRUCTION latest edition.

Background - Orange Message - Black 3. Message Series - C 4. Corners may be square or rounded when base material is plywood but borders shall be rounded as shown. When base material is metal, the corners and borders shall be rounded.

Z Area Area sa.ft. m2				STANDARD SIGN				
-	4 . 5	0.41		G20-2A				
	8.0	0.72		WISCONSIN DEPT OF TRANSPORTATION				
	8.0	0.72		APPROVED	M.#	er R	0 1	
	8.0	0.72				te Traffic Engin		—
	8.0	0.72		DATE <u>9/3</u>		PLATE NO.		<u>.8</u>
SHEET NO: E							Ε	
	F	PLOT SCA	LE : 5.5617	73:1.000000) WISE	OT/CADDS	SHEET	42

					1. s 2. 3.
		ROAD		→ V S K T →	4.
				W20-1D	
				M20-1C	
,		W20-1A		W20-1B	->-
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3 3/4 5 1/8 15 3/8 11 1/8 12 1/8 14 3/8 1 5/8

PROJECT NO:

5

48

7

FILE NAME : C:\CAEfiles\Projects\tr_stdplate\W201.DGN

2 1/4

3/4

8

1

PLOT DATE : 25-MARCH-2020

13 7/8 4 3/8


3 7/8

3

6 7/8 5 3/8


PLOT BY : dotc4c

8 5/8 13 3/4 2 1/8

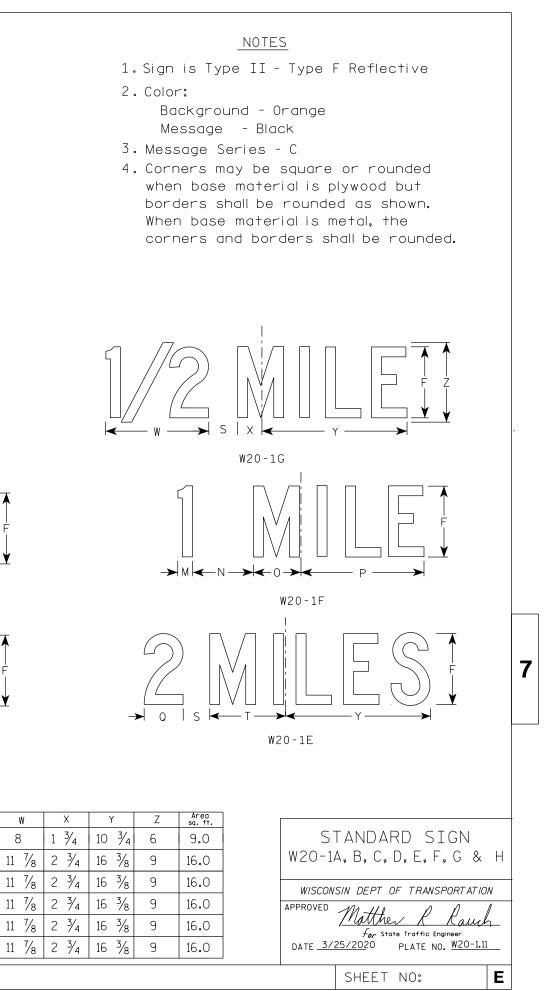

WISDOT/CADDS SHEET 42

Notes

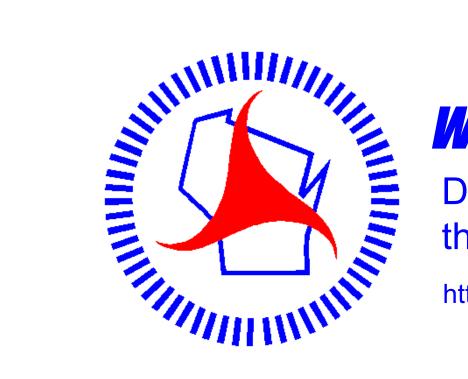

Wisconsin Department of Transportation

Dedicated people creating transportation solutions through innovation and exceptional service.

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